PHARR-SAN JUAN-ALAMO ISD

Purchasing Department

Emily Garza, Director of Purchasing

May 28, 2019

ADDENDUM ACKNOWLEDGEMENT FORM

To Whom It May Concern:

Concerning the *PSJA ISD NORTH ECHS RESTROOM RENOVATIONS AND COLLEGE AND UNIVERSITY CENTER RESTROOMS / SCIENCE LABS RENOVATIONS BID # 18-19-042*, to be opened at 4:00 p.m., Thursday, June 6, 2019. Please consider the following:

Addendum Number:	Description of REVISED Addendum:
2	PLANS / DRAWINGS

For any questions pertaining to these changes, please contact Emily Garza, Director of Purchasing at (956) 354-2000.

Sincerely,

Emily Garya

Emily Garza

Director of Purchasing

With the acceptance of this form, I acknowledge that I have received the above "ADDENDUM ACKNOWLEDGEMENT FORM" for the PSJA ISD NORTH ECHS RESTROOM RENOVATIONS AND COLLEGE AND UNIVERSITY CENTER RESTROOMS / SCIENCE LABS RENOVATIONS BID # 18-19-042, to be opened at 4:00 p.m., Thursday, June 6, 2019. Please include a signed copy of this "ADDENDUM ACKNOWLEDGMENT FORM" with your bid/proposal.

Company Name:	 Authorized Signature:	
Address:	 Authorized Signature (Print):	
City / State / Zip:	 Email:	
Telephone Number:	 Fax Number:	

ADDENDUM NUMBER TWO (2) TO THE PLANS AND SPECIFICATIONS FOR:

NORTH ECHS
AND
COLLEGE & UNIVERSITY CAMPUS
STUDENT RESTROOM RENOVATIONS

PSJA ISD Bid # 18-19-042 Project No. 19.04

GIGNAC & ASSOCIATES 3700 N. 10th STREET, SUITE 205 McALLEN, TEXAS 78501 (956) 686-0100



May 28, 2019

This addendum is generally separated into sections for convenience; however, all contractors, subcontractors, materialmen, and other parties shall be responsible for reading the entire addendum. The failure to list an item or items in all affected sections of this addendum does not relieve any party affected from performing as per instructions, provided that the information is set forth any time, any place in this addendum. These documents shall be attached to and become a part of the contract documents for this project.

PLAN ITEMS:

Item P-1-NORTH

Floorplan/Reflected Ceiling/Enlarged Floorplan/Interior Elevations

Sheets A-110-N thru A-127-N included in this Addendum shall replace their respective sheets in the Contract Documents. Further labeling, dimensions, and clarification was added.

Item P-2-NORTH


Wall Types Sheet


A-140-N (Wall Types) included in this Addendum shall be included as part of the Contract Documents. This sheet is to the support the wall tags added in the Reflected Ceiling Plans in Item P-1.


- 1. DEMOLITION AND PROPOSED WORK WILL HAVE TO BE COORDINATED WITH THE OWNER TO MINIMIZE DISRUPTIONS TO THE CAMPUS, WHICH MAY BE IN USE.
- 2. ANY EXISTING WALLS TO REMAIN THAT REQUIRE REPAIR AFTER DEMOLITION IS COMPLETE, SHALL BE OBSERVED BY THE DESIGN TEAM AND OWNER PRIOR TO REPAIR. COORDINATION WILL BE REQUIRED.
- 3. ANY OPENINGS IN EXISTING WALLS SCHEDULED TO BE INFILLED SHALL HAVE THE SAME MATERIAL AND FINISH AS THAT OF THE EXISTING WALL. ALL INFILLED OPENINGS SHALL BE FLUSH WITH EXISTING WALL SURFACES AND PAINTED.

				HEDULE				
DOOR			DOOR		Ff	RAME	DEMARKO	
SCHEDULE	WIDTH	HEIGHT	TYPE	MATERIAL	TYPE	MATERIAL	REMARKS	
S100A	3'-0"	7′-0″	FL	WD	А	НМ	FIELD VERIFY EXISTING OPENING	
S100B	3'-0"	7′-0″	FL	НМ	А	НМ	FIELD VERIFY EXISTING OPENING	
S101A	3'-0"	7′-0″	FL	WD	А	НМ		
S101B	3'-0"	7′-0″	FL	НМ	Α	НМ	FIELD VERIFY EXISTING OPENING	
S102	3'-0"	7′-0″	FL	WD	Α	НМ		
\$103	3'-0"	7′-0″	FL	WD	Α	НМ		

	ROOM FINISH SCHEDULE											
NUMBER	NAME	FLOOR	BASE	NORTH WALL	SOUTH WALL	EAST WALL	WEST WALL	CEILING	CLG HT.	NOTES		
\$100	BUYS	TILE: UNITY ASH GREY	TILE: UNITY AVORIO/PT	GYP. PTD.	9'-0"							
\$101	GIRLS	TILE: UNITY ASH GREY	TILE: UNITY AVORIO/PT	GYP. PTD.	9'-0"							
\$102	STORAGE	SEALED CONCRETE	NONE	PT	PT	PT	PT	EXP STRUC		PAINT EXPOSED STRUCTURE & DECK		
\$103	JANITOR	SEALED CONCRETE	NONE	PT	PT	PT	PT	EXP STRUC		PAINT EXPOSED STRUCTURE & DECK		

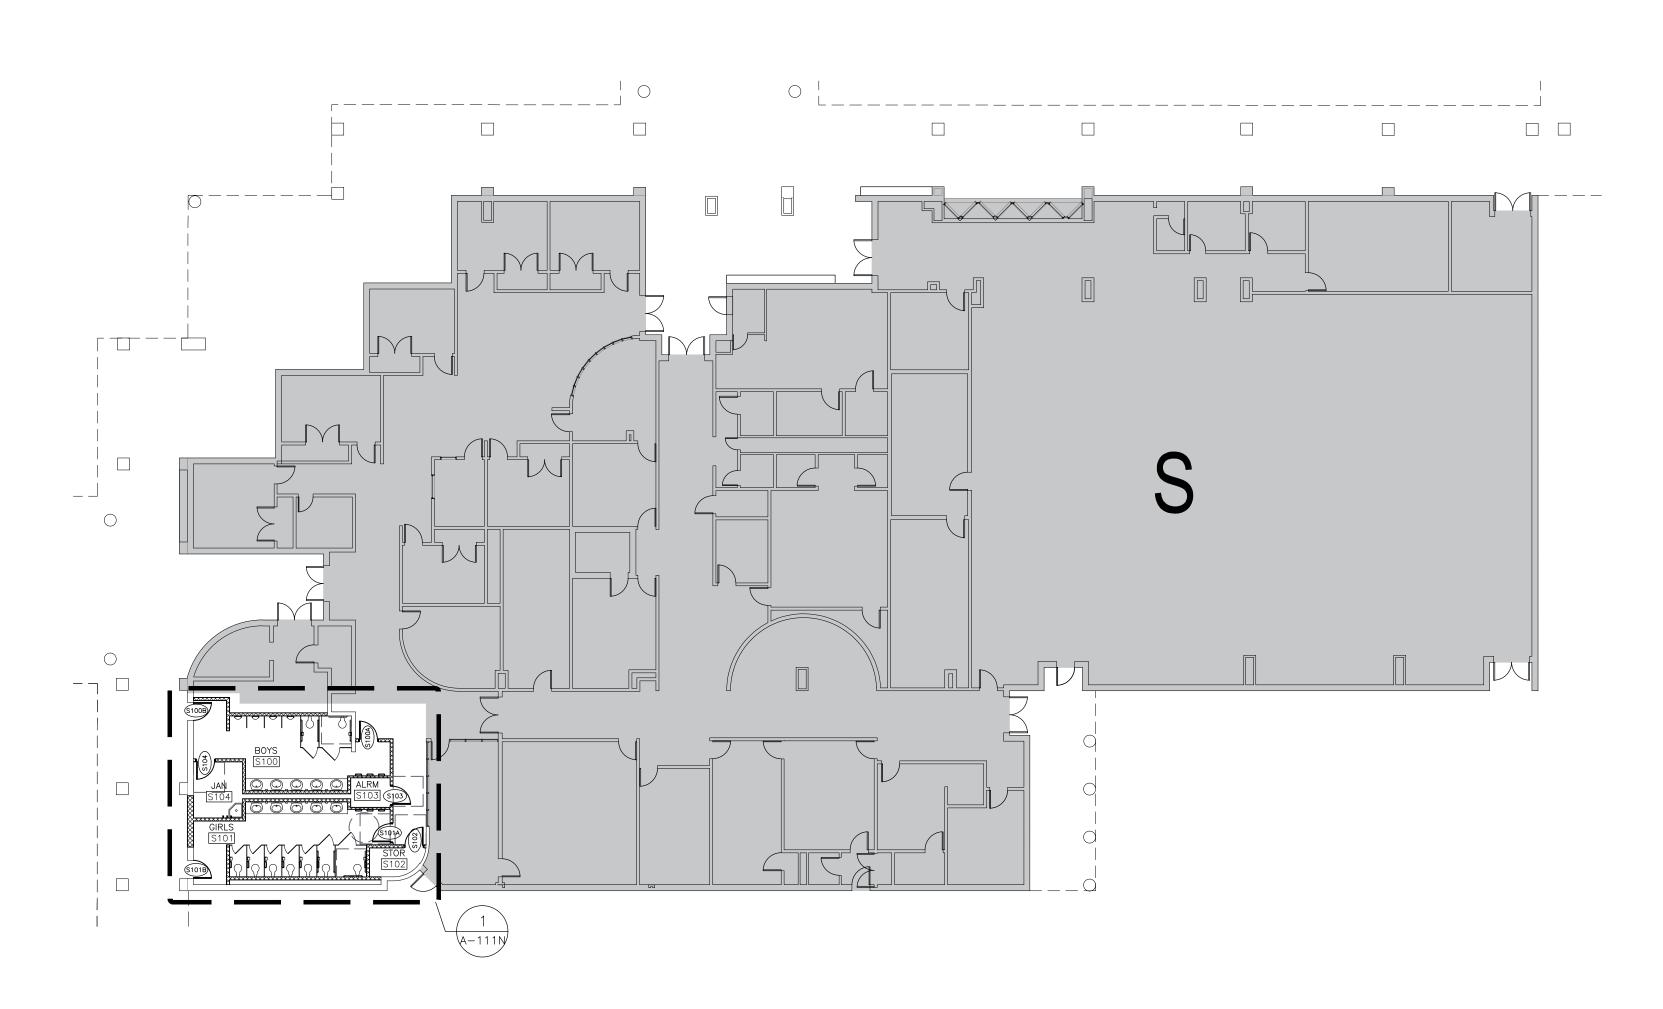

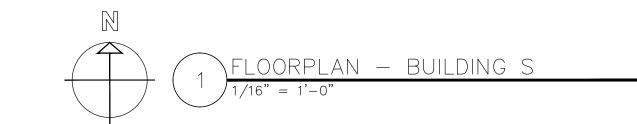

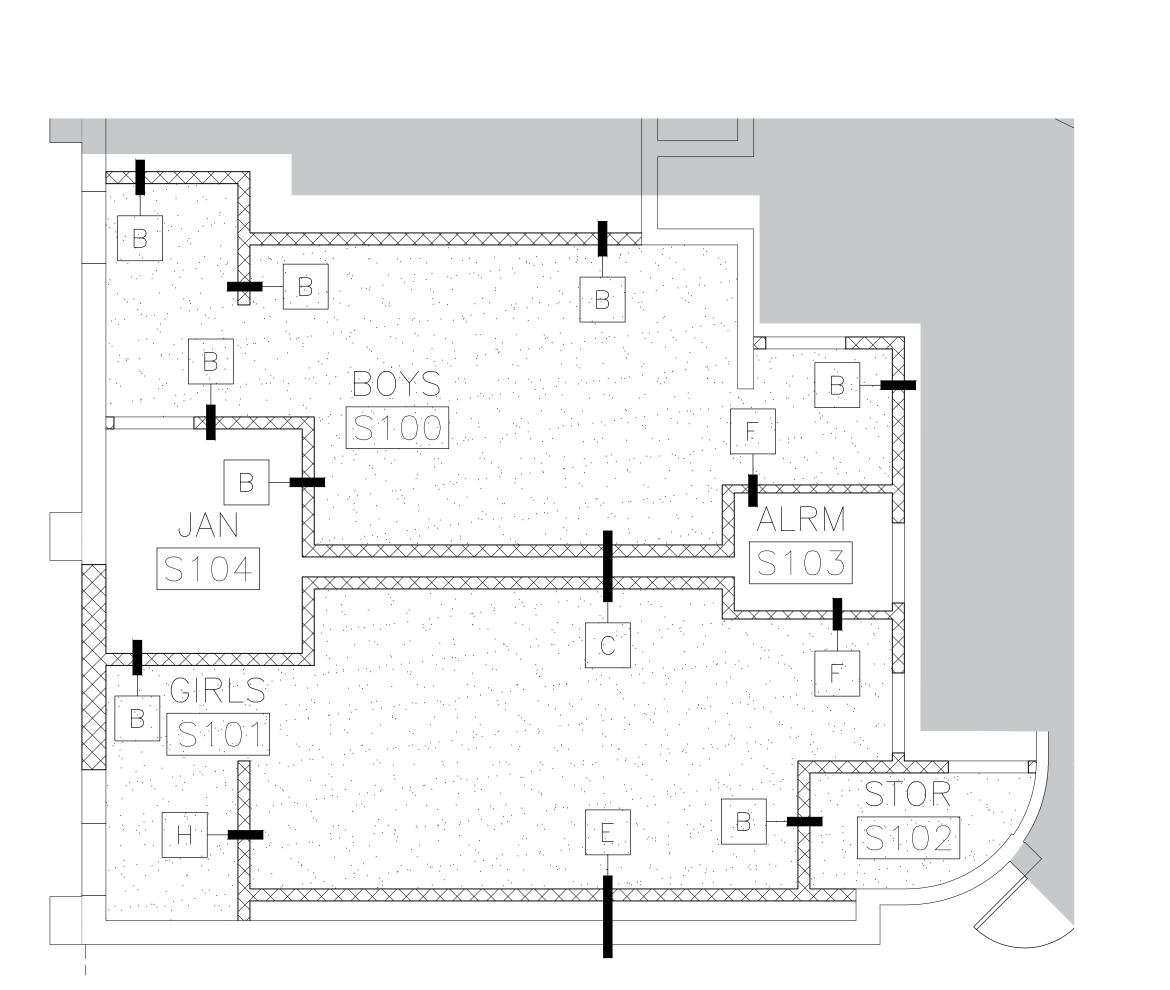





PAINTED GYP. BOARD

EXPOSED STRUCTURE, PAINTED

THIS AREA NOT IN SCOPE

REFLECTED CEILING NOTES:

1. REFER TO MEP DRAWINGS FOR CEILING MOUNTED ITEMS.

2. FIELD VERIFICATION OF EXISTING STRUCTURE AND COORDINATION WITH MEP DURING SUBMITTAL PROCESS SHALL BE REQUIRED IN ORDER TO ACHIEVE MAXIMUM CEILING HEIGHTS.

GIGNAC | ARCHITECTS

416 STARR STREET CORPUS CHRISTI, TEXS 78401 T 361.884.2661 F 361.884.4232

222 E. VAN BUREN, SUITE 102 HARLINGEN, TEXAS 78550

T 956.365.4820


F 956.365.4822 3700 N. 10TH, SUITE 205 McALLEN, TEXAS 78501 T 956.686.0100 F 956.622.7313

Consultants:

MELDEN & HUNT

STRUCTURAL: GREEN, RUBIANO & ASSOCIATES INC.

DBR ENGINEERING

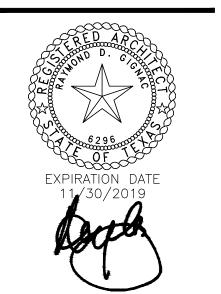



SIGNED: 05/10/2019

PSJA ISD

NORTH ECHS & COLLEGE

UNIVERSITY **CAMPUS**

STUDENT RESTROOM RENOVATIONS



KEYPLAN


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Revisions: <u>1</u> - ADD 1 - 5/24/19


BUILDING S FLOORPLAN & REFL. CLG. PLN.


ADD. 2 A-110-N


	FIXTURE MOUNTING		
	HEIGHT SCHEDULE * REFER TO ADA GUIDELINES ON SHEET G-102.		ADULTS
1	LAVATORIES/SINK	CTANDADD	
1	(MEASURED FROM FLOOR TO RIM)	STANDARD ACCESSIBLE	32" 34" MAX
	O LIDINAL C		(29" MIN KNEESPACE)
2	2. URINALS (MEASURED FROM FLOOR TO RIM)	STANDARD	16" MAX
		ACCESSIBLE	17" MAX
3	WATER CLOSETS (MEASURED FROM FLOOR TO TOP OF SEAT)	STANDARD	15"
		ACCESSIBLE	17" TO 19"
4	4. DRINKING FOUNTAINS AND EWC'S FRONTAL APPROACH	STANDARD	42"
	(MEASURED FROM FLOOR TO SPOUT OUTLET)	ACCESSIBLE	36" MAX (27" MIN KNEESPACE)
	5. GRAB BARS	STANDARD	
5	(MEASURED FROM FLOOR TO CENTERLINE OF BAR — 36" LONG @ REAR WALL & 42" LONG @ SIDE WALL OR 90 DEGRESS CONT. GRAB BAR WHERE INDICATED	ACCESSIBLE	33" TO 36" TO TOP OF GRAB BAR
	6. TOILET TISSUE DISPENSER	STANDARD	20"
6	(MEASURED FROM FLOOR TO CENTERLINE OF ROLL)	ACCESSIBLE	19" MIN
	7. ELECTRIC HAND DRYER	STANDARD	48"
	(MEASURED FROM FLOOR TO CENTER OF CONTROL)	ACCESSIBLE	45" MAX
8	8. SOAP DISPENSER	STANDARD	38"
0	(MEASURED FROM FLOOR TO CENTERLINE OF PUSH BUTTON)	ACCESSIBLE	38"
	9. SANITARY NAPKIN DISPOSAL UNIT	STANDARD	40"
9	(MEASURED FROM FLOOR TO TOP OF UNIT) (ONLY IN ROOMS LABELED WOMEN & GIRLS)	ACCESSIBLE	
10	10. MIRRORS	STANDARD	
	1 MIRROR PER LAVATORY (NOT NOTED FOR CLARITY). MEASURED FROM FLOOR TO	ACCESSIBLE	40" MAX
	BOTTOM OF REFLECTING SURFACE.		
11	11. MOP BASIN / SERVICE SINK (ONE PER ROOM LABELED CUSTODIAN)		
12	12. MOP HOLDER (ONE PER ROOM LABELED CUSTODIAN)		48" MAX
13	13. TOILET PARTITION / URINAL SCREEN	NOT NOTE) FOR CLARITY



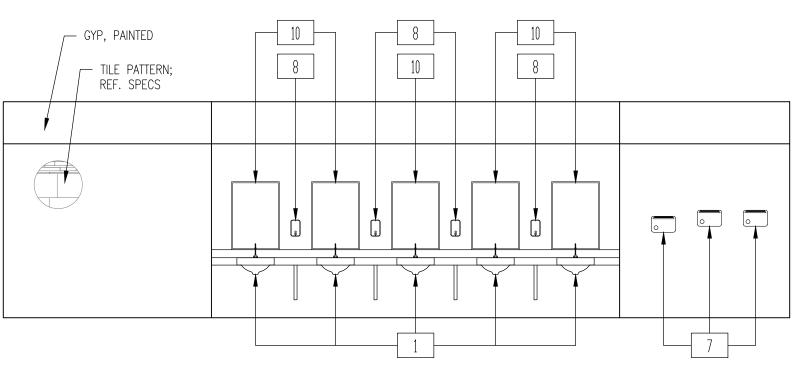


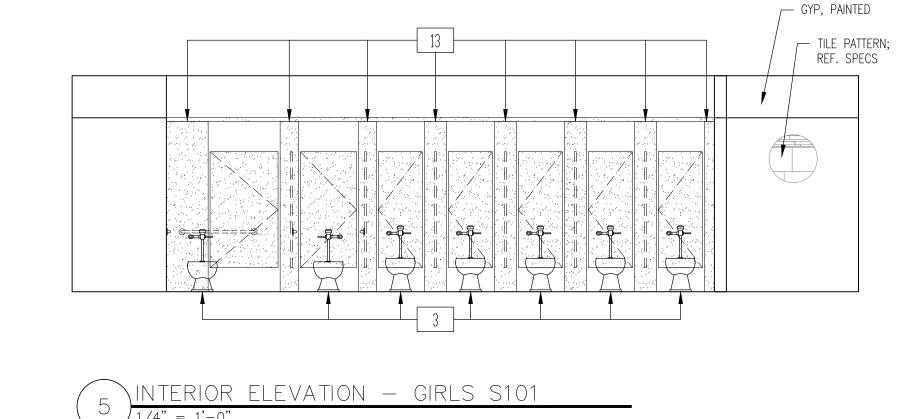

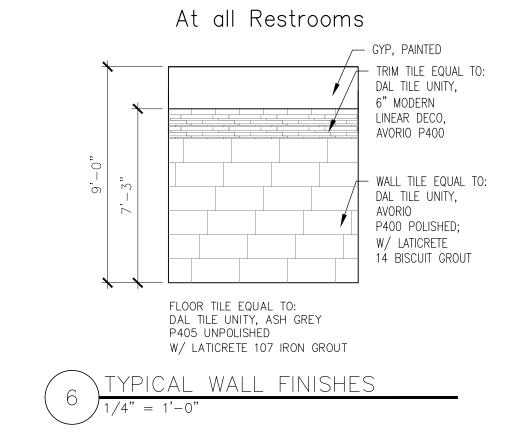


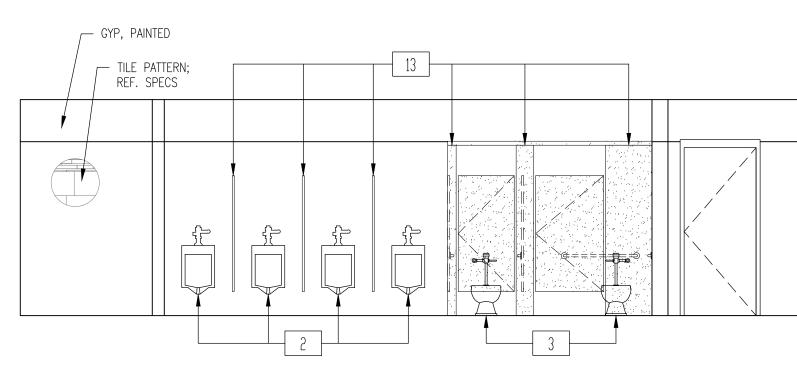




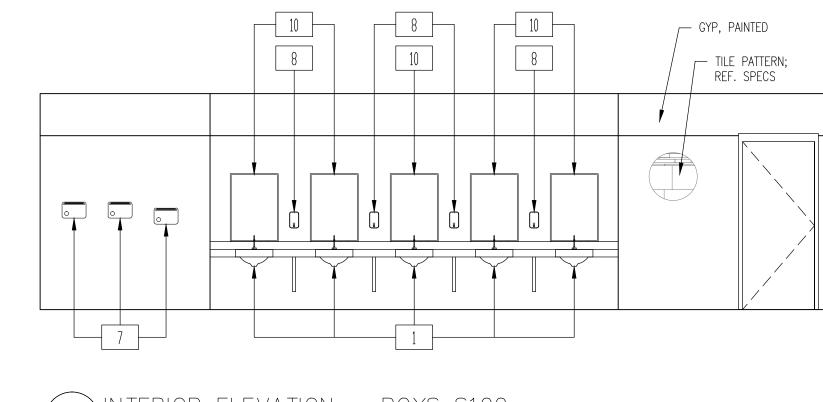



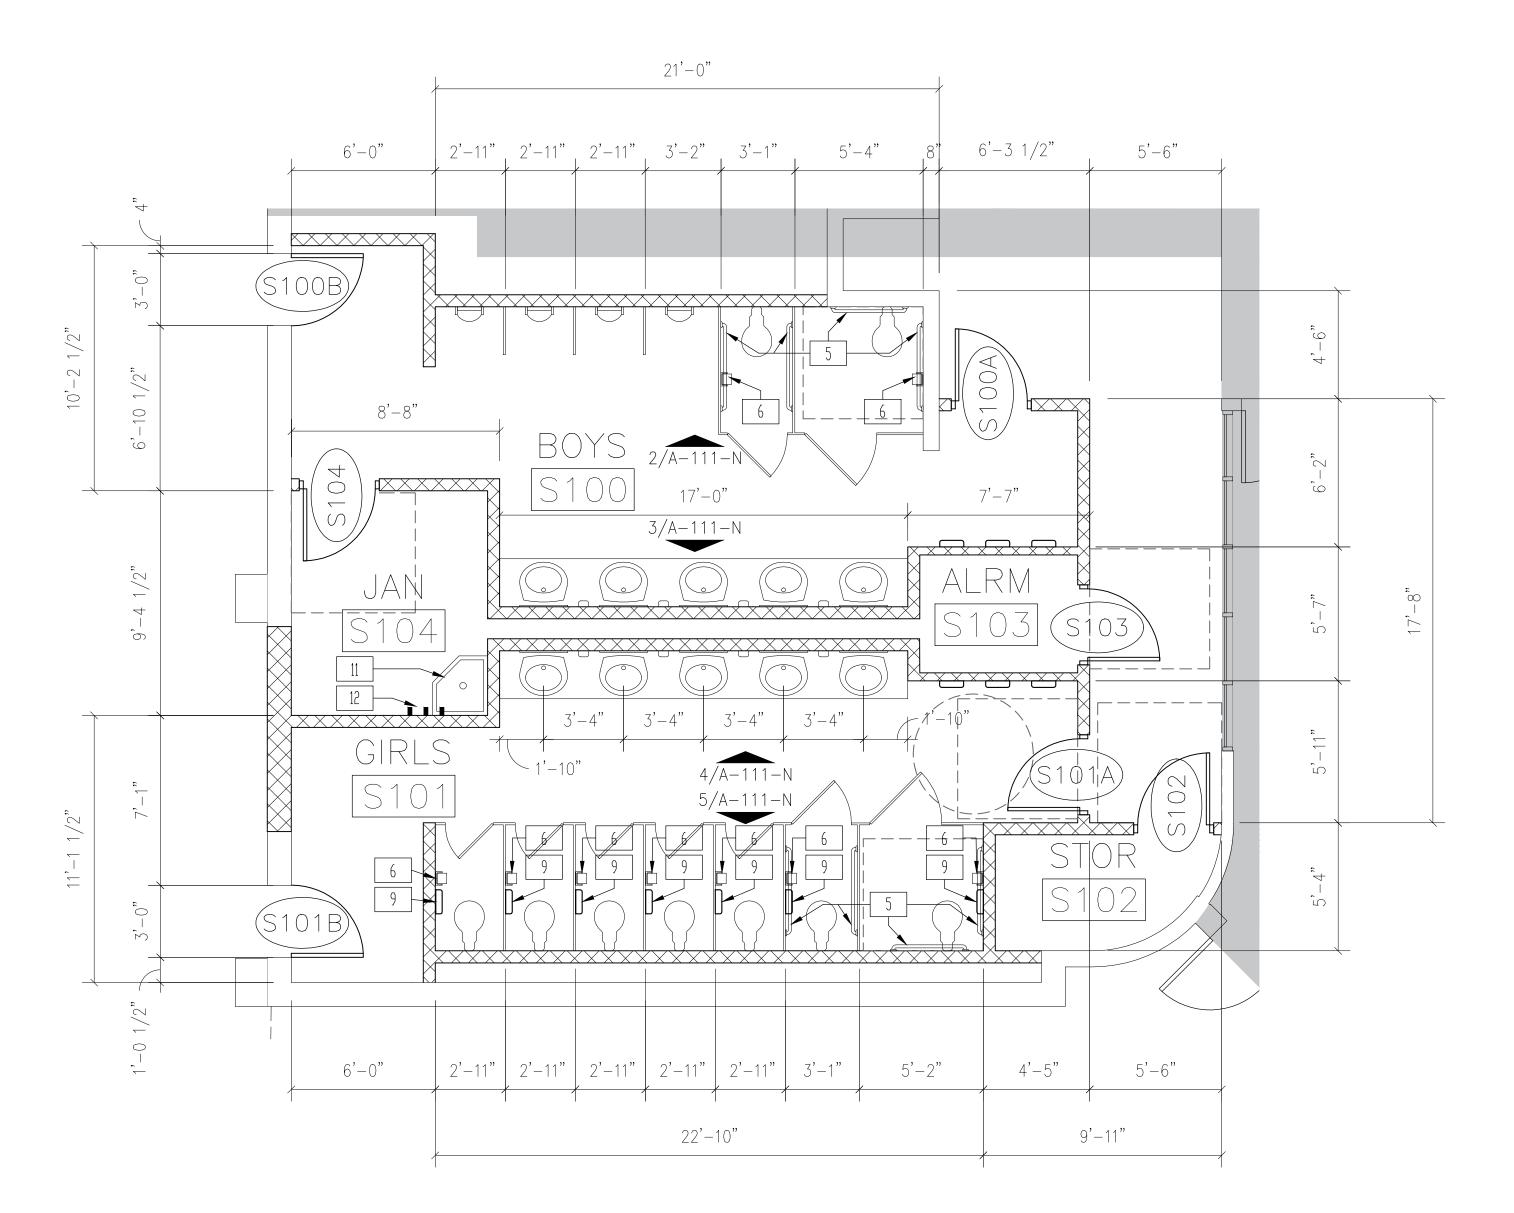



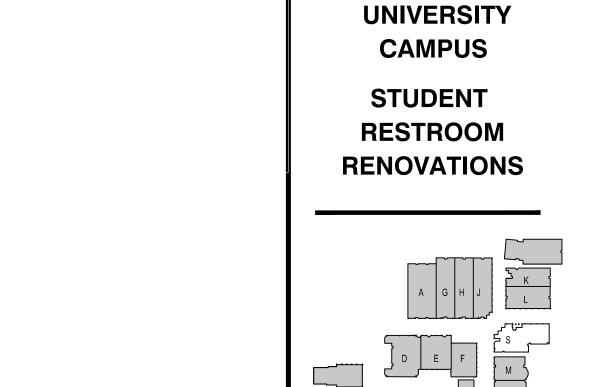

KEYPLAN

GIGNAC | ARCHITECTS

416 STARR STREET CORPUS CHRISTI, TEXS 78401 T 361.884.2661 F 361.884.4232

222 E. VAN BUREN, SUITE 102 HARLINGEN, TEXAS 78550 T 956.365.4820 F 956.365.4822

3700 N. 10TH, SUITE 205 MCALLEN, TEXAS 78501 T 956.686.0100

F 956.622.7313

Consultants:

MELDEN & HUNT

GREEN, RUBIANO &

DBR ENGINEERING

EXPIRATION DATE 11/30/2019

SIGNED: 05/10/2019

COLLEGE³
READY.CONNECTED.COMPLETE TO

PSJA ISD

NORTH ECHS

& COLLEGE

ASSOCIATES INC.

STRUCTURAL:

Project Number: 19.04
Drawing Date: MAY 10, 2019
Drawn: CQ
Checked: JM
Scale: VARIES
ACAD File: DEMO PLAN

Revisions:
1 - ADD 1 - 5/24/19

<u>/1\</u> - ADD 1 - 5/24/13

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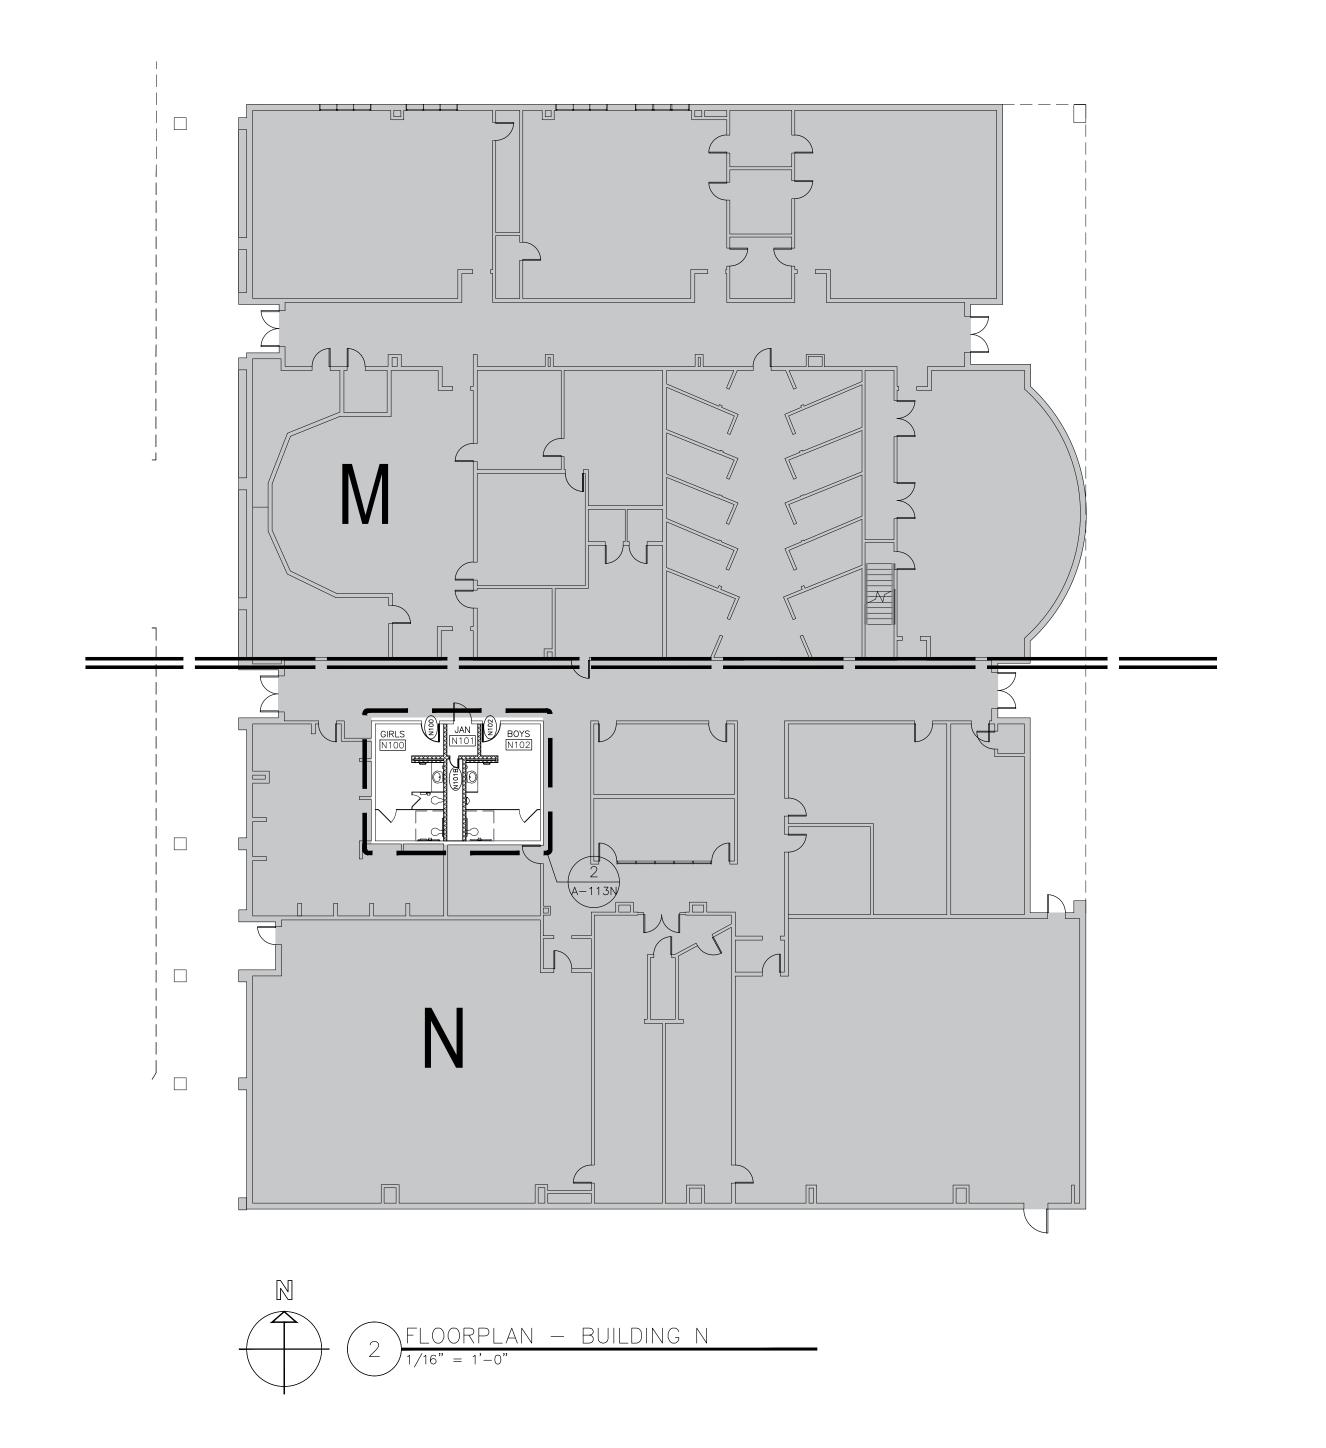
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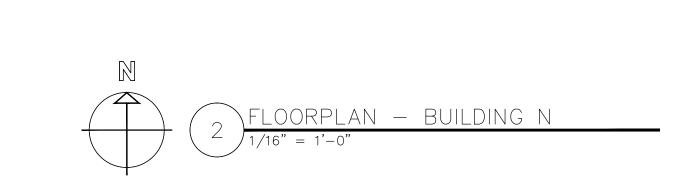
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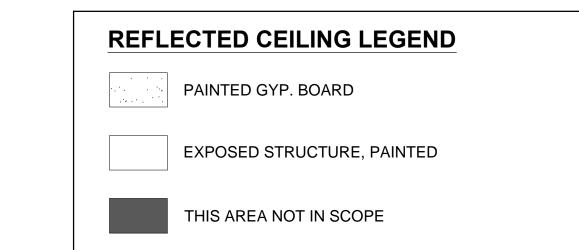
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DOOR SCHEDULE										
DOOR			DOOR		FF	RAME				
SCHEDULE	WIDTH	HEIGHT	TYPE	MATERIAL	TYPE	MATERIAL	REMARKS			
N100	3'-0"	7′-0″	FL	WD	А	НМ	FIELD VERIFY EXISTING OPENING			
N101B	1'-6"	7′-0″	FL	WD	А	MH				
N102	3'-0"	7′-0″	FL	WD	А	НМ	FIELD VERIFY EXISTING OPENING			


	ROOM FINISH SCHEDULE											
NUMBER	NAME	FLOOR	BASE	NORTH WALL	SOUTH WALL	EAST WALL	WEST WALL	CEILING	CLG HT.	NOTES		
N100	GIRLS	TILE: UNITY ASH GREY	TILE: UNITY AVORIO/PT	GYP. PTD.	9'-0"							
N101	JANITOR	SEALED CONCRETE	NONE	PT	PT	PT	PT	EXP STRUC		PAINT EXPOSED STRUCTURE & DECK		
N102	BOA2	TILE: UNITY ASH GREY	TILE: UNITY AVORIO/PT	GYP. PTD.	9'-0"							







COORDINATION WITH MEP DURING SUBMITTAL PROCESS SHALL BE REQUIRED IN ORDER TO ACHIEVE MAXIMUM CEILING HEIGHTS.

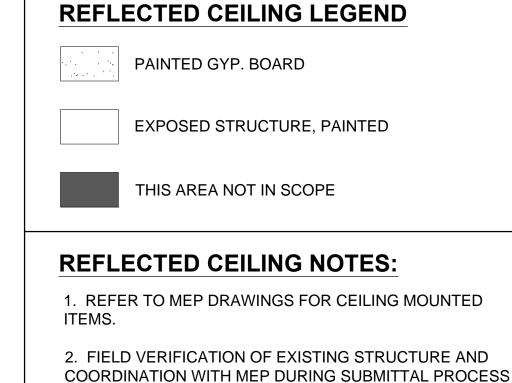



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Consultants:

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GREEN, RUBIANO &

ASSOCIATES INC.

STRUCTURAL:




PSJA ISD

NORTH ECHS & COLLEGE

UNIVERSITY **CAMPUS**

STUDENT RESTROOM RENOVATIONS

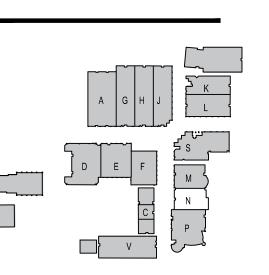

KEYPLAN


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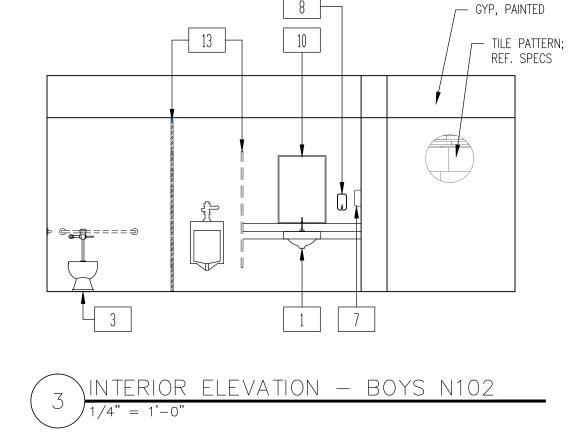
<u>1</u> - ADD 1 - 5/24/19


BUILDING N FLOORPLAN & REFL. CLG. PLN.


ADD. 2 A-112-N

	FIXTURE MOUNTING HEIGHT SCHEDULE * REFER TO ADA GUIDELINES ON SHEET G-102.		ADULTS
1	1. LAVATORIES/SINK (MEASURED FROM FLOOR TO RIM)	STANDARD	32" 34" MAX
		ACCESSIBLE	(29" MIN KNEESPACE)
2	2. URINALS (MEASURED FROM FLOOR TO RIM)	STANDARD	16" MAX
		ACCESSIBLE	17" MAX
3	3. WATER CLOSETS (MEASURED FROM FLOOR TO TOP OF SEAT)	STANDARD	15"
	(ACCESSIBLE	17" TO 19"
4	4. DRINKING FOUNTAINS AND EWC'S	STANDARD	42"
	FRONTAL APPROACH (MEASURED FROM FLOOR TO SPOUT OUTLET)	ACCESSIBLE	36" MAX (27" MIN KNEESPACE)
	5. GRAB BARS	STANDARD	
5	(MEASURED FROM FLOOR TO CENTERLINE OF BAR — 36" LONG @ REAR WALL & 42" LONG @ SIDE WALL OR 90 DEGRESS CONT. GRAB BAR WHERE INDICATED	ACCESSIBLE	33" TO 36" TO TOP OF GRAB BAR
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	1 MIRROR PER LAVATORY (NOT NOTED FOR CLARITY). MEASURED FROM FLOOR TO BOTTOM OF REFLECTING SURFACE.	ACCESSIBLE	40" MAX
11	11. MOP BASIN / SERVICE SINK (ONE PER ROOM LABELED CUSTODIAN)		
12	12. MOP HOLDER (ONE PER ROOM LABELED CUSTODIAN)		48" MAX
13	13. TOILET PARTITION / URINAL SCREEN	NOT NOTE	D FOR CLARITY



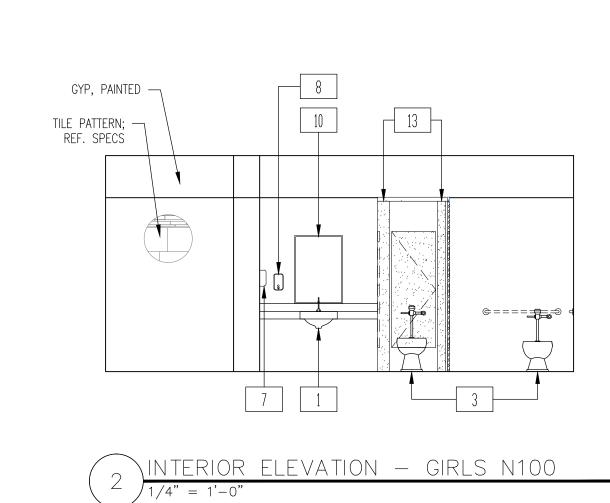

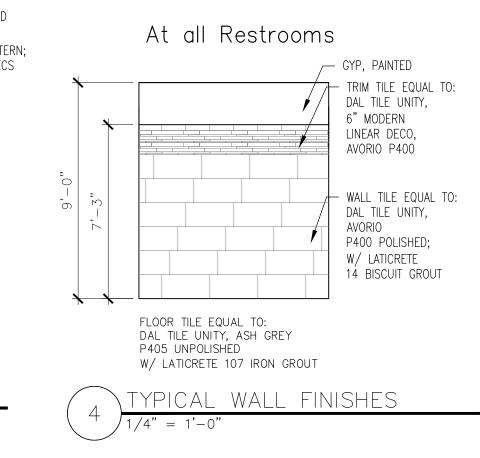

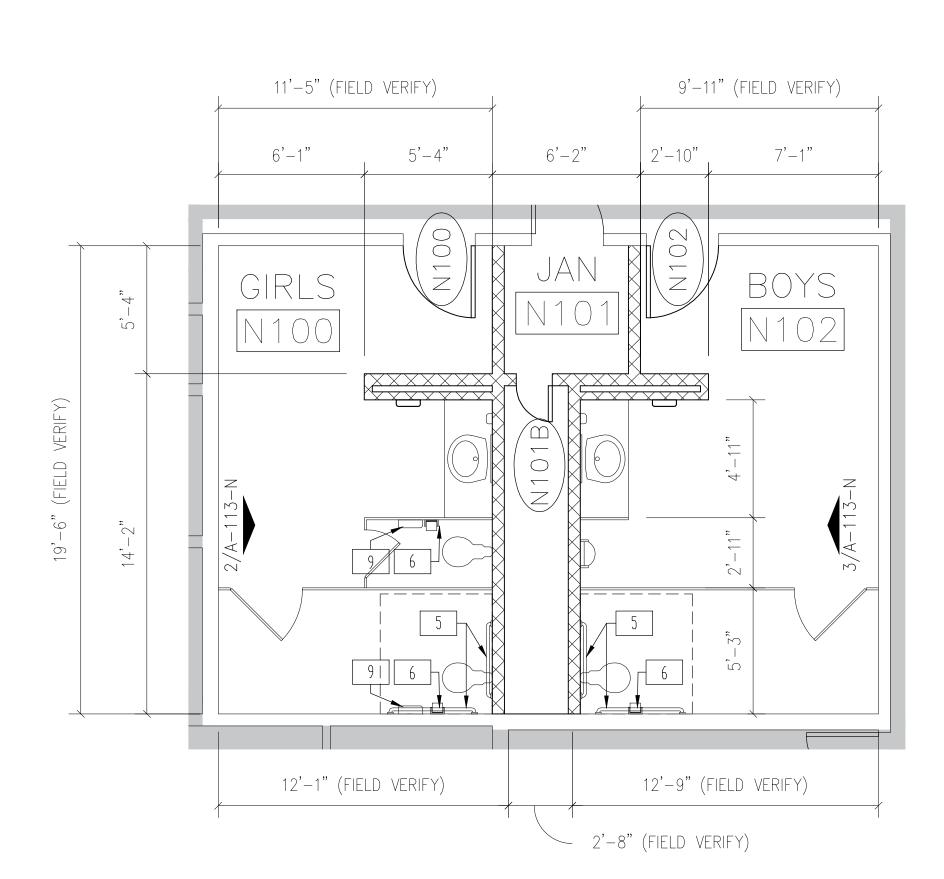



GIGNAC | ARCHITECTS

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222 E. VAN BUREN, SUITE 102 HARLINGEN, TEXAS 78550 T 956.365.4820 F 956.365.4822


McALLEN, TEXAS 78501 T 956.686.0100 F 956.622.7313

Consultants:

MELDEN & HUNT

STRUCTURAL:
GREEN, RUBIANO &
ASSOCIATES INC.

MEP: DBR ENGINEERING

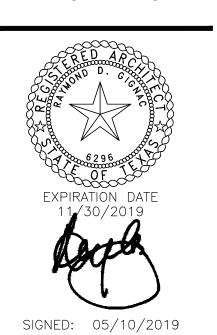




PSJA ISD

NORTH ECHS & COLLEGE AND

UNIVERSITY CAMPUS

STUDENT RESTROOM RENOVATIONS

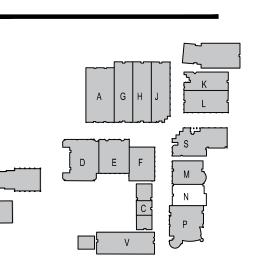

KEYPLAN

Project Number: 19.04
Drawing Date: MAY 10, 2019
Drawn: CQ
Checked: JM
Scale: VARIES
ACAD File: DEMO PLAN

Revisions: 1 - ADD 1 - 5/24/19

Sheet Title:


BUILDING N INT ELEV. & ENLRG. FLRPLN.

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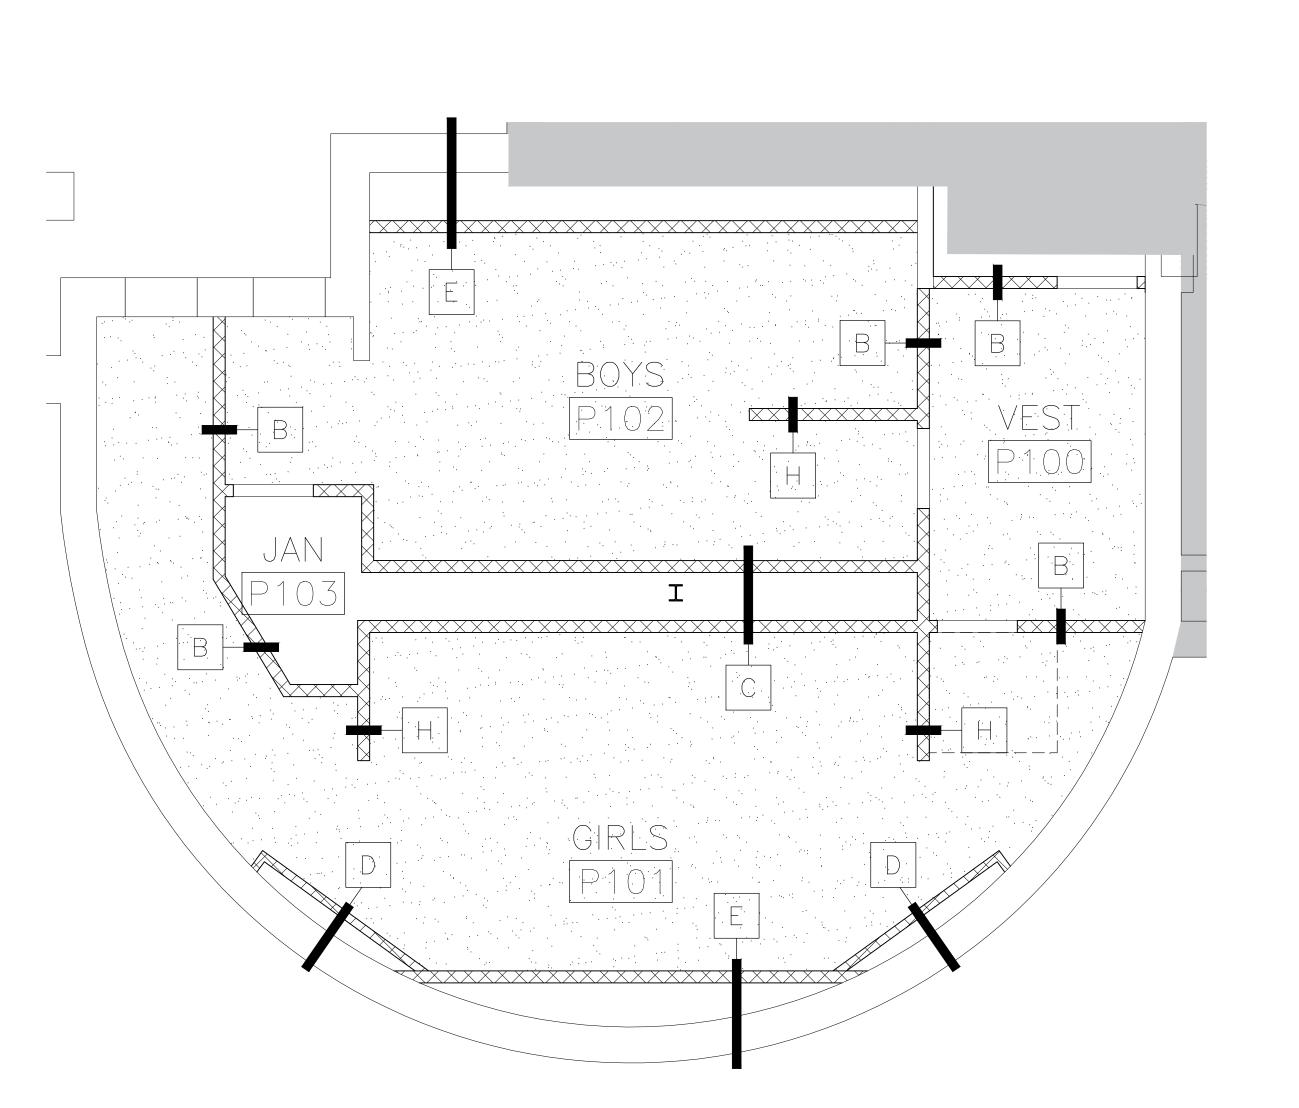
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DOOR			DOOR	FRAME			
SCHEDULE	WIDTH	HEIGHT	TYPE	MATERIAL	TYPE	MATERIAL	REMARKS
P100	3'-0"	7′-0″	FL	WD	А	НМ	
P101A	3'-0"	7'-0"	FL	WD	Α	НМ	
P101B	3'-0"	7′-0″	FL	НМ	А	НМ	FIELD VERIFY EXISTING OPENING
P102A	3'-0"	7'-0"	FL	WD	А	НМ	
P102B	3'-0"	7′-0″	FL	НМ	Α	НМ	FIELD VERIFY EXISTING OPENING
P103	3'-0"	7′-0″	FL	WD	А	НМ	

	ROOM FINISH SCHEDULE											
NUMBER	NAME	FLOOR	BASE	NORTH WALL	SOUTH WALL	EAST WALL	WEST WALL	CEILING	CLG HT.	NOTES		
P100	VESTIBULE	SEALED CONCRETE	NDNE	PT	PT	PT	PT	EXP STRUC		PAINT EXPOSED STRUCTURE & DECK		
P101	GIRLS	TILE: UNITY ASH GREY	TILE: UNITY AVORIO/PT	GYP. PTD.	9'-0"							
P102	BOYS	TILE: UNITY ASH GREY	TILE: UNITY AVORIO/PT	GYP. PTD.	9'-0"							
P103	JANITOR	SEALED CONCRETE	NONE	PT	PT	PT	PT	EXP STRUC		PAINT EXPOSED STRUCTURE & DECK		





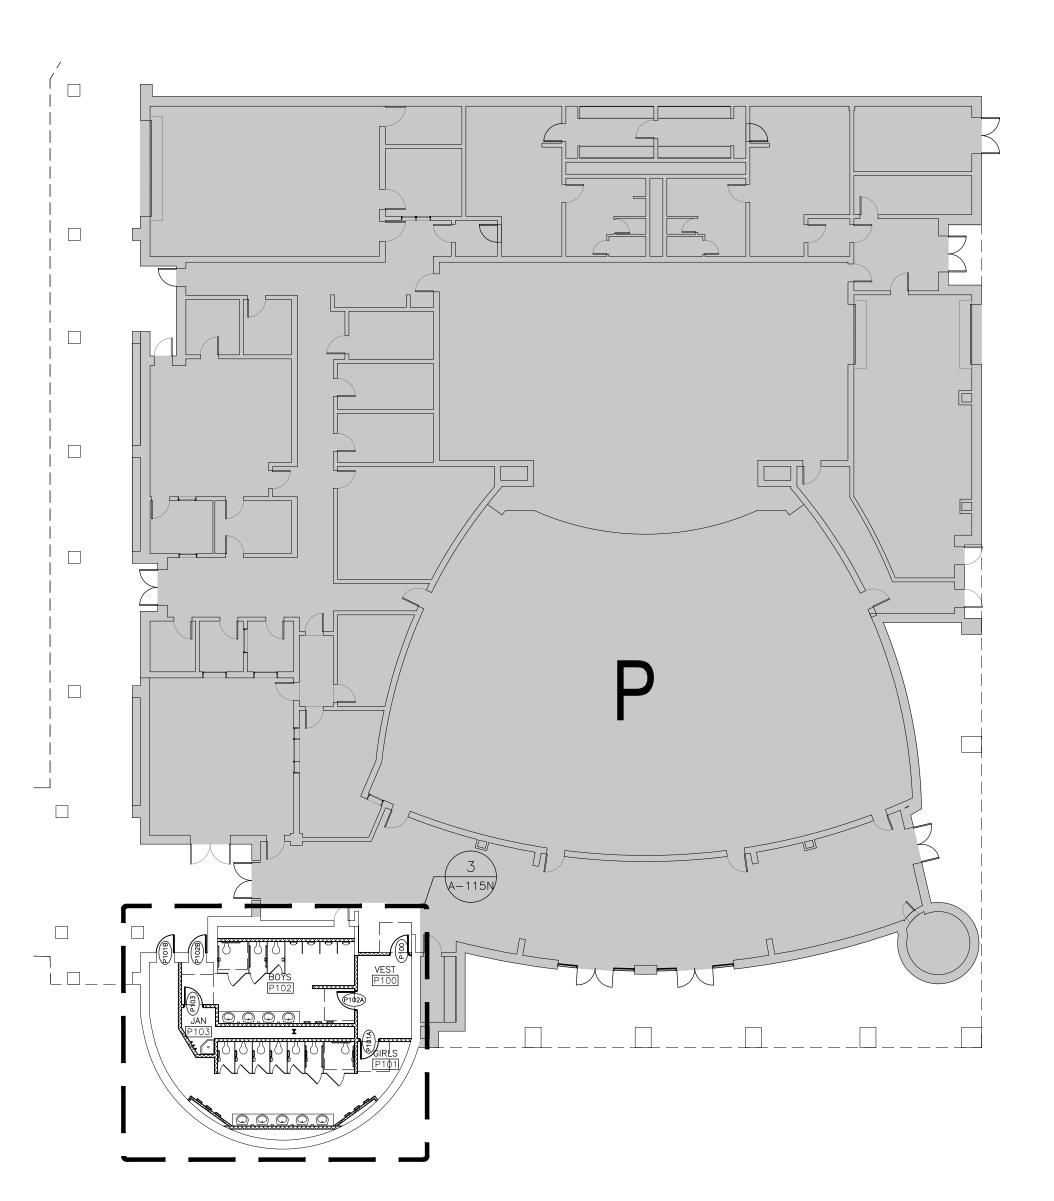





PAINTED GYP. BOARD

EXPOSED STRUCTURE, PAINTED

EXPOSED STRUCTURE, FAINT

THIS AREA NOT IN SCOPE

REFLECTED CEILING NOTES:

1. REFER TO MEP DRAWINGS FOR CEILING MOUNTED ITEMS.

2. FIELD VERIFICATION OF EXISTING STRUCTURE AND COORDINATION WITH MEP DURING SUBMITTAL PROCESS SHALL BE REQUIRED IN ORDER TO ACHIEVE MAXIMUM CEILING HEIGHTS.

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3700 N. 10TH, SUITE 205

McALLEN, TEXAS 78501

T 956.686.0100

F 956.622.7313

Consultants:


<u>CIVIL:</u> MELDEN & HUNT

STRUCTURAL:

GREEN, RUBIANO &

MEP: DBR ENGINEERING

ASSOCIATES INC.

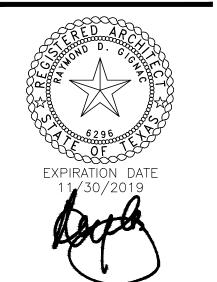




SIGNED: 05/10/2019

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& COLLEGE

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STUDENT RESTROOM RENOVATIONS



KEYPLAN

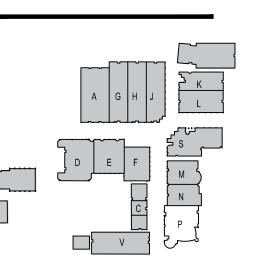Project Number: 19.04
Drawing Date: MAY 10, 2019
Drawn: CQ
Checked: JM
Scale: VARIES
ACAD File: DEMO PLAN

Revisions:


1 - ADD 1 - 5/24/19


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BUILDING P FLOORPLAN & REFL. CLG. PLN.

ADD. 2 A-114-N


	HEI	TURE MOUNTING GHT SCHEDULE TO ADA GUIDELINES ON SHEET G-102.		ADULTS
	1. LAV	ATORIES/SINK	STANDARD	32"
	(ME	ASURED FROM FLOOR TO RIM)	ACCESSIBLE	34" MAX (29" MIN KNEESPACE)
2		VALS	STANDARD	16" MAX
	(ME)	ASURED FROM FLOOR TO RIM)	ACCESSIBLE	17" MAX
3		ER CLOSETS	STANDARD	15"
	(MEA	ASURED FROM FLOOR TO TOP OF SEAT)	ACCESSIBLE	17" TO 19"
4		NKING FOUNTAINS AND EWC's	STANDARD	42"
		NTAL APPROACH ASURED FROM FLOOR TO SPOUT OUTLET)	ACCESSIBLE	36" MAX (27" MIN KNEESPACE)
		B BARS	STANDARD	
5	BAR LON	ASURED FROM FLOOR TO CENTERLINE OF 2 - 36" LONG @ REAR WALL & 42" IG @ SIDE WALL OR 90 DEGRESS CONT. B BAR WHERE INDICATED	ACCESSIBLE	33" TO 36" TO TOP OF GRAB BAR
		ET TISSUE DISPENSER	STANDARD	20"
6	•	ASURED FROM FLOOR TO ITERLINE OF ROLL)	ACCESSIBLE	19" MIN
7		CTRIC HAND DRYER	STANDARD	48"
7	,	ASURED FROM FLOOR TO ITER OF CONTROL)	ACCESSIBLE	45" MAX
8		P DISPENSER	STANDARD	38"
	•	ASURED FROM FLOOR TO ITERLINE OF PUSH BUTTON)	ACCESSIBLE	38"
9		ITARY NAPKIN DISPOSAL UNIT ASURED FROM FLOOR TO TOP OF UNIT)	STANDARD	40"
	`	LY IN ROOMS LABELED WOMEN & GIRLS)	ACCESSIBLE	
10	10. MIRF	RORS	STANDARD	
	CLAF	RROR PER LAVATORY (NOT NOTED FOR RITY). MEASURED FROM FLOOR TO	ACCESSIBLE	40" MAX
	ВОТТ	OM OF REFLECTING SURFACE.		
11		P BASIN / SERVICE SINK E PER ROOM LABELED CUSTODIAN)		
12		P HOLDER E PER ROOM LABELED CUSTODIAN)		48" MAX
13	13. TOIL	ET PARTITION / URINAL SCREEN	NOT NOTE	D FOR CLARITY




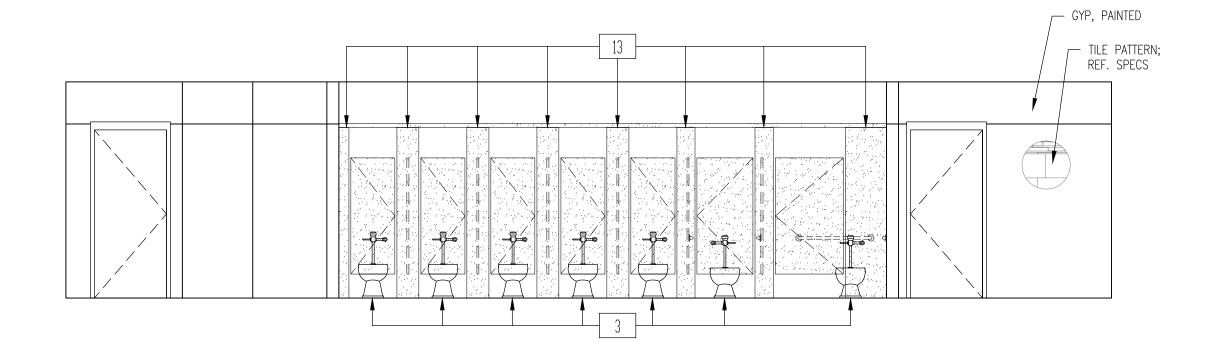


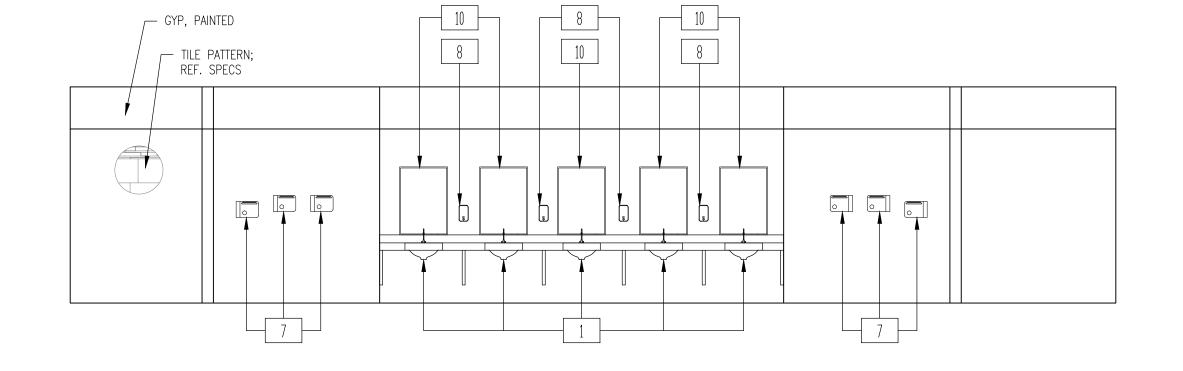INTERIOR ELEVATION - GIRLS P101



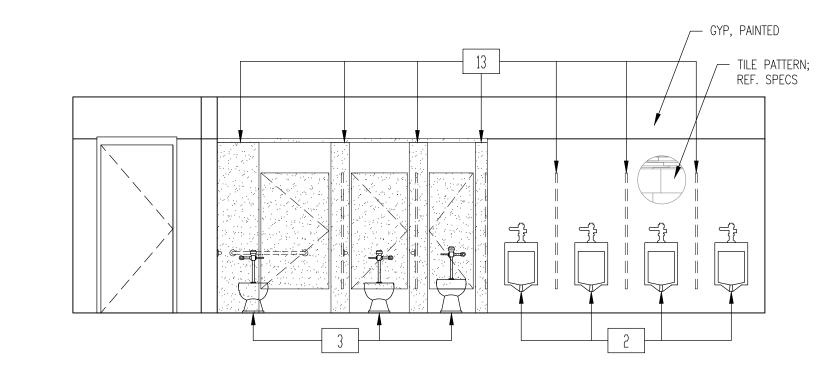


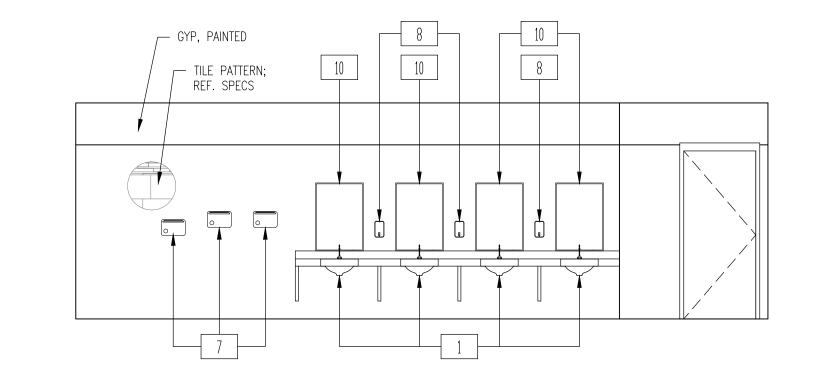

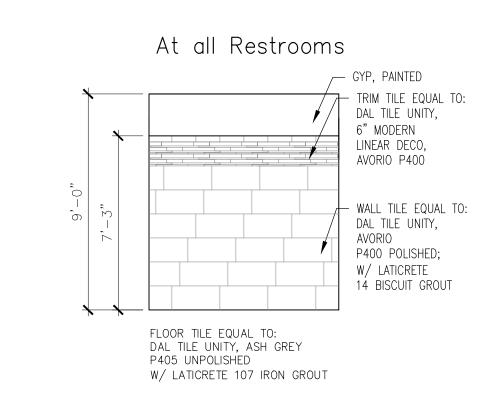

) INTERIOR ELEVATION - BOYS P102 $3 \frac{\text{INTERIOR ELEVATION - BOYS P102}}{1/4" = 1'-0"}$



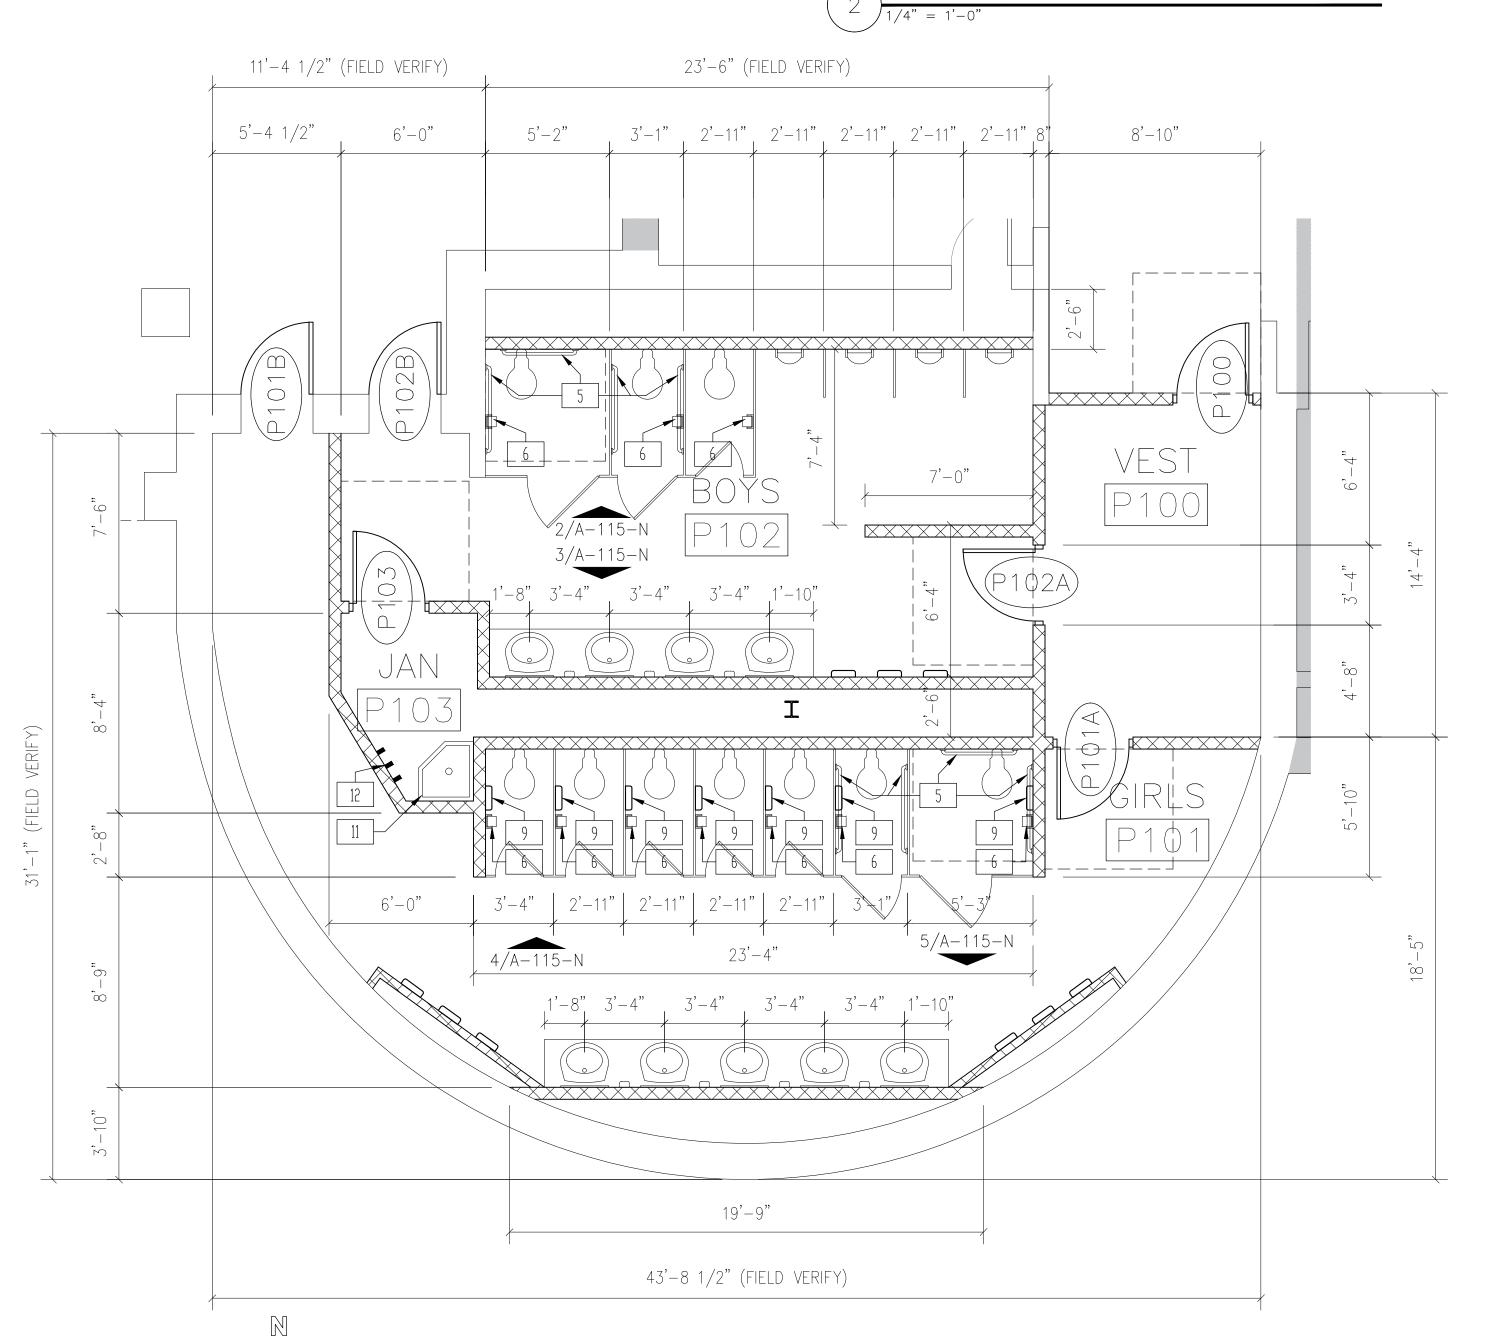

\ENLARGED FLOORPLAN - BUILDING P

RENOVATIONS

GIGNAC | ARCHITECTS

416 STARR STREET CORPUS CHRISTI, TEXS 78401 T 361.884.2661 F 361.884.4232

222 E. VAN BUREN, SUITE 102 HARLINGEN, TEXAS 78550 T 956.365.4820 F 956.365.4822

3700 N. 10TH, SUITE 205 MCALLEN, TEXAS 78501

T 956.686.0100

F 956.622.7313

Consultants:

MELDEN & HUNT

GREEN, RUBIANO & ASSOCIATES INC.

DBR ENGINEERING

EXPIRATION DATE 11/30/2019

SIGNED: 05/10/2019

COLLEGE³
READY.CONNECTED.COMPLETE TO

PSJA ISD

NORTH ECHS

& COLLEGE

AND

UNIVERSITY

CAMPUS

STUDENT

RESTROOM

STRUCTURAL:

KEYPLAN

Project Number: 19.04
Drawing Date: MAY 10, 2019
Drawn: CQ
Checked: JM
Scale: VARIES
ACAD File: DEMO PLAN
Revisions:

<u>1</u> - ADD 1 - 5/24/19

Sheet Title:


BUILDING P INT ELEV. & ENLRG. FLRPLN.


ADD. 2 A-115-N


- 1. DEMOLITION AND PROPOSED WORK WILL HAVE TO BE COORDINATED WITH THE OWNER TO MINIMIZE DISRUPTIONS TO THE CAMPUS, WHICH MAY BE IN USE.
- 2. ANY EXISTING WALLS TO REMAIN THAT REQUIRE REPAIR AFTER DEMOLITION IS COMPLETE, SHALL BE OBSERVED BY THE DESIGN TEAM AND OWNER PRIOR TO REPAIR. COORDINATION WILL BE REQUIRED.
- 3. ANY OPENINGS IN EXISTING WALLS SCHEDULED TO BE INFILLED SHALL HAVE THE SAME MATERIAL AND FINISH AS THAT OF THE EXISTING WALL. ALL INFILLED OPENINGS SHALL BE FLUSH WITH EXISTING WALL SURFACES AND PAINTED.

				HEDULE			
DOOR			DOOR		Ff	RAME	DEMADICS
SCHEDULE	WIDTH	HEIGHT	TYPE	MATERIAL	TYPE	MATERIAL	REMARKS
V100A	3'-0"	7′-0″	FL	WD	А	НМ	
∨100B	3'-0"	7′-0″	FL	НМ	Α	НМ	FIELD VERIFY EXISTING OPENING
∨101A	3'-0"	7′-0″	FL	WD	Α	НМ	
∨101B	3'-0"	7′-0″	FL	НМ	А	НМ	FIELD VERIFY EXISTING OPENING
V102	3'-0"	7′-0″	FL	НМ	А	НМ	


					ROOM FINISH	SCHEDULE				
NUMBER	NAME	FLOOR	BASE	NORTH WALL	SOUTH WALL	EAST WALL	WEST WALL	CEILING	CLG HT.	NOTES
V100	GIRLS	TILE: UNITY ASH GREY	TILE: UNITY AVORIO/PT	GYP. PTD.	9'-0"					
V101	BOYS	TILE: UNITY ASH GREY	TILE: UNITY AVORIO/PT	GYP. PTD.	9'-0"					
V102	JANITOR	SEALED CONCRETE	NDNE	PT	PT	PT	PT	EXP STRUC		PAINT EXPOSED STRUCTURE & DECK

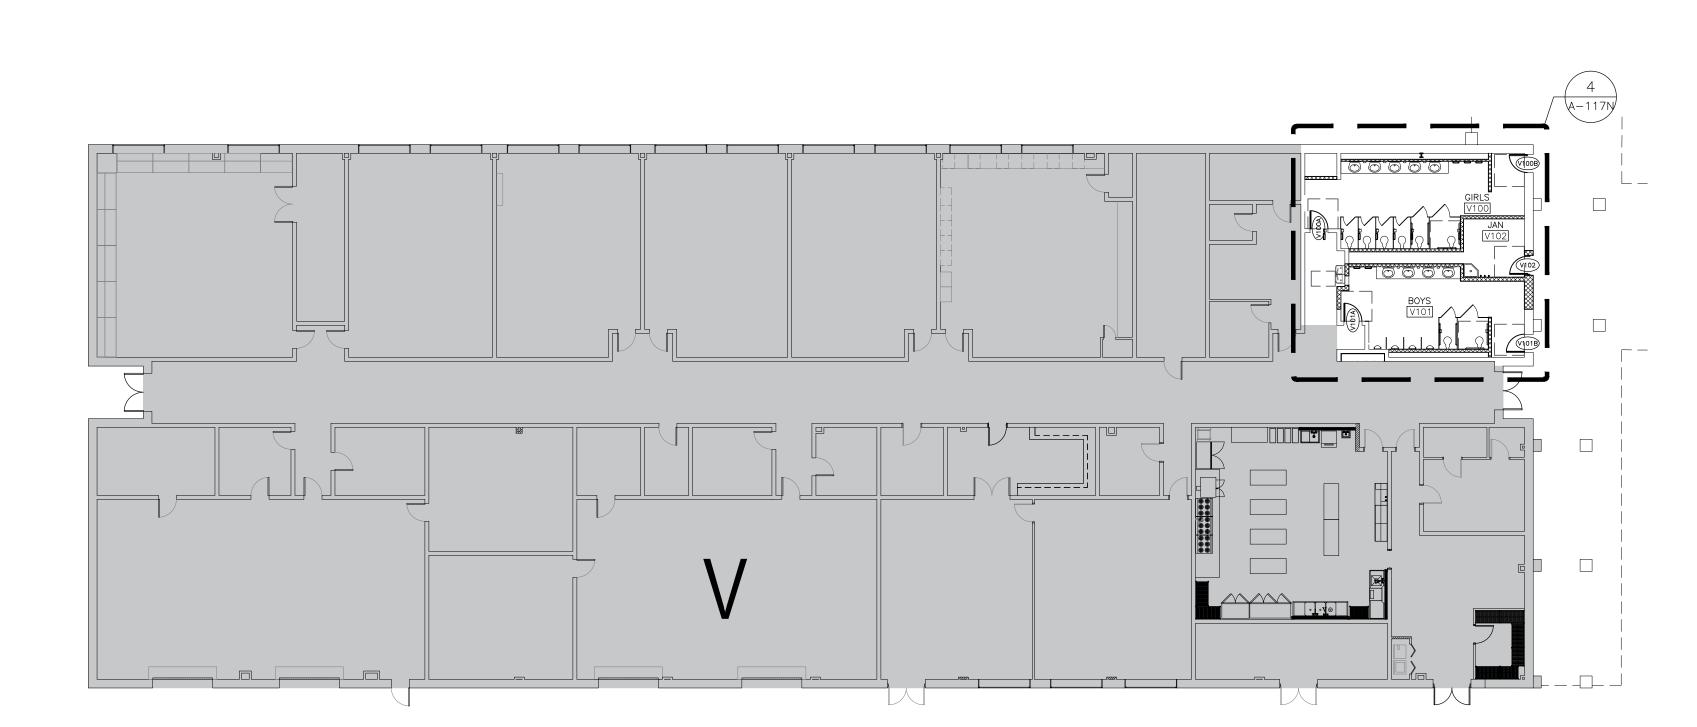

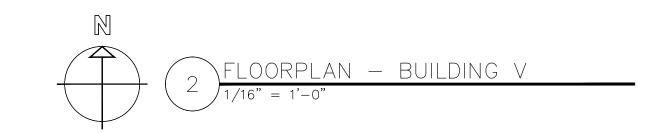


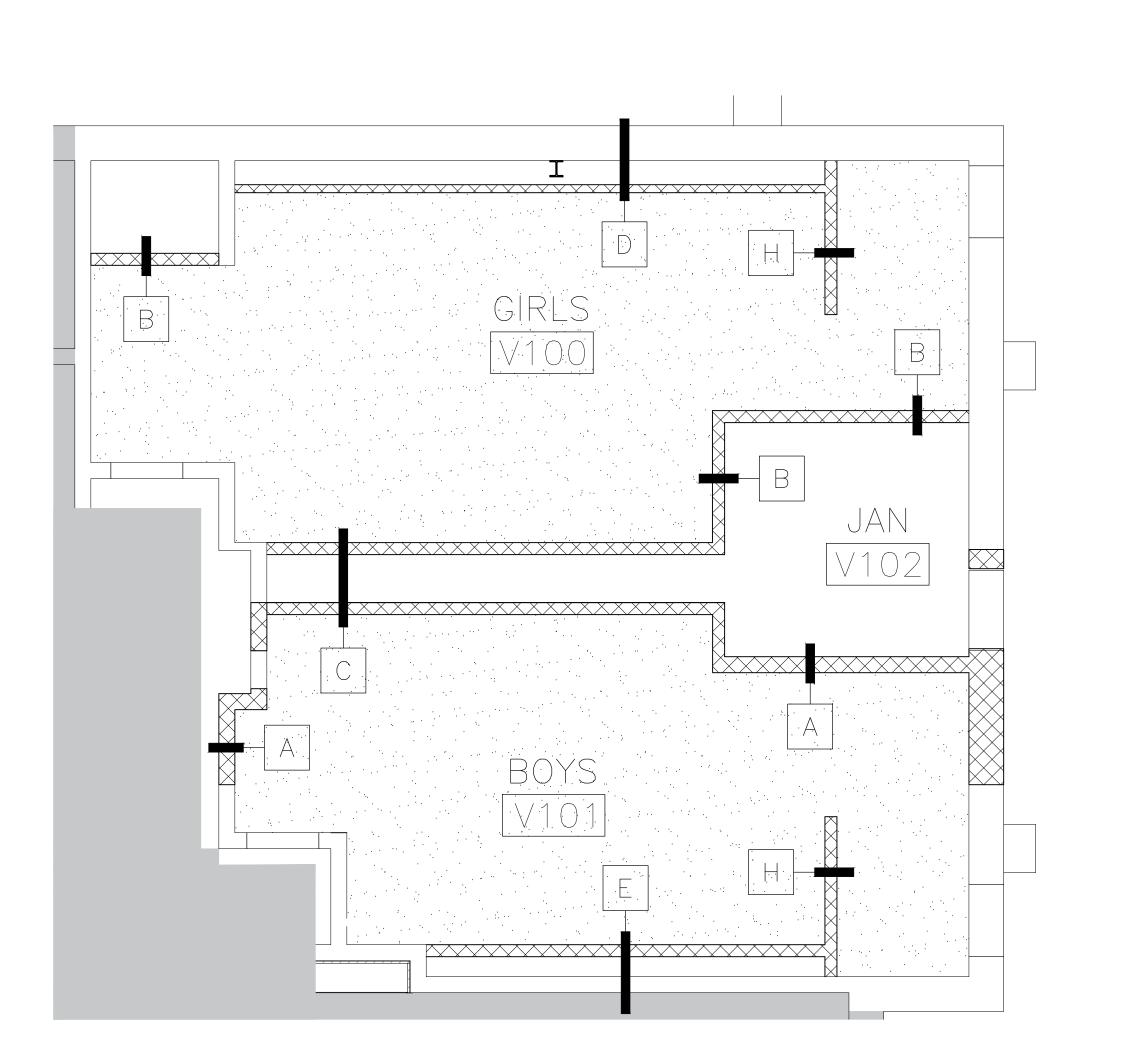




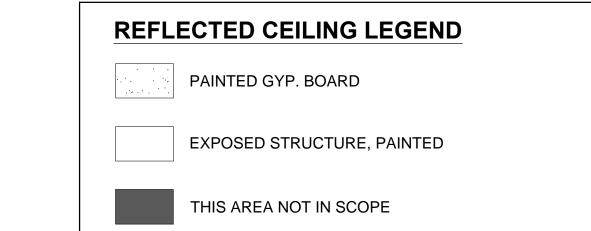

2. FIELD VERIFICATION OF EXISTING STRUCTURE AND SHALL BE REQUIRED IN ORDER TO ACHIEVE MAXIMUM CEILING HEIGHTS.

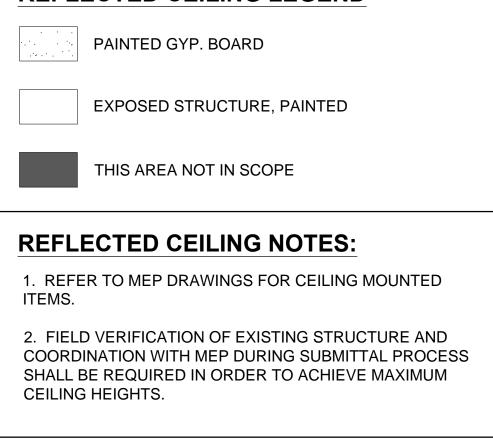

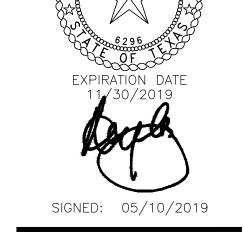

GIGNAC | ARCHITECTS

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3700 N. 10TH, SUITE 205

McALLEN, TEXAS 78501

T 956.686.0100

F 956.622.7313

Consultants:

MELDEN & HUNT

GREEN, RUBIANO &

DBR ENGINEERING

ASSOCIATES INC.

STRUCTURAL:




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NORTH ECHS & COLLEGE

UNIVERSITY **CAMPUS**

STUDENT RESTROOM RENOVATIONS

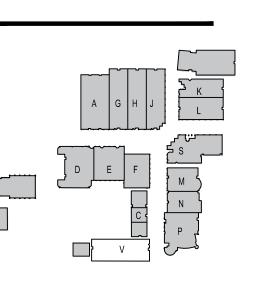

KEYPLAN


Project Number: Drawing Date: MAY 10, 2019 Checked: ACAD File: DEMO PLAN Revisions:

<u>1</u> - ADD 1 - 5/24/19


BUILDING V FLOORPLAN & REFL. CLG. PLN.

ADD. 2 A-116-N


		H	FIXTURE MOUNTING HEIGHT SCHEDULE EFER TO ADA GUIDELINES ON SHEET G-102.		ADULTS
	1	1.	LAVATORIES/SINK	STANDARD	32"
			(MEASURED FROM FLOOR TO RIM)	ACCESSIBLE	34" MAX (29" MIN KNEESPACE)
	2	2.	URINALS (MEASURED FROM FLOOR TO RIM)	STANDARD	16" MAX
			(MLASONED THOM FLOOR TO NIM)	ACCESSIBLE	17" MAX
	3	3.	WATER CLOSETS (MEASURED FROM FLOOR TO TOP OF SEAT)	STANDARD	15"
			(ME/SORED TROM FESSIVE TO TOT OF SEAT)	ACCESSIBLE	17" TO 19"
	4	4.	DRINKING FOUNTAINS AND EWC'S FRONTAL APPROACH	STANDARD	42"
			(MEASURED FROM FLOOR TO SPOUT OUTLET)	ACCESSIBLE	36" MAX (27" MIN KNEESPACE)
		5.	GRAB BARS (MEASURED FROM FLOOR TO CENTERLINE OF	STANDARD	
	5		BAR - 36" LONG @ REAR WALL & 42" LONG @ SIDE WALL OR 90 DEGRESS CONT. GRAB BAR WHERE INDICATED	ACCESSIBLE	33" TO 36" TO TOP OF GRAB BAR
	6	6.	TOILET TISSUE DISPENSER (MEASURED FROM FLOOR TO	STANDARD	20"
	U		CENTERLINE OF ROLL)	ACCESSIBLE	19" MIN
	7	7.	ELECTRIC HAND DRYER (MEASURED FROM FLOOR TO	STANDARD	48"
	,		CENTER OF CONTROL)	ACCESSIBLE	45" MAX
	8	8.	SOAP DISPENSER (MEASURED FROM FLOOR TO	STANDARD	38"
			CENTERLINE OF PUSH BUTTON)	ACCESSIBLE	38"
	9	9.	SANITARY NAPKIN DISPOSAL UNIT (MEASURED FROM FLOOR TO TOP OF UNIT)	STANDARD	40"
			(ONLY IN ROOMS LABELED WOMEN & GIRLS)	ACCESSIBLE	
	.0	10.	MIRRORS	STANDARD	
			1 MIRROR PER LAVATORY (NOT NOTED FOR CLARITY). MEASURED FROM FLOOR TO BOTTOM OF REFLECTING SURFACE.	ACCESSIBLE	40" MAX
	1	11.	MOP BASIN / SERVICE SINK (ONE PER ROOM LABELED CUSTODIAN)		
1	2	12.	MOP HOLDER (ONE PER ROOM LABELED CUSTODIAN)		48" MAX
	3	13.	TOILET PARTITION / URINAL SCREEN	NOT NOTE) FOR CLARITY

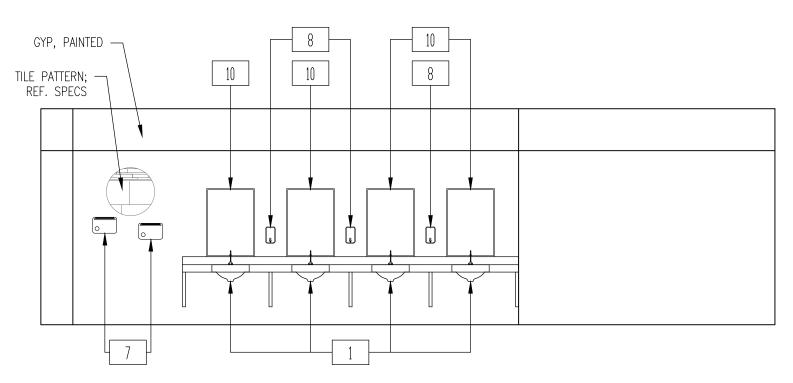




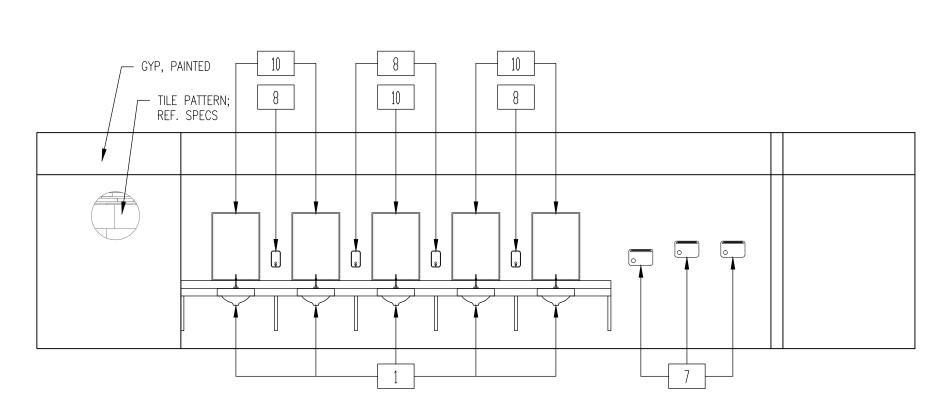


INTERIOR ELEVATION - GIRLS V100

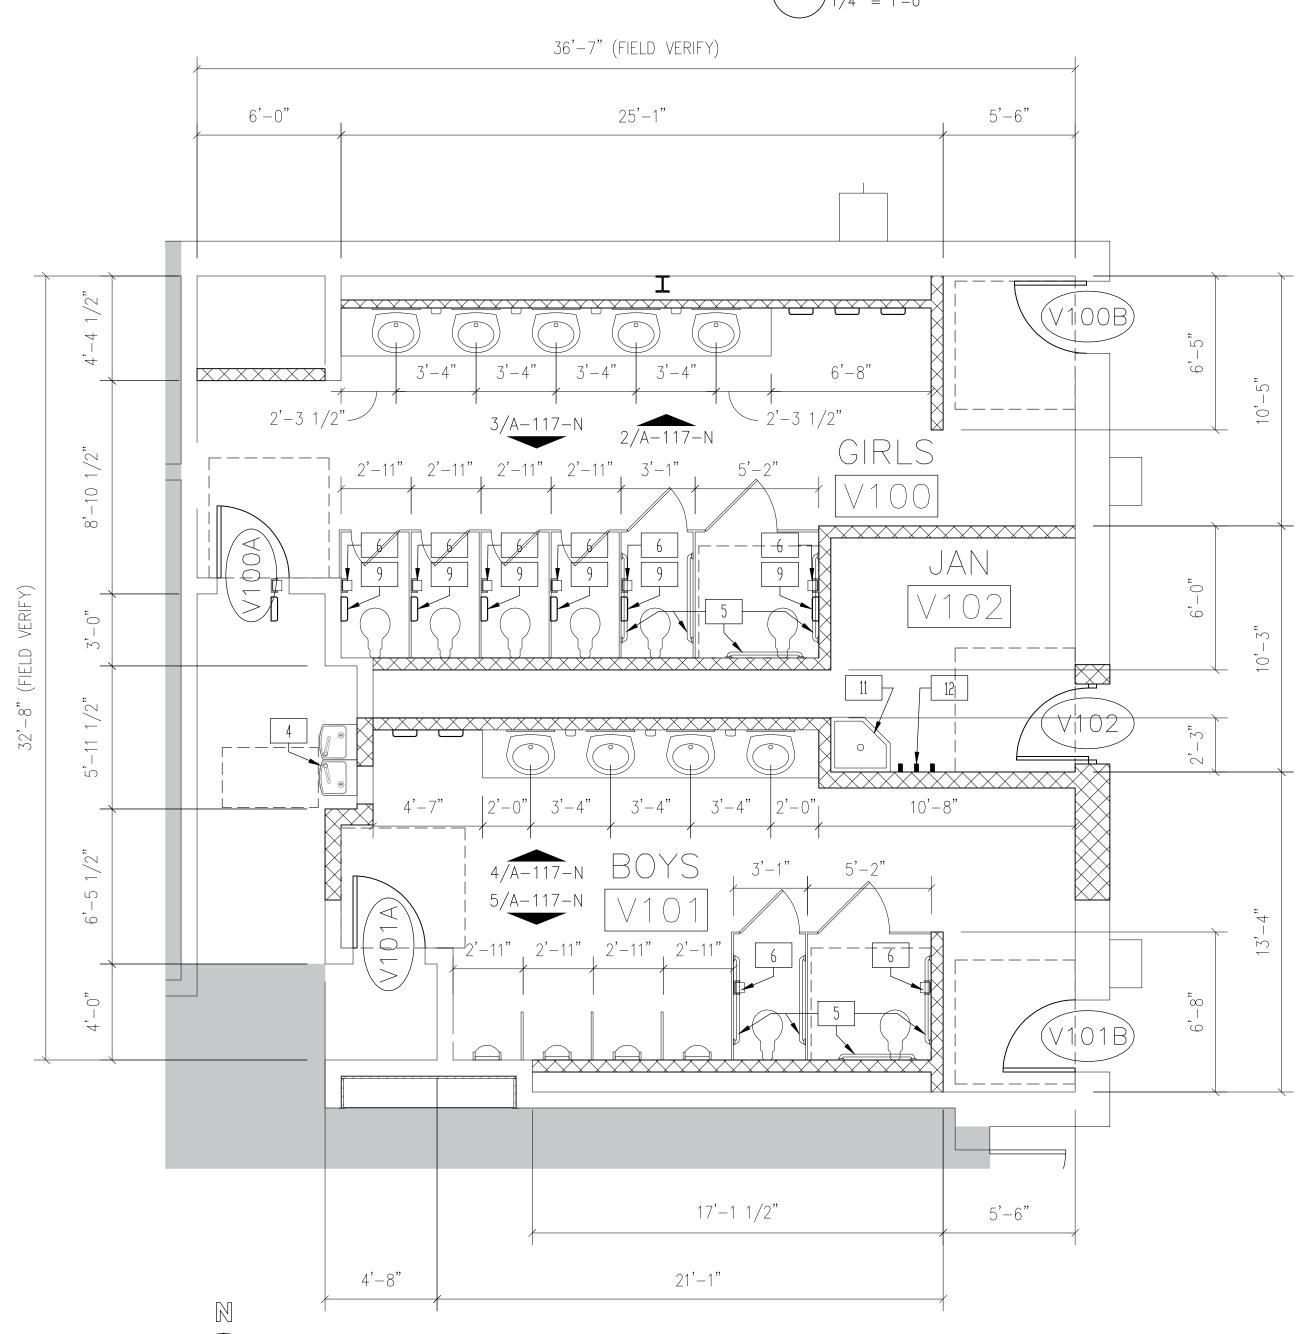


\ENLARGED FLOORPLAN - BUILDING V

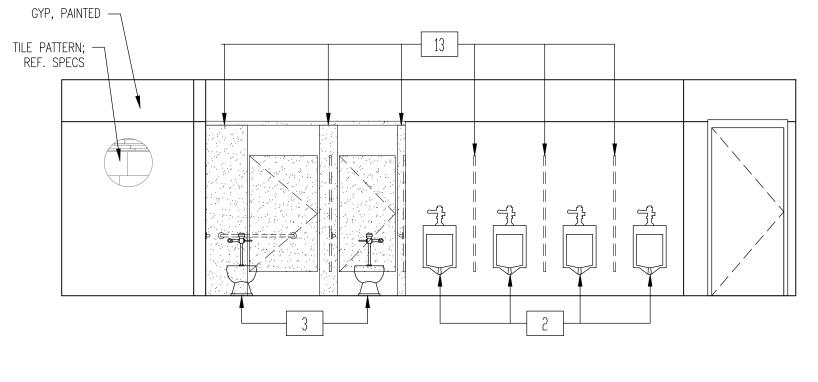



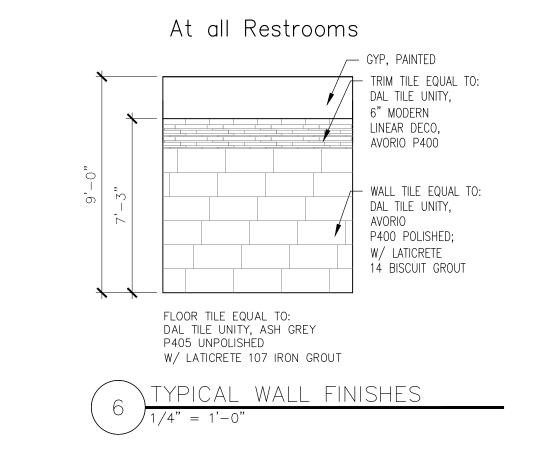

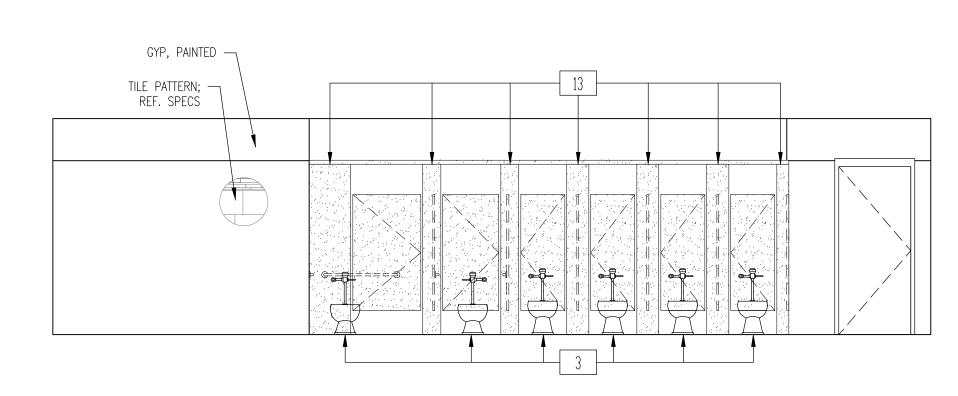

INTERIOR ELEVATION - GIRLS V100



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Consultants:

MELDEN & HUNT

STRUCTURAL: GREEN, RUBIANO & ASSOCIATES INC.

DBR ENGINEERING






SIGNED: 05/10/2019

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STUDENT RESTROOM RENOVATIONS



KEYPLAN

Project Number: Drawing Date: MAY 10, 2019 Drawn: Checked: VARIES Scale: ACAD File: DEMO PLAN Revisions:
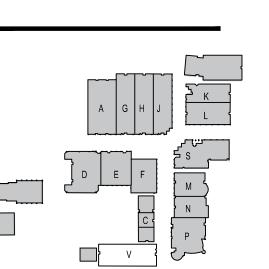
<u>1</u> - ADD 1 - 5/24/19


BUILDING V INT ELEV. & ENLRG. FLRPLN.

ADD. 2 A-117-N

- 1. DEMOLITION AND PROPOSED WORK WILL HAVE TO BE COORDINATED WITH THE OWNER TO MINIMIZE DISRUPTIONS TO THE CAMPUS, WHICH MAY BE IN USE.
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				DOOR	R SCH	HEDULE		
DOOR			DOOR		FI	RAME		
SCHEDULE	WIDTH	HEIGHT	TYPE	MATERIAL	TYPE	MATERIAL	REMARKS	
E100	3'-0"	7′-0″	FL	НМ	Α	НМ		
E101	3'-0"	7′-0″	FL	НМ	Α	НМ		

					ROOM FINISH	SCHEDULE				
NUMBER	NAME	FLOOR	BASE	NORTH WALL	SOUTH WALL	EAST WALL	WEST WALL	CEILING	CLG HT.	NOTES
E100	GIRLS	TILE: UNITY ASH GREY	TILE: UNITY AVORIO/PT	GYP. PTD.	9'-0"					
E101	BOYS	TILE: UNITY ASH GREY	TILE: UNITY AVORIO/PT	GYP. PTD.	9'-0"					



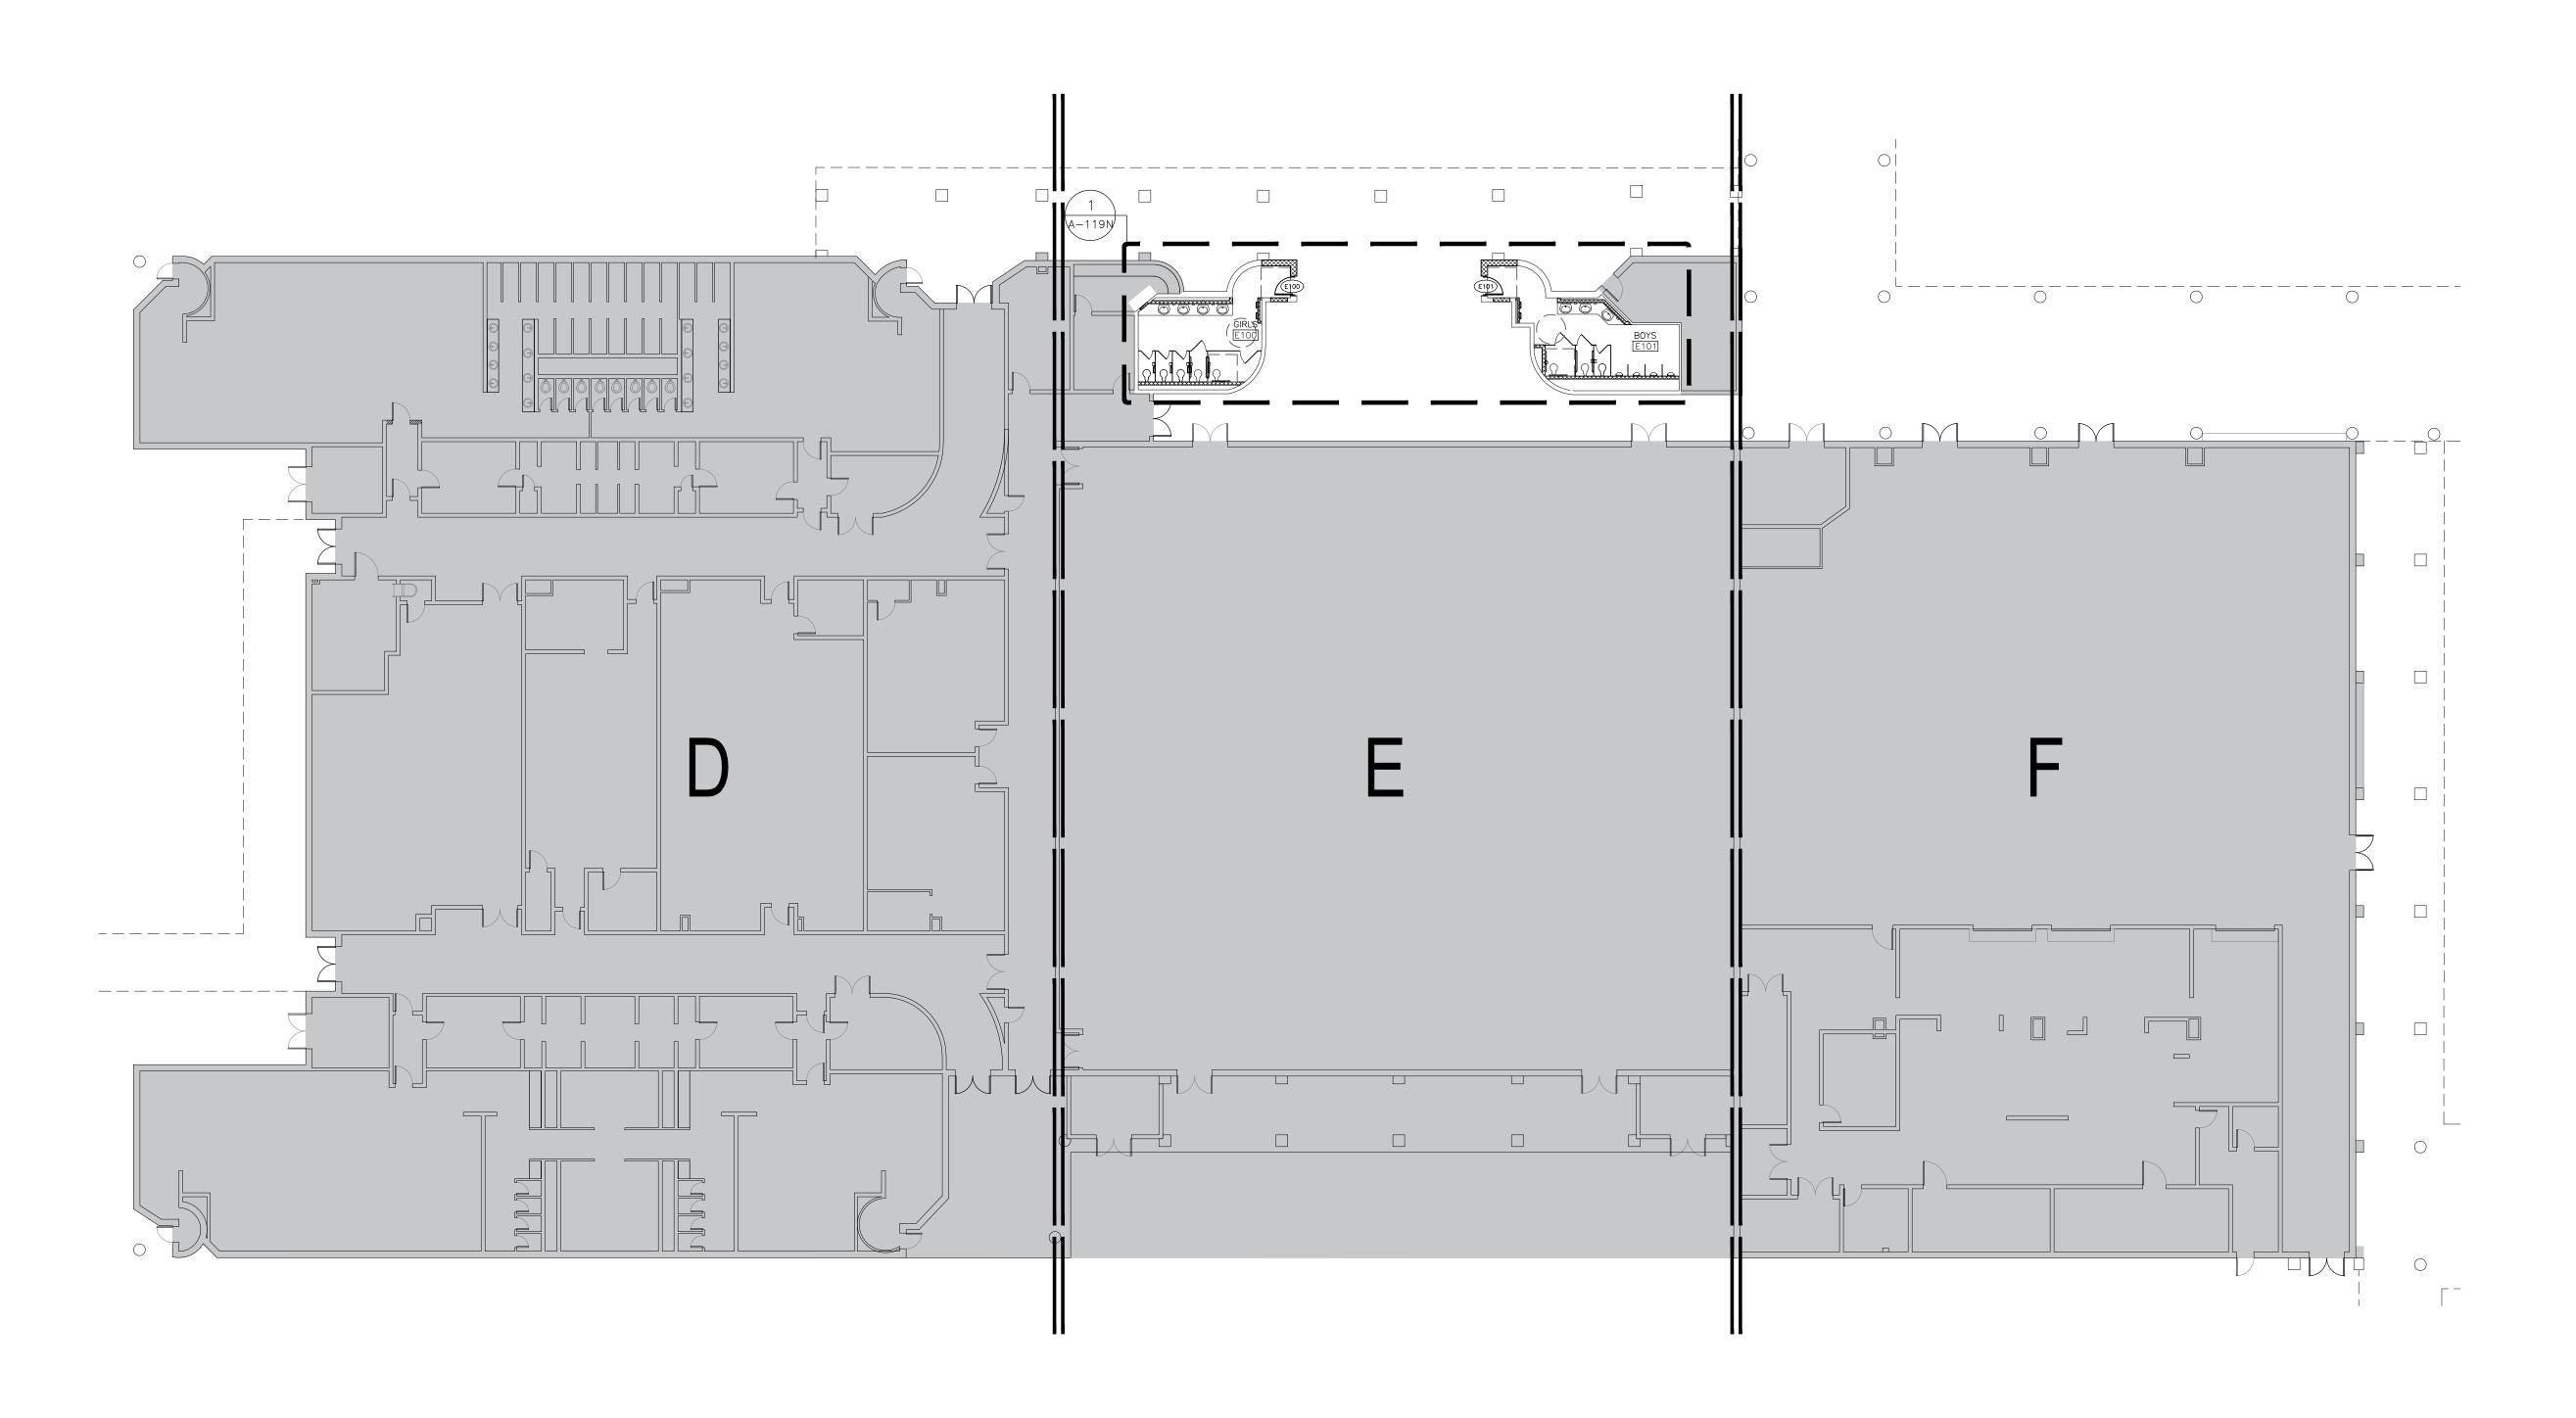



416 STARR STREET CORPUS CHRISTI, TEXS 78401 T 361.884.2661 F 361.884.4232

T 361.884.2661 F 361.884.4232 222 E. VAN BUREN, SUITE 102 HARLINGEN, TEXAS 78550

T 956.365.4820

F 956.365.4822


3700 N. 10TH, SUITE 205 McALLEN, TEXAS 78501 T 956.686.0100 F 956.622.7313

Consultants:

<u>CIVIL:</u> MELDEN & HUNT

STRUCTURAL:
GREEN, RUBIANO &
ASSOCIATES INC.

MEP: DBR ENGINEERING

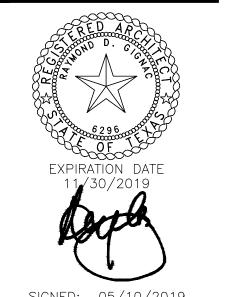




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STUDENT RESTROOM RENOVATIONS



KEYPLAN

Project Number: 19.04
Drawing Date: MAY 10, 2019
Drawn: CQ
Checked: JM
Scale: VARIES
ACAD File: DEMO PLAN

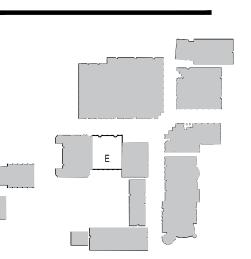
Revisions:


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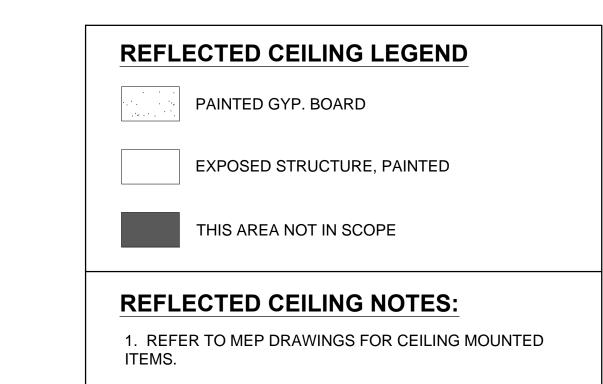
Sheet Title

BUILDING E FLOORPLAN

ADD. 2 A-118-N




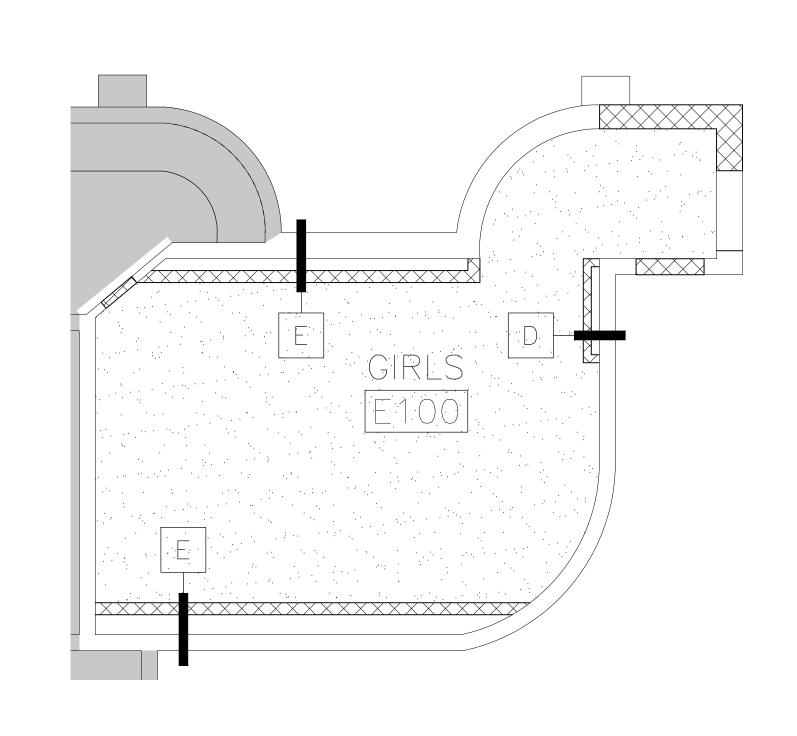

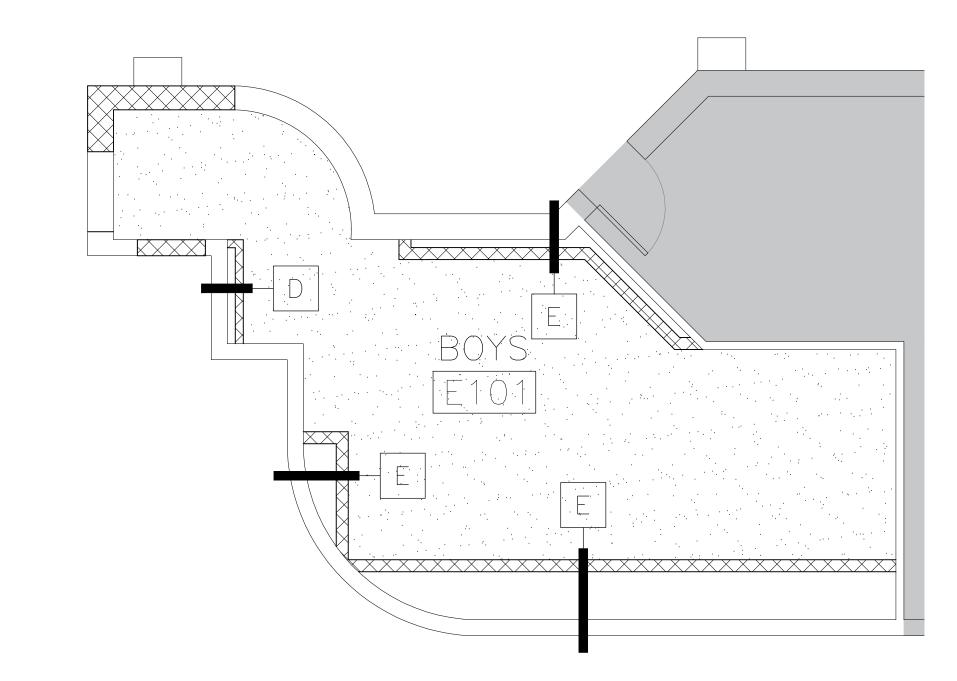


2. FIELD VERIFICATION OF EXISTING STRUCTURE AND COORDINATION WITH MEP DURING SUBMITTAL PROCESS SHALL BE REQUIRED IN ORDER TO ACHIEVE MAXIMUM CEILING HEIGHTS.

N	
A	OFFICATED OFFILMO DI ANI DINIO E
()	REFLECTED CEILING PLAN - BUILDING E

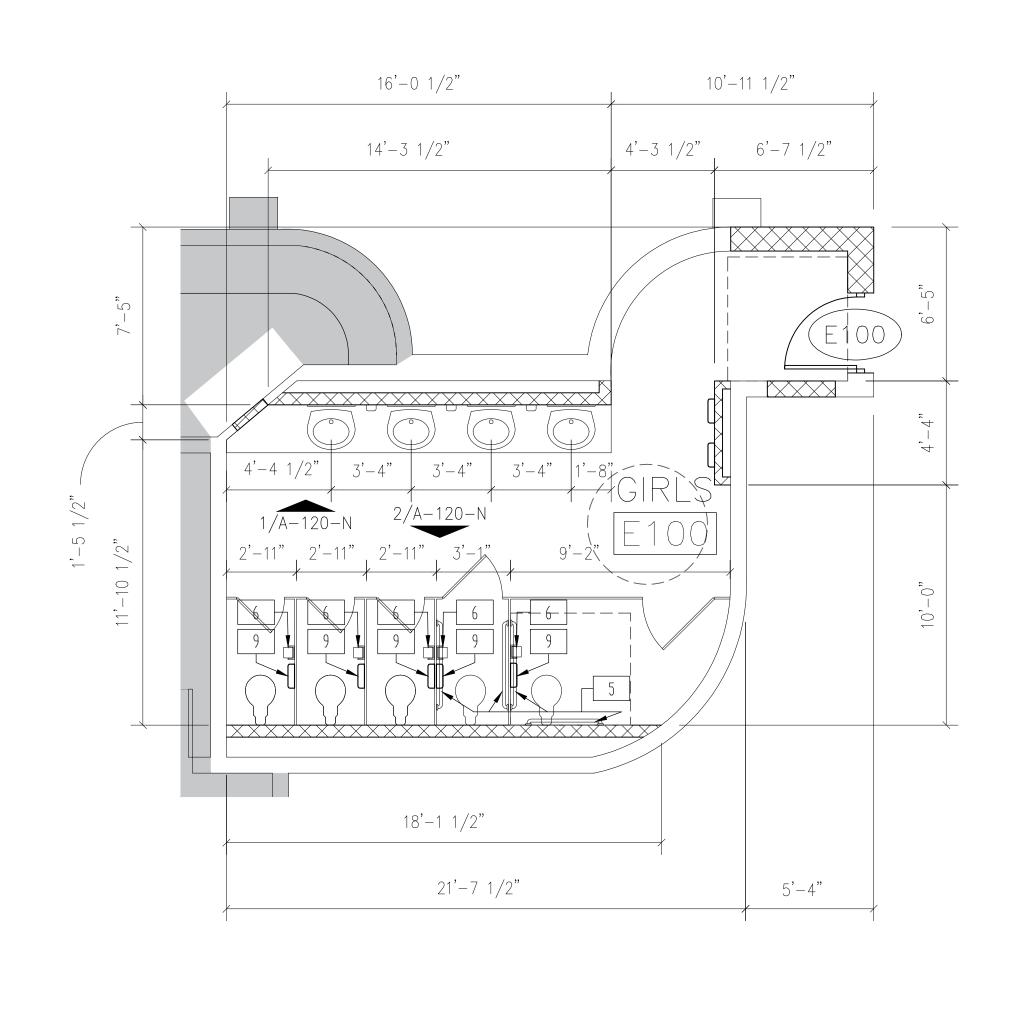

ENLARGED FLOORPLAN - BUILDING E

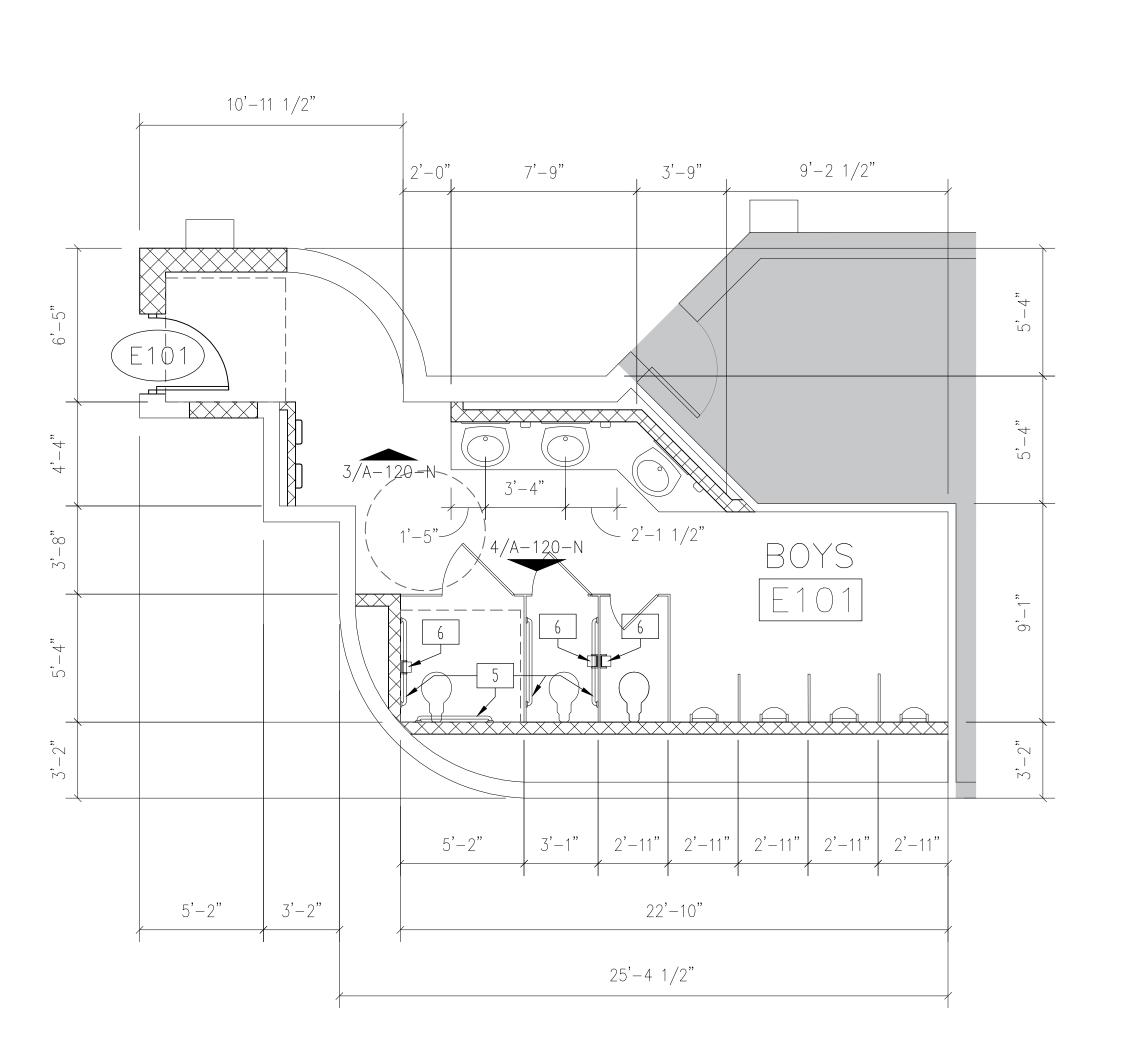

	FIXTURE MOUNTING		
	* REFER TO ADA GUIDELINES ON SHEET G-102.		ADULTS
1	1. LAVATORIES/SINK	STANDARD	32"
	(MEASURED FROM FLOOR TO RIM)	ACCESSIBLE	34" MAX (29" MIN KNEESPACE)
2	2. URINALS	STANDARD	16" MAX
	(MEASURED FROM FLOOR TO RIM)	ACCESSIBLE	17" MAX
3	3. WATER CLOSETS	STANDARD	15"
	(MEASURED FROM FLOOR TO TOP OF SEAT)	ACCESSIBLE	17" TO 19"
4	4. DRINKING FOUNTAINS AND EWC's	STANDARD	42"
	FRONTAL APPROACH (MEASURED FROM FLOOR TO SPOUT OUTLET)	ACCESSIBLE	36" MAX (27" MIN KNEESPACE)
	5. GRAB BARS	STANDARD	
5	(MEASURED FROM FLOOR TO CENTERLINE OF BAR — 36" LONG @ REAR WALL & 42" LONG @ SIDE WALL OR 90 DEGRESS CONT. GRAB BAR WHERE INDICATED	ACCESSIBLE	33" TO 36" TO TOP OF GRAB BAR
	6. TOILET TISSUE DISPENSER	STANDARD	20"
6	(MEASURED FROM FLOOR TO CENTERLINE OF ROLL)	ACCESSIBLE	19" MIN
7	7. ELECTRIC HAND DRYER	STANDARD	48"
7	(MEASURED FROM FLOOR TO CENTER OF CONTROL)	ACCESSIBLE	45" MAX
	8. SOAP DISPENSER	STANDARD	38"
8	(MEASURED FROM FLOOR TO CENTERLINE OF PUSH BUTTON)	ACCESSIBLE	38"
9	9. SANITARY NAPKIN DISPOSAL UNIT	STANDARD	40"
)	(MEASURED FROM FLOOR TO TOP OF UNIT) (ONLY IN ROOMS LABELED WOMEN & GIRLS)	ACCESSIBLE	
10	10. MIRRORS	STANDARD	
	1 MIRROR PER LAVATORY (NOT NOTED FOR CLARITY). MEASURED FROM FLOOR TO	ACCESSIBLE	40" MAX
	BOTTOM OF REFLECTING SURFACE.		
11	11. MOP BASIN / SERVICE SINK (ONE PER ROOM LABELED CUSTODIAN)		
12	12. MOP HOLDER (ONE PER ROOM LABELED CUSTODIAN)		48" MAX
13	13. TOILET PARTITION / URINAL SCREEN	NOT NOTE) FOR CLARITY

GIGNAC | ARCHITECTS

416 STARR STREET

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T 956.365.4820

F 956.365.4822 3700 N. 10TH, SUITE 205 MCALLEN, TEXAS 78501 T 956.686.0100 F 956.622.7313


Consultants:

<u>CIVIL:</u> MELDEN & HUNT

ELDEN & HUNI

STRUCTURAL: GREEN, RUBIANO & ASSOCIATES INC.

DBR ENGINEERING

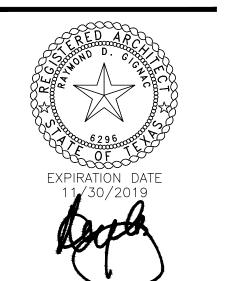




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UNIVERSITY CAMPUS

STUDENT RESTROOM RENOVATIONS



KEYPLAN

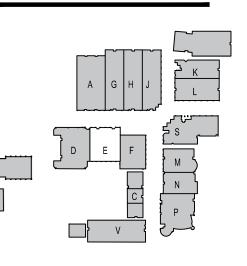
Project Number Drawing Date: Drawn: Checked: Scale: ACAD File:		
Revisions: 1 - ADD 1	- 5/24/19	

Sheet Title:


BUILDING E REFL. CLG. PLN. & ELRG,. FLRPLN.

ADD. 2 A-119-N


	FIXTURE MOUNTING HEIGHT SCHEDULE * REFER TO ADA GUIDELINES ON SHEET G-102.		ADULTS
1	1. LAVATORIES/SINK	STANDARD	32"
	(MEASURED FROM FLOOR TO RIM)	ACCESSIBLE	34" MAX (29" MIN KNEESPACE)
2	2. URINALS (MEASURED FROM FLOOR TO RIM)	STANDARD	16" MAX
	(MEASURED FROM FEOOR TO MIN)	ACCESSIBLE	17" MAX
3	3. WATER CLOSETS (MEASURED FROM FLOOR TO TOP OF SEAT)	STANDARD	15"
	(WEASONED THOM FEOOR TO TOT OF SEAT)	ACCESSIBLE	17" TO 19"
4	4. DRINKING FOUNTAINS AND EWC'S FRONTAL APPROACH	STANDARD	42"
	(MEASURED FROM FLOOR TO SPOUT OUTLET)	ACCESSIBLE	36" MAX (27" MIN KNEESPACE)
	5. GRAB BARS	STANDARD	
5	(MEASURED FROM FLOOR TO CENTERLINE OF BAR — 36" LONG @ REAR WALL & 42" LONG @ SIDE WALL OR 90 DEGRESS CONT. GRAB BAR WHERE INDICATED	ACCESSIBLE	33" TO 36" TO TOP OF GRAB BAR
	6. TOILET TISSUE DISPENSER	STANDARD	20"
6	(MEASURED FROM FLOOR TO CENTERLINE OF ROLL)	ACCESSIBLE	19" MIN
7	7. ELECTRIC HAND DRYER	STANDARD	48"
	(MEASURED FROM FLOOR TO CENTER OF CONTROL)	ACCESSIBLE	45" MAX
8	8. SOAP DISPENSER	STANDARD	38"
0	(MEASURED FROM FLOOR TO CENTERLINE OF PUSH BUTTON)	ACCESSIBLE	38"
9	9. SANITARY NAPKIN DISPOSAL UNIT	STANDARD	40"
,	(MEASURED FROM FLOOR TO TOP OF UNIT) (ONLY IN ROOMS LABELED WOMEN & GIRLS)	ACCESSIBLE	
10	10. MIRRORS	STANDARD	
	1 MIRROR PER LAVATORY (NOT NOTED FOR CLARITY). MEASURED FROM FLOOR TO	ACCESSIBLE	40" MAX
	BOTTOM OF REFLECTING SURFACE.		
11	11. MOP BASIN / SERVICE SINK (ONE PER ROOM LABELED CUSTODIAN)		
12	12. MOP HOLDER (ONE PER ROOM LABELED CUSTODIAN)		48" MAX
13	13. TOILET PARTITION / URINAL SCREEN	NOT NOTE) FOR CLARITY

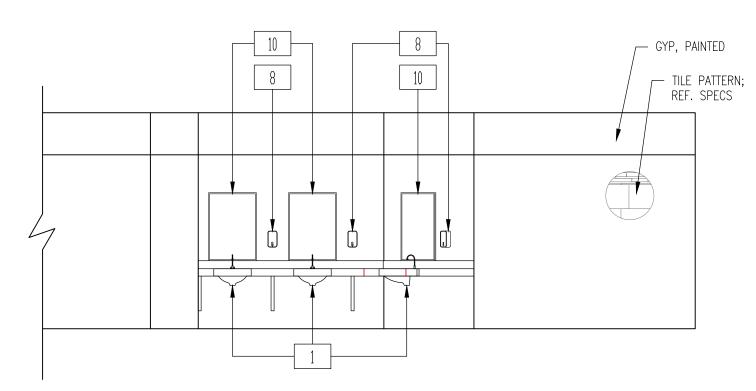




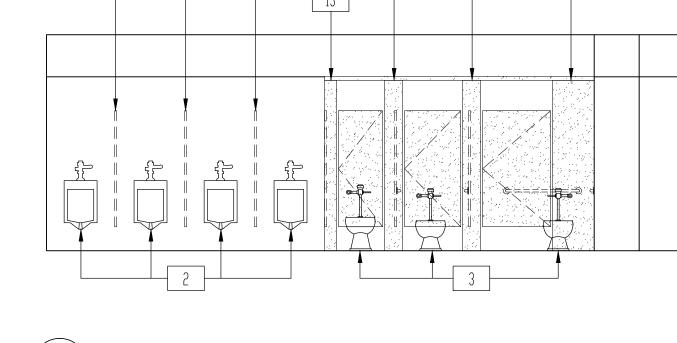





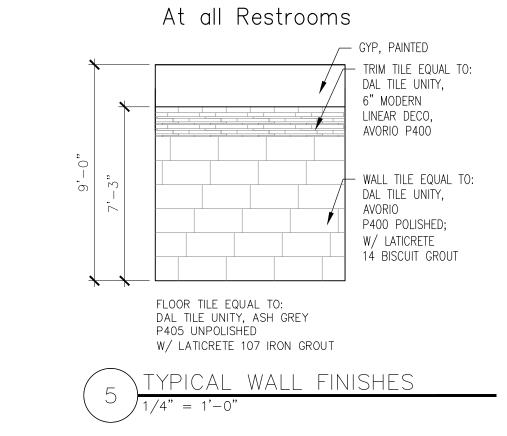

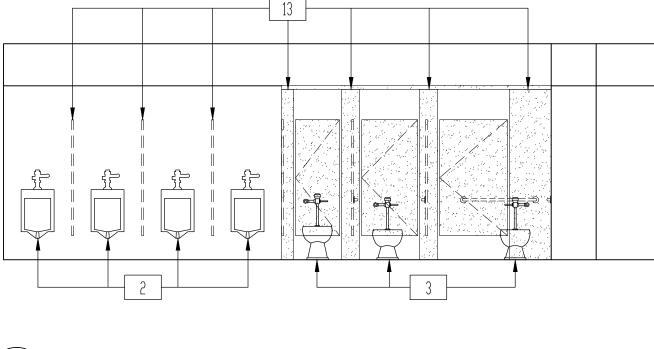



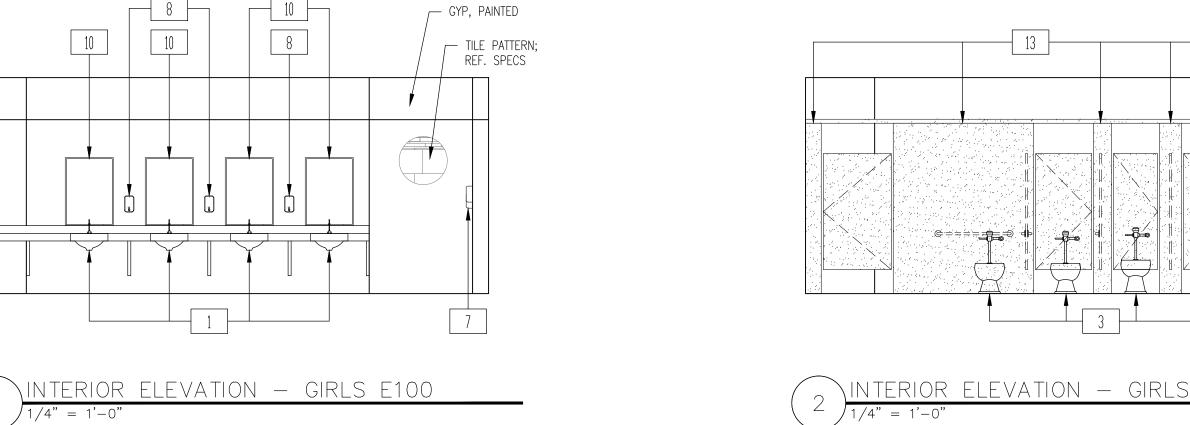

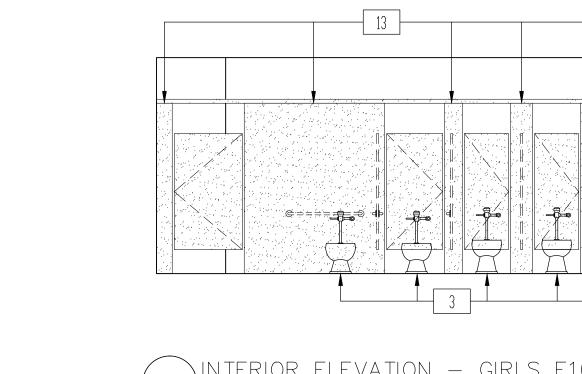

2 INTERIOR ELEVATION - GIRLS E100

GIGNAC | ARCHITECTS

416 STARR STREET CORPUS CHRISTI, TEXS 78401 T 361.884.2661 F 361.884.4232

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3700 N. 10TH, SUITE 205 McALLEN, TEXAS 78501 T 956.686.0100 F 956.622.7313

Consultants:

MELDEN & HUNT

STRUCTURAL: GREEN, RUBIANO & ASSOCIATES INC.

DBR ENGINEERING






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NORTH ECHS & COLLEGE AND

UNIVERSITY **CAMPUS**

STUDENT RESTROOM RENOVATIONS

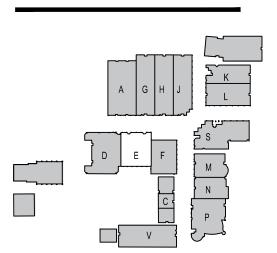

KEYPLAN

Project Number: 19.04 Drawing Date: MAY 10, 2019 Drawn: Checked: VARIES Scale: ACAD File: DEMO PLAN Revisions:

<u>1</u> - ADD 1 - 5/24/19

BUILDING E INTERIOR ELEVATION

ADD. 2 A-120-N

- 1. DEMOLITION AND PROPOSED WORK WILL HAVE TO BE COORDINATED WITH THE OWNER TO MINIMIZE DISRUPTIONS TO THE CAMPUS, WHICH MAY BE IN USE.
- 2. ANY EXISTING WALLS TO REMAIN THAT REQUIRE REPAIR AFTER DEMOLITION IS COMPLETE, SHALL BE OBSERVED BY THE DESIGN TEAM AND OWNER PRIOR TO REPAIR. COORDINATION WILL BE REQUIRED.
- 3. ANY OPENINGS IN EXISTING WALLS SCHEDULED TO BE INFILLED SHALL HAVE THE SAME MATERIAL AND FINISH AS THAT OF THE EXISTING WALL. ALL INFILLED OPENINGS SHALL BE FLUSH WITH EXISTING WALL SURFACES AND PAINTED.

					ROOM FINISH	SCHEDULE				
NUMBER	NAME	FLOOR	BASE	NORTH WALL	SOUTH WALL	EAST WALL	WEST WALL	CEILING	CLG HT.	NOTES
A100	GIRLS	TILE: UNITY ASH GREY	TILE: UNITY AVORIO/PT	GYP. PTD.	9'-0"					
A101	BOYS	TILE: UNITY ASH GREY	TILE: UNITY AVORIO/PT	GYP. PTD.	9'-0"					
A102	JANITOR	SEALED CONCRETE	NDNE	PT	PT	PT	PT	EXP STRUC		PAINT EXPOSED STRUCTURE & DECK
G100	GIRLS	TILE: UNITY ASH GREY	TILE: UNITY AVORIO/PT	GYP. PTD.	9'-0"					
G101	BOA2	TILE: UNITY ASH GREY	TILE: UNITY AVORIO/PT	GYP. PTD.	9'-0"					
G102	STORAGE	SEALED CONCRETE	NDNE	PT	PT	PT	PT	EXP STRUC		PAINT EXPOSED STRUCTURE & DECK
G103	STORAGE	SEALED CONCRETE	NDNE	PT	PT	PT	PT	EXP STRUC		PAINT EXPOSED STRUCTURE & DECK
H100	GIRLS	TILE: UNITY ASH GREY	TILE: UNITY AVORIO/PT	GYP. PTD.	9'-0"					
H101	BOYS	TILE: UNITY ASH GREY	TILE: UNITY AVORIO/PT	GYP. PTD.	9'-0"					
H102	STORAGE	SEALED CONCRETE	NDNE	PT	PT	PT	PT	EXP STRUC		PAINT EXPOSED STRUCTURE & DECK
H103	STORAGE	SEALED CONCRETE	NDNE	PT	PT	PT	PT	EXP STRUC		PAINT EXPOSED STRUCTURE & DECK
J100	GIRLS	TILE: UNITY ASH GREY	TILE: UNITY AVORIO/PT	GYP. PTD.	9'-0"					
J101	BOYS	TILE: UNITY ASH GREY	TILE: UNITY AVORIO/PT	GYP. PTD.	9'-0"					
J102	STORAGE	SEALED CONCRETE	NDNE	PT	PT	PT	PT	EXP STRUC		PAINT EXPOSED STRUCTURE & DECK
J103	STORAGE	SEALED CONCRETE	NONE	PT	PT	PT	PT	EXP STRUC		PAINT EXPOSED STRUCTURE & DECK

JAN A102 BOYS A100 BOYS A101 BOYS A101 BOYS A101 BOYS BOYS A101 BOYS BOYS A101 BOYS BO			
GRLS GRLS GIO	HIO3	GIRLS J100	
2 A-123N			
STOR STORE GOOD	3 A-123N	1 A-124N	2 A-124N

DOOR			DOOR		F	RAME	
SCHEDULE	WIDTH	HEIGHT	TYPE	MATERIAL	TYPE	MATERIAL	REMARKS
A100A	3'-0"	7′-0″	FL	WD	Α	НМ	FIELD VERIFY EXISTING OPENING
A100B	3'-0"	7′-0″	FL	WD	Α	НМ	FIELD VERIFY EXISTING OPENING
A101A	3'-0"	7′-0″	FL	WD	Α	НМ	FIELD VERIFY EXISTING OPENING
A101B	3'-0"	7′-0″	FL	WD	Α	НМ	FIELD VERIFY EXISTING OPENING
A102	3'-0"	7′-0″	FL	WD	Α	НМ	FIELD VERIFY EXISTING OPENING
G100	3'-0"	7′-0″	FL	WD	А	НМ	
G101	3'-0"	7′-0″	FL	WD	Α	НМ	
G102	3'-0"	7′-0″	FL	WD	Α	НМ	
G103	3'-0"	7′-0″	FL	WD	Α	НМ	
H100	3'-0"	7′-0″	FL	WD	Α	НМ	
H101	3'-0"	7′-0″	FL	WD	Α	НМ	
H102	3'-0"	7′-0″	FL	WD	Α	НМ	
H103	3'-0"	7′-0″	FL	WD	Α	НМ	
J100	3'-0"	7′-0″	FL	WD	Α	НМ	
J101	3'-0"	7′-0″	FL	WD	Α	НМ	
J102	3'-0"	7′-0″	FL	WD	Α	НМ	
J103	3'-0"	7′-0″	FL	WD	Α	НМ	



416 STARR STREET CORPUS CHRISTI, TEXS 78401 T 361.884.2661 F 361.884.4232

F 361.884.4232 222 E. VAN BUREN, SUITE 102 HARLINGEN, TEXAS 78550 T 956.365.4820

3700 N. 10TH, SUITE 205 MCALLEN, TEXAS 78501 T 956.686.0100 F 956.622.7313


F 956.365.4822

Consultants:

MELDEN & HUNT
STRUCTURAL:

GREEN, RUBIANO & ASSOCIATES INC.

MEP: DBR ENGINEERING

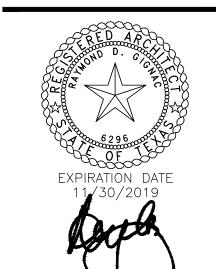



SIGNED: 05/10/2019


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NORTH ECHS & COLLEGE

UNIVERSITY CAMPUS

AND

STUDENT RESTROOM RENOVATIONS

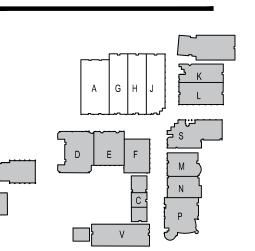

KEYPLAN

Project Number: 19.04
Drawing Date: MAY 10, 2019
Drawn: CQ
Checked: JM
Scale: VARIES
ACAD File: DEMO PLAN


Revisions: 1 - ADD 1 - 5/24/19


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BLDG A-G-H-J FLOORPLAN


ADD. 2 A-121-N


FLOORPLAN - BUILDING A-G-H-J



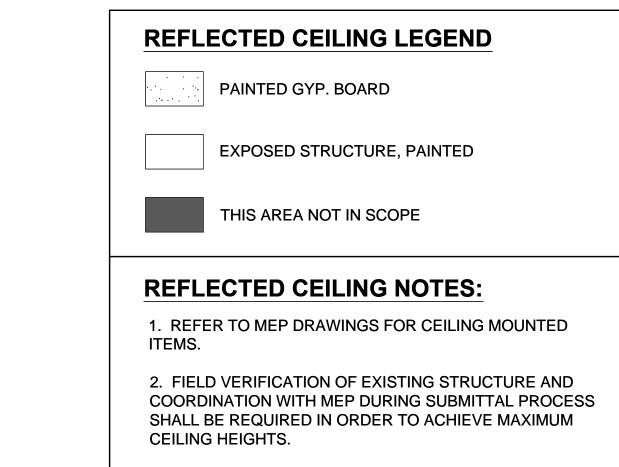

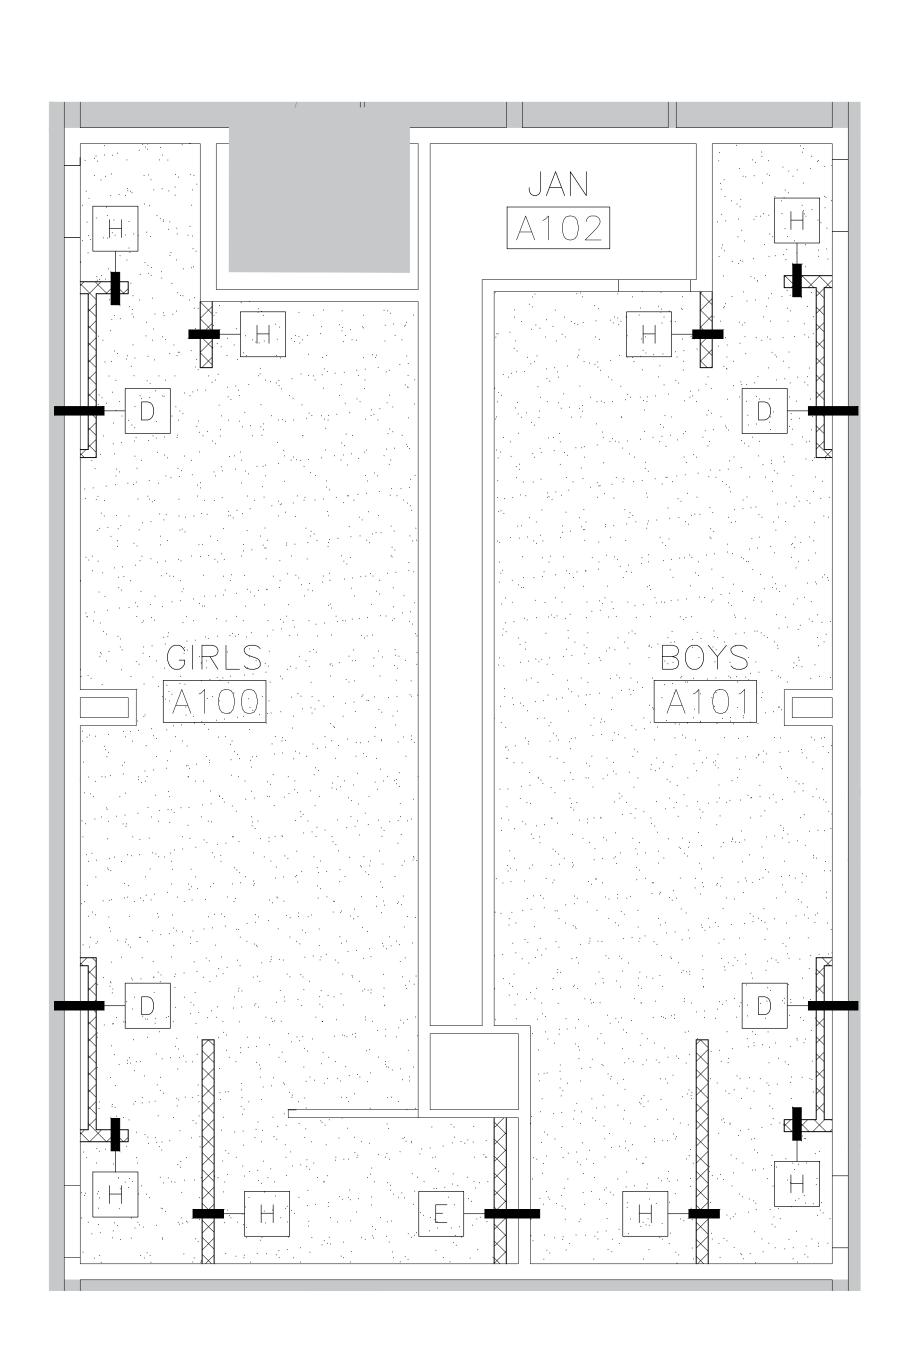REFLECTED CEILING PLAN - BUILDING A

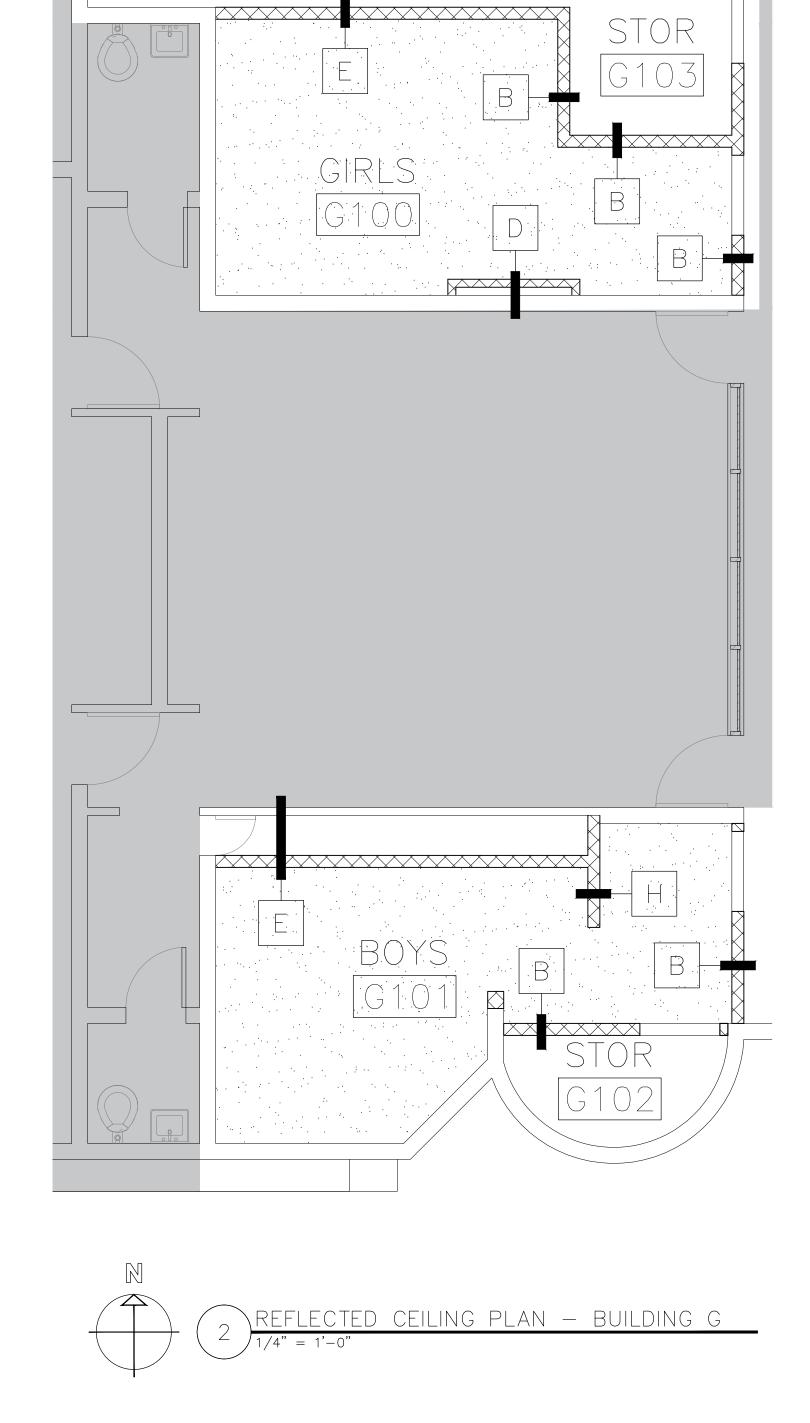

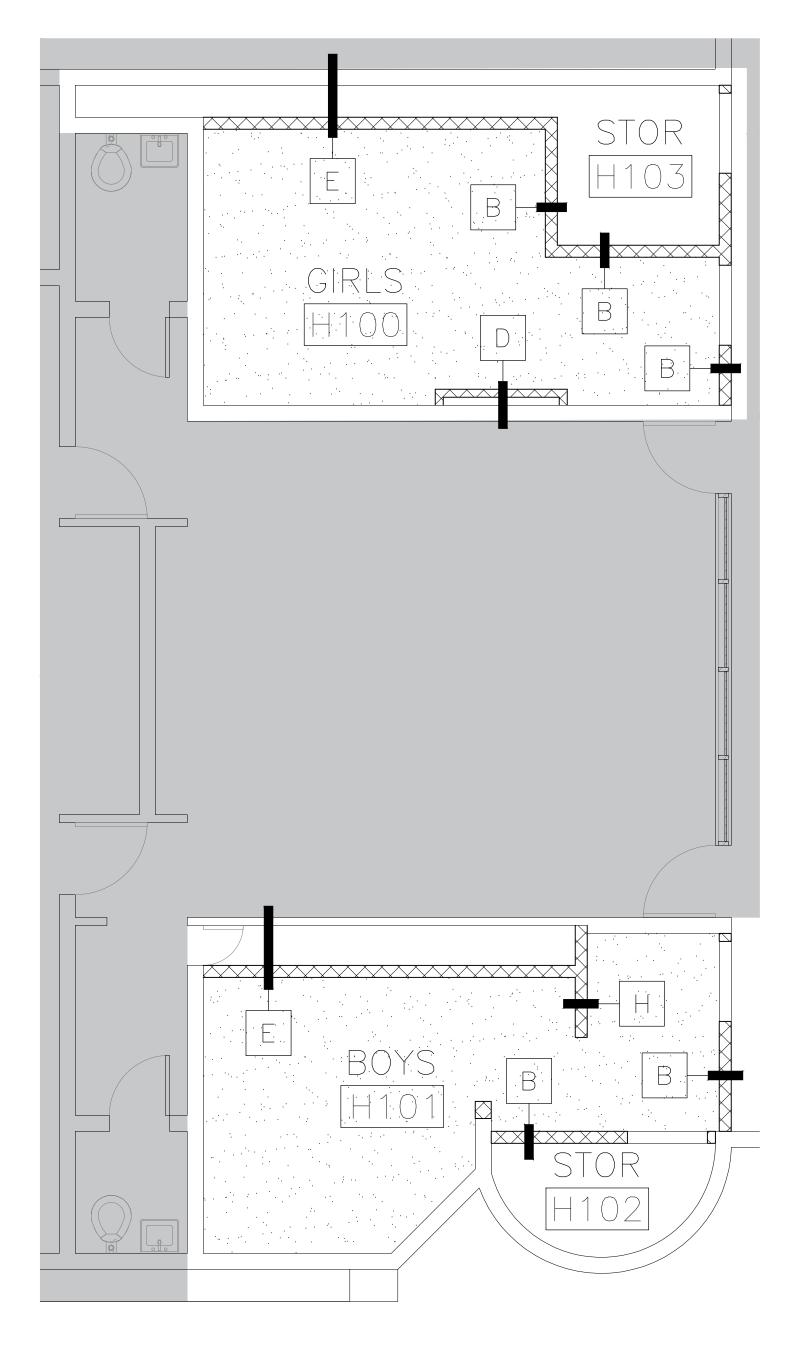



GIGNAC | ARCHITECTS

416 STARR STREET CORPUS CHRISTI, TEXS 78401 T 361.884.2661 F 361.884.4232

T 956.365.4820 F 956.365.4822 3700 N. 10TH, SUITE 205 MCALLEN, TEXAS 78501 T 956.686.0100

F 956.622.7313


222 E. VAN BUREN, SUITE 102 HARLINGEN, TEXAS 78550

Consultants:

<u>CIVIL:</u> MELDEN & HUNT

STRUCTURAL:
GREEN, RUBIANO &
ASSOCIATES INC.

MEP: DBR ENGINEERING

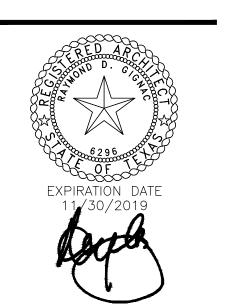




SIGNED: 05/10/2019

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KEYPLAN

Project Number: 19.04
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ACAD File: DEMO PLAN

Revisions:

1 - ADD 1 - 5/24/19

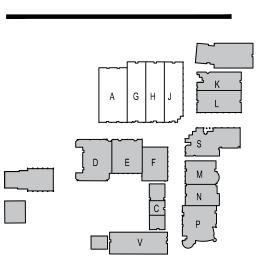Sheet Title:

BLDG. A-G-H-J REFLECTED CEILING PLAN


ADD. 2 A-122-N


	FIXTURE MOUNTING HEIGHT SCHEDULE * REFER TO ADA GUIDELINES ON SHEET G-102.		ADULTS
1	LAVATORIES/SINK (MEASURED FROM FLOOR TO RIM)	STANDARD	32"
	(MLASUKLD TROM TLOOK TO KIM)	ACCESSIBLE	34" MAX (29" MIN KNEESPACE
2	2. URINALS (MEASURED FROM FLOOR TO RIM)	STANDARD	16" MAX
	(MEAGONED THOM TEGON TO MIM)	ACCESSIBLE	17" MAX
3	3. WATER CLOSETS (MEASURED FROM FLOOR TO TOP OF SEAT)	STANDARD	15"
	(MEASURED FROM FEOOR TO TOT OF SEAT)	ACCESSIBLE	17" TO 19"
4	4. DRINKING FOUNTAINS AND EWC'S	STANDARD	42"
	FRONTAL APPROACH (MEASURED FROM FLOOR TO SPOUT OUTLET)	ACCESSIBLE	36" MAX (27" MIN KNEESPACE)
	5. GRAB BARS	STANDARD	
5	(MEASURED FROM FLOOR TO CENTERLINE OF BAR — 36" LONG @ REAR WALL & 42" LONG @ SIDE WALL OR 90 DEGRESS CONT. GRAB BAR WHERE INDICATED	ACCESSIBLE	33" TO 36" TO TOP OF GRAB BAR
	6. TOILET TISSUE DISPENSER	STANDARD	20"
6	(MEASURED FROM FLOOR TO CENTERLINE OF ROLL)	ACCESSIBLE	19" MIN
7	7. ELECTRIC HAND DRYER	STANDARD	48"
	(MEASURED FROM FLOOR TO CENTER OF CONTROL)	ACCESSIBLE	45" MAX
8	8. SOAP DISPENSER	STANDARD	38"
0	(MEASURED FROM FLOOR TO CENTERLINE OF PUSH BUTTON)	ACCESSIBLE	38"
9	9. SANITARY NAPKIN DISPOSAL UNIT	STANDARD	40"
,	(MEASURED FROM FLOOR TO TOP OF UNIT) (ONLY IN ROOMS LABELED WOMEN & GIRLS)	ACCESSIBLE	
10	10. MIRRORS	STANDARD	
	1 MIRROR PER LAVATORY (NOT NOTED FOR CLARITY). MEASURED FROM FLOOR TO BOTTOM OF REFLECTING SURFACE.	ACCESSIBLE	40" MAX
11	11. MOP BASIN / SERVICE SINK (ONE PER ROOM LABELED CUSTODIAN)		
12	12. MOP HOLDER (ONE PER ROOM LABELED CUSTODIAN)		48" MAX
13	13. TOILET PARTITION / URINAL SCREEN	NOT NOTE	D FOR CLARITY


5'-0" (FIELD VERIFY)

5'-1"

12'-2"

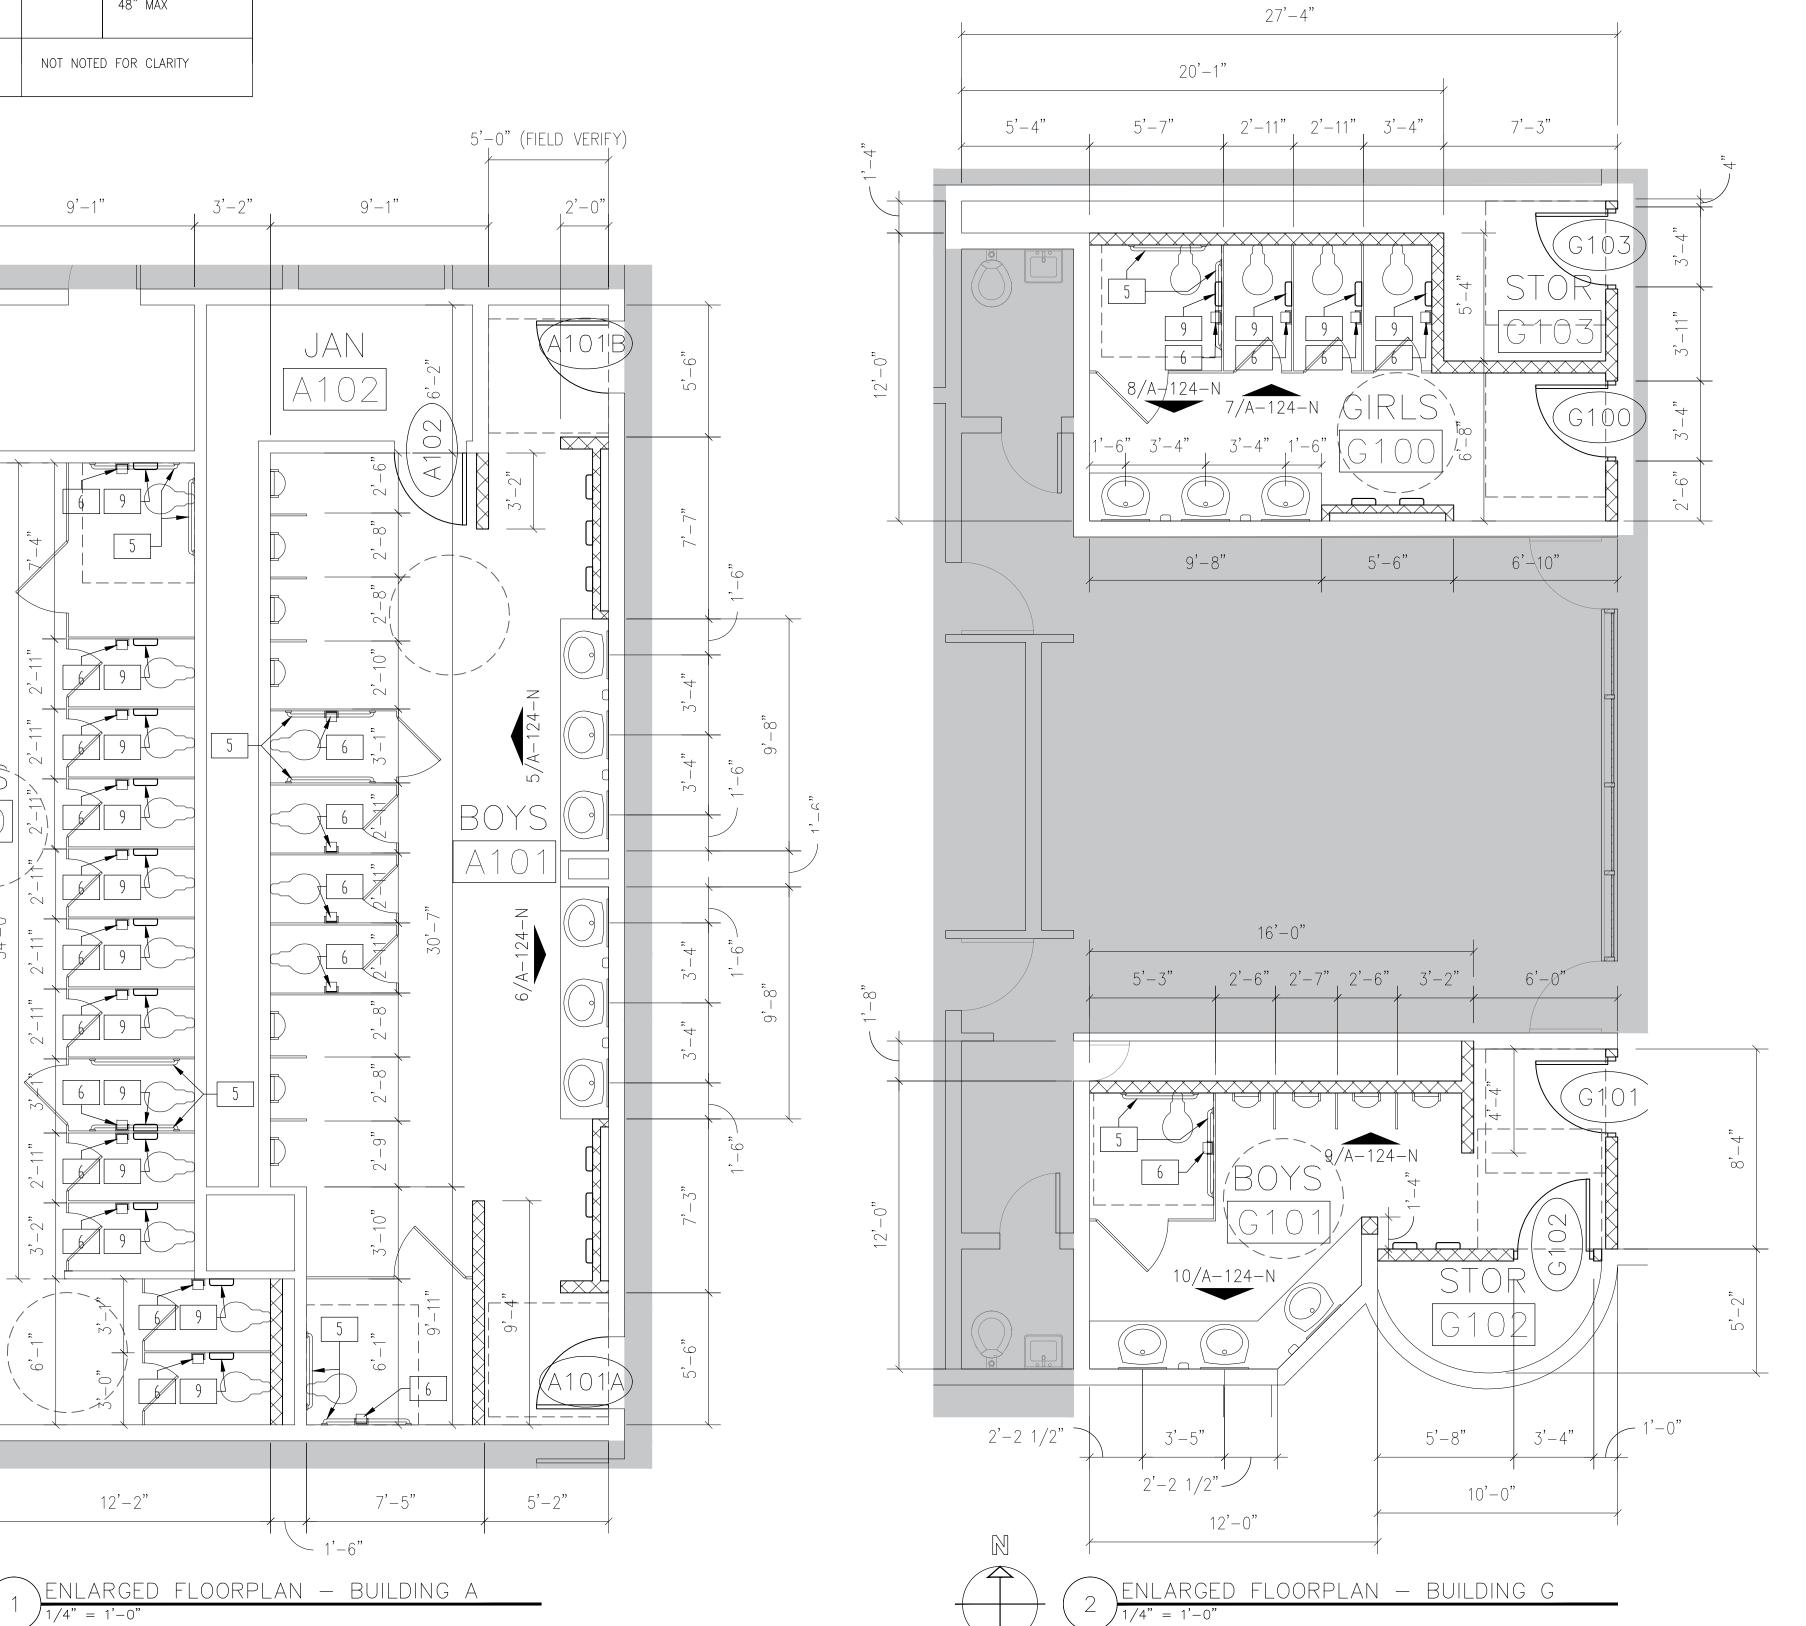

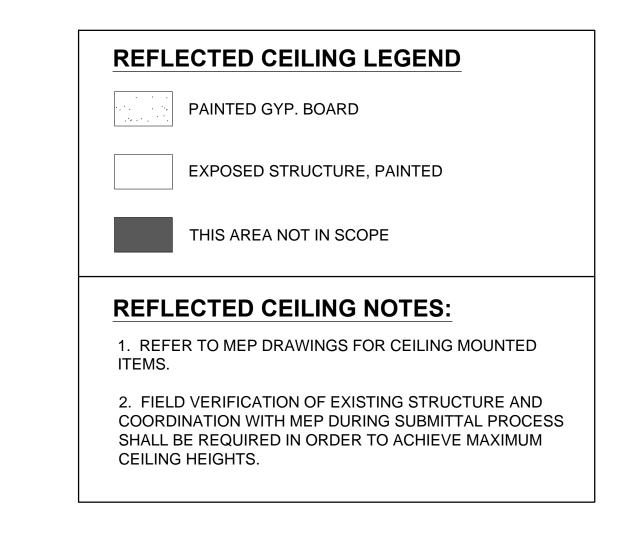

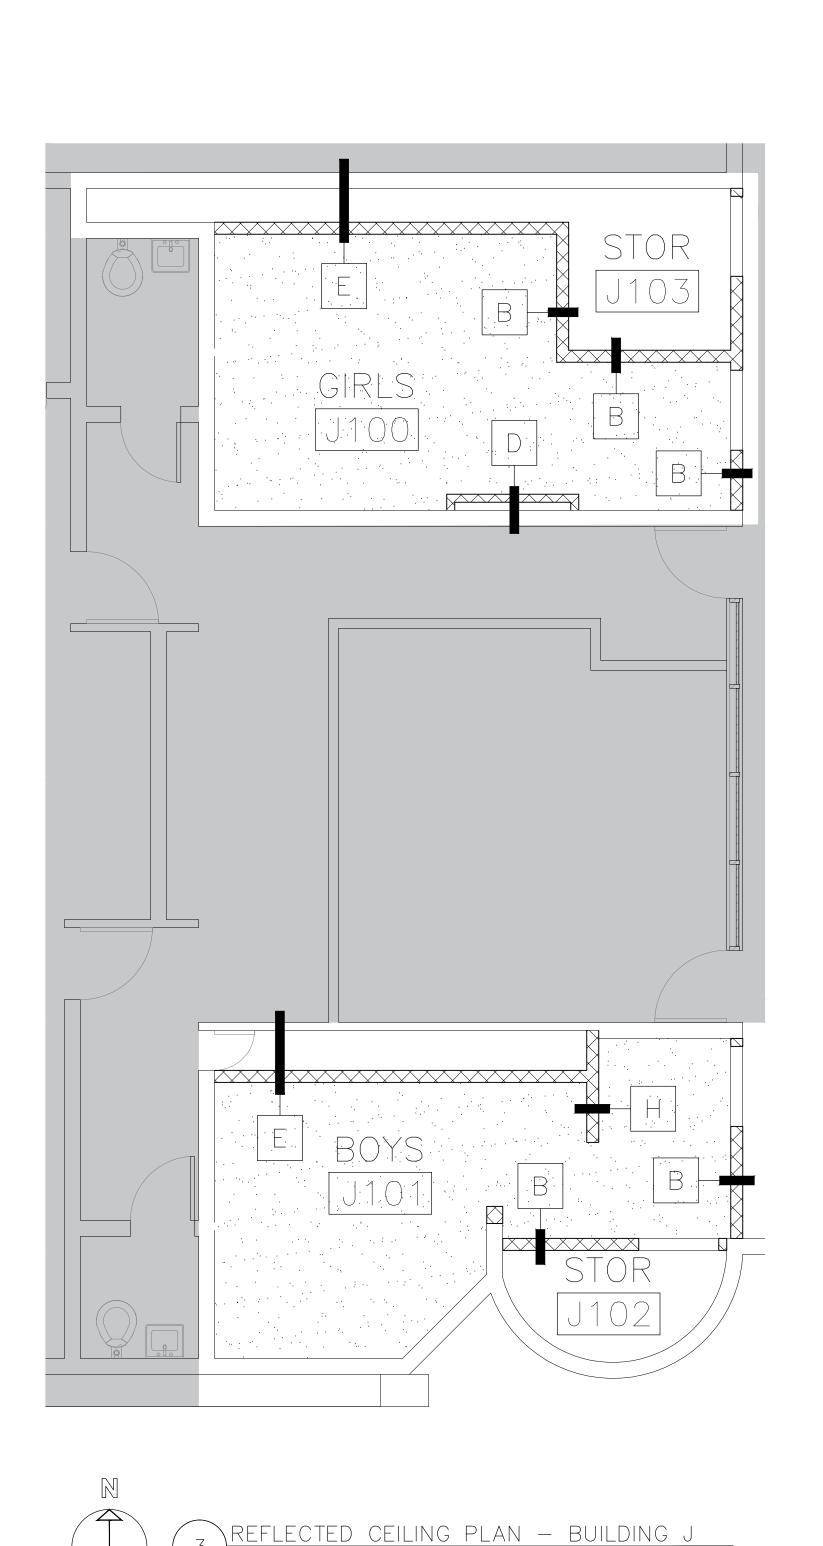



416 STARR STREET CORPUS CHRISTI, TEXS 78401 T 361.884.2661 F 361.884.4232

222 E. VAN BUREN, SUITE 102 HARLINGEN, TEXAS 78550 T 956.365.4820


F 956.365.4822 3700 N. 10TH, SUITE 205 McALLEN, TEXAS 78501 T 956.686.0100 F 956.622.7313

Consultants:

MELDEN & HUNT

STRUCTURAL: GREEN, RUBIANO & ASSOCIATES INC.

DBR ENGINEERING

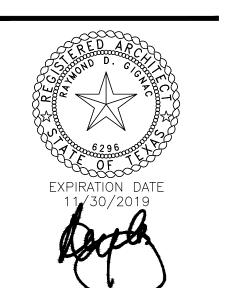




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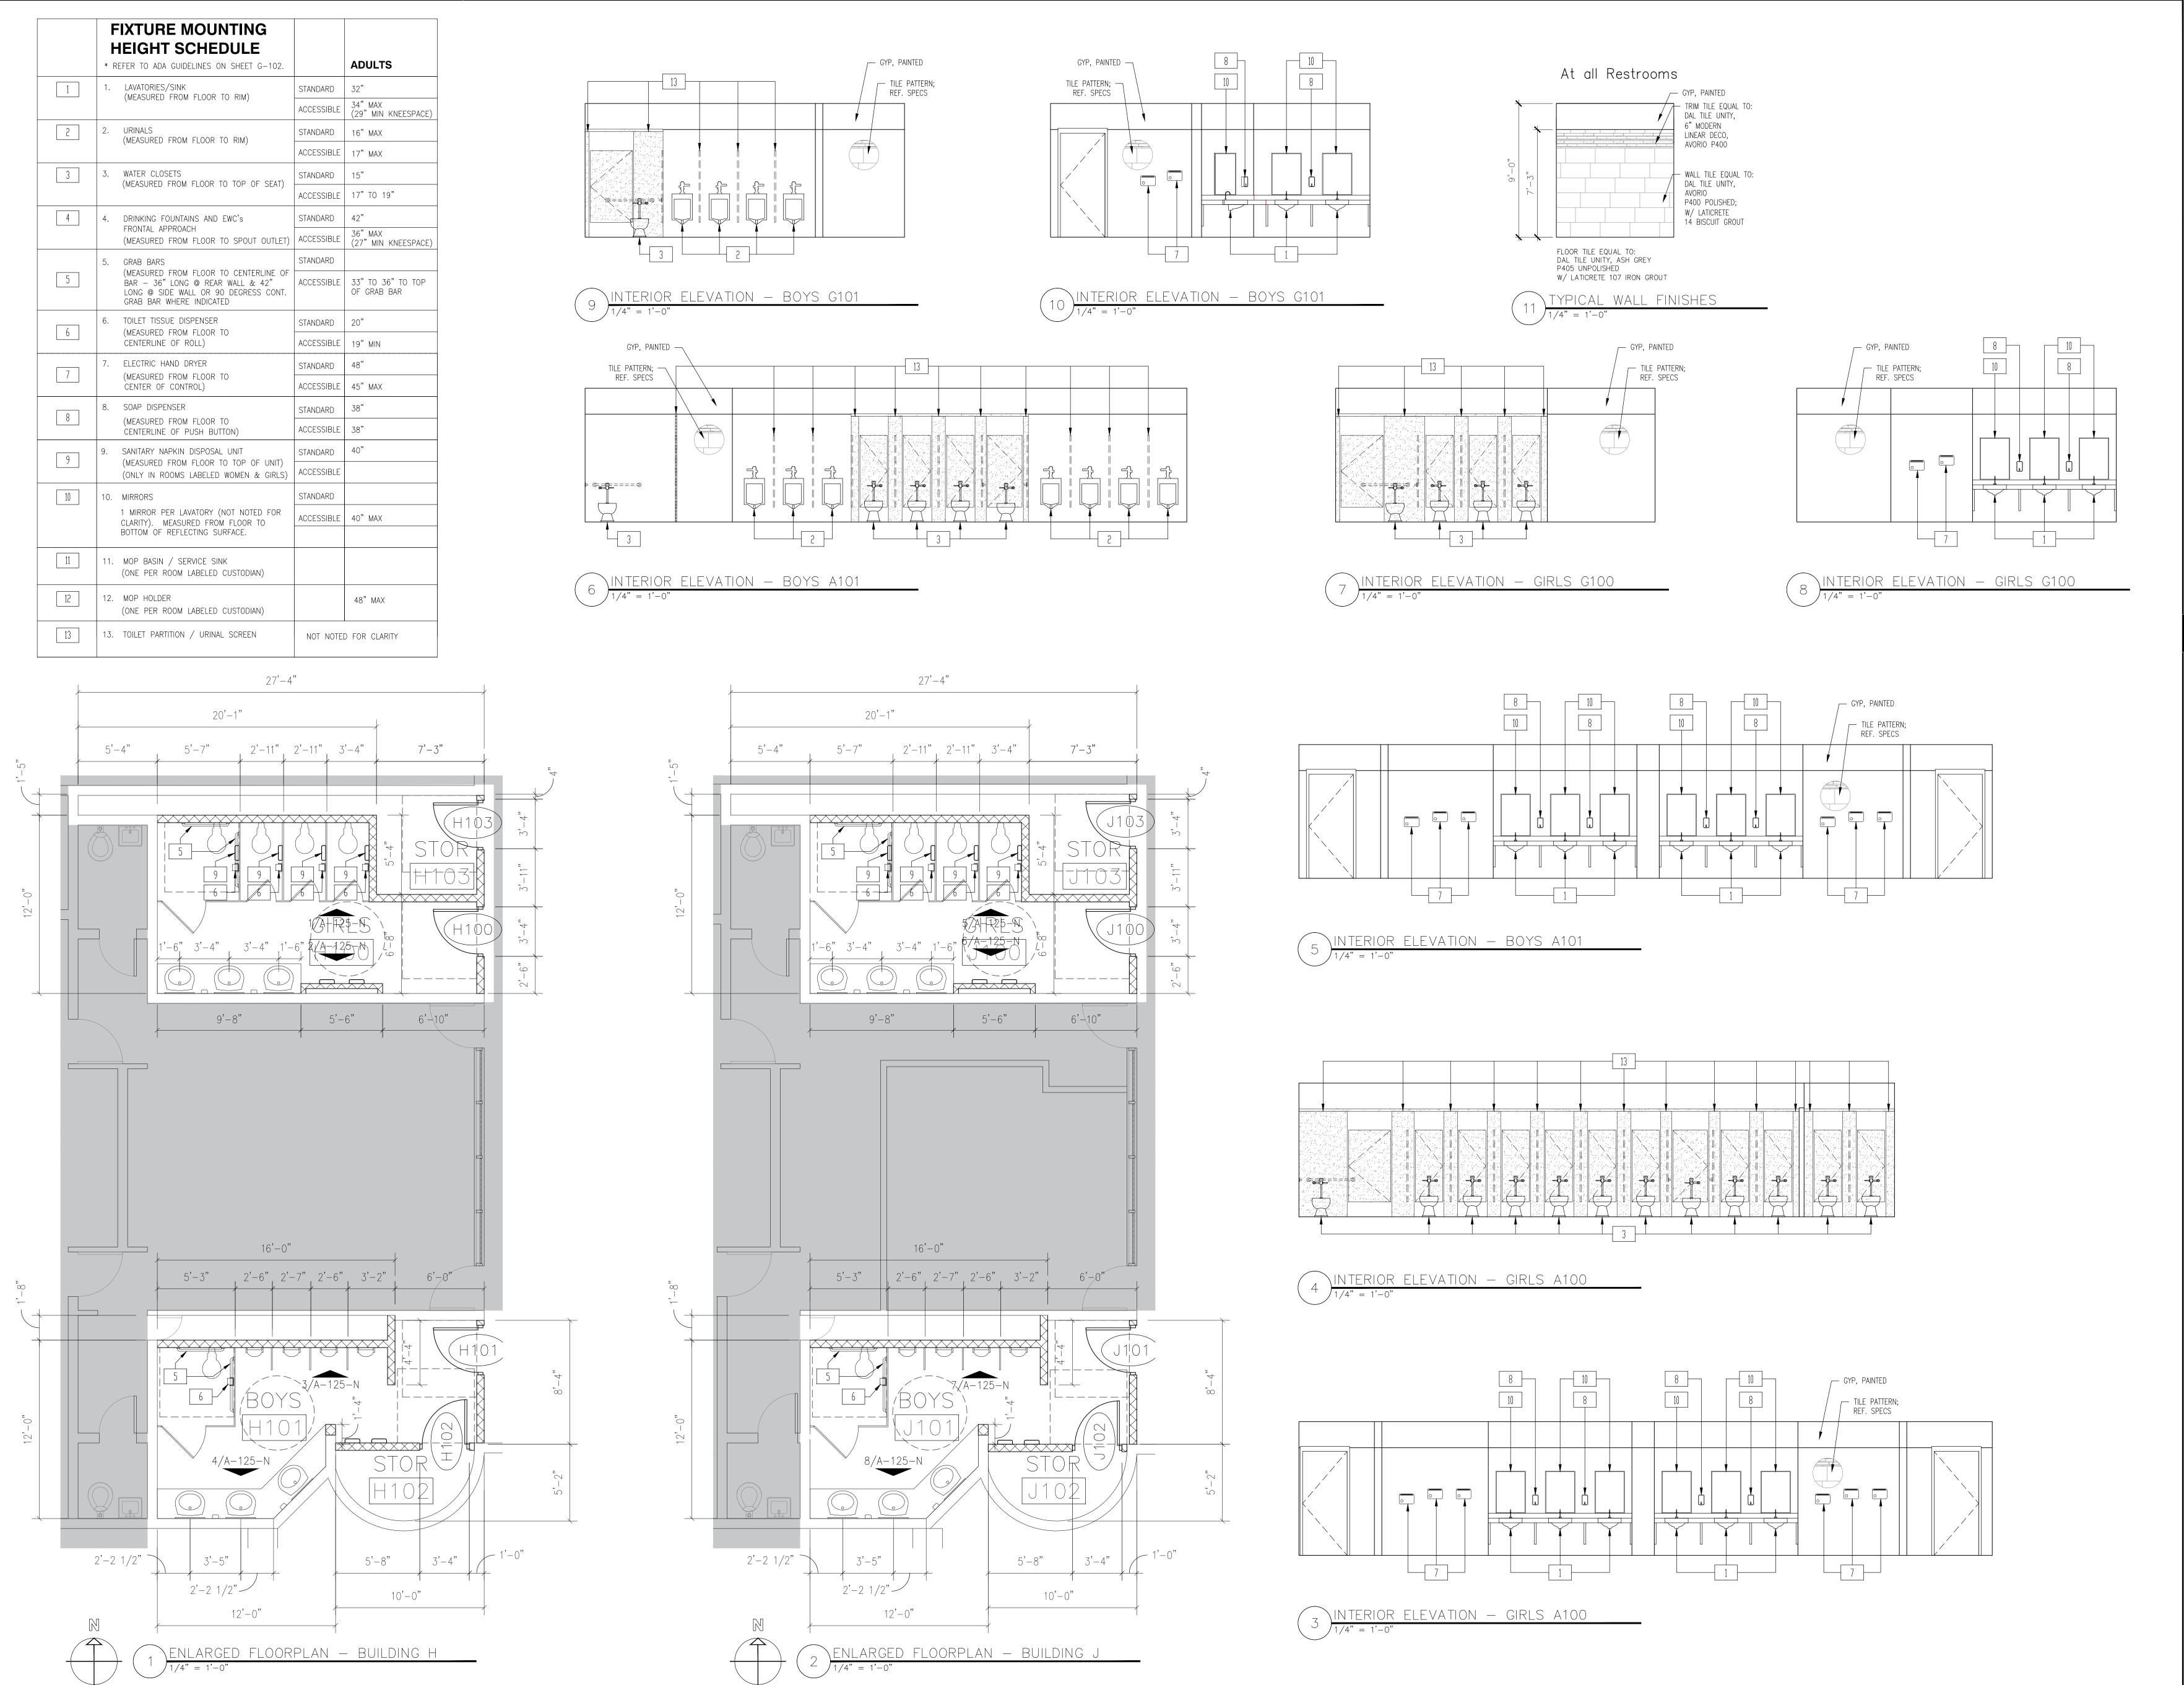
KEYPLAN

Project Number: Drawing Date: MAY 10, 2019 Checked: ACAD File: DEMO PLAN

Revisions: <u>1</u> - ADD 1 - 5/24/19

BLDG. A-G-H-J ENLRG. FLRPLN. & REFL. CLG. PLN.

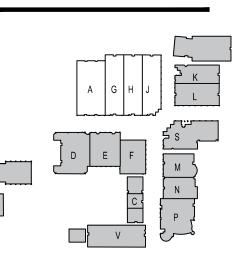ADD. 2 A-123-N



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416 STARR STREET CORPUS CHRISTI, TEXS 78401 T 361.884.2661 F 361.884.4232

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222 E. VAN BUREN, SUITE 102

HARLINGEN, TEXAS 78550

T 956.365.4820

F 956.365.4822

3700 N. 10TH, SUITE 205 MCALLEN, TEXAS 78501 T 956.686.0100 F 956.622.7313


Consultants:

MELDEN & HUNT

STRUCTURAL:
GREEN, RUBIANO &

ASSOCIATES INC.

MEP: DBR ENGINEERING

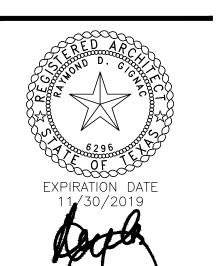




SIGNED: 05/10/2019

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KEYPLAN

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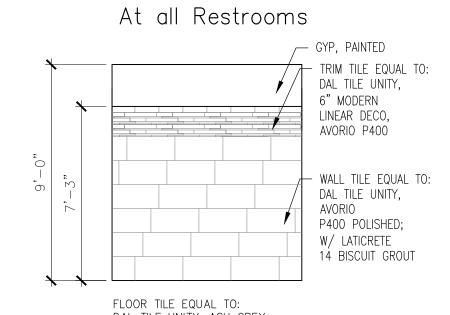
Revisions: 1 - ADD 1 - 5/24/19

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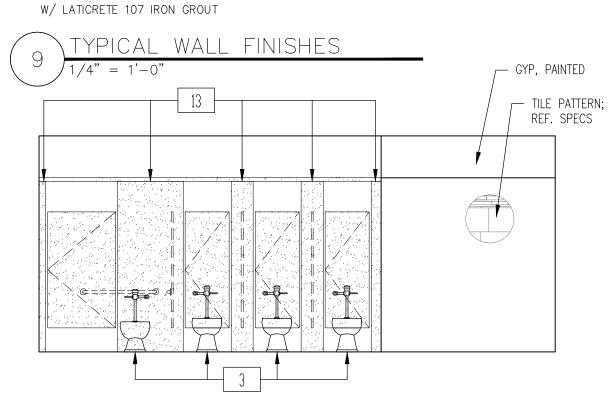
BLDG. A-G-H-J ENLRG. FLRPLN. & INT. ELEV.

ADD. 2 A-124-N

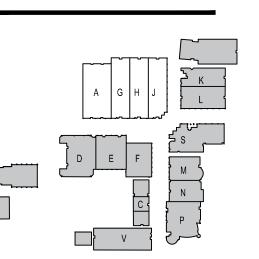
	FIXTURE MOUNTING HEIGHT SCHEDULE * REFER TO ADA GUIDELINES ON SHEET G-102.		ADULTS
1	1. LAVATORIES/SINK (MEASURED FROM FLOOR TO RIM)	STANDARD	32"
		ACCESSIBLE	34" MAX (29" MIN KNEESPACE)
2	2. URINALS (MEASURED FROM FLOOR TO RIM)	STANDARD	16" MAX
	, ,	ACCESSIBLE	17" MAX
3	3. WATER CLOSETS (MEASURED FROM FLOOR TO TOP OF SEAT)	STANDARD	15"
	(MEASONED FROM FEOSILIES OF SEAT)	ACCESSIBLE	17" TO 19"
4	4. DRINKING FOUNTAINS AND EWC's	STANDARD	42"
	FRONTAL APPROACH (MEASURED FROM FLOOR TO SPOUT OUTLET)	ACCESSIBLE	36" MAX (27" MIN KNEESPACE)
	5. GRAB BARS	STANDARD	
5	(MEASURED FROM FLOOR TO CENTERLINE OF BAR — 36" LONG @ REAR WALL & 42" LONG @ SIDE WALL OR 90 DEGRESS CONT. GRAB BAR WHERE INDICATED	ACCESSIBLE	33" TO 36" TO TOP OF GRAB BAR
	6. TOILET TISSUE DISPENSER	STANDARD	20"
6	(MEASURED FROM FLOOR TO CENTERLINE OF ROLL)	ACCESSIBLE	19" MIN
	7. ELECTRIC HAND DRYER	STANDARD	48"
7	(MEASURED FROM FLOOR TO CENTER OF CONTROL)	ACCESSIBLE	45" MAX
	8. SOAP DISPENSER	STANDARD	38"
8	(MEASURED FROM FLOOR TO CENTERLINE OF PUSH BUTTON)	ACCESSIBLE	38"
	9. SANITARY NAPKIN DISPOSAL UNIT	STANDARD	40"
9	(MEASURED FROM FLOOR TO TOP OF UNIT) (ONLY IN ROOMS LABELED WOMEN & GIRLS)	ACCESSIBLE	
10	10. MIRRORS	STANDARD	
	1 MIRROR PER LAVATORY (NOT NOTED FOR	ACCESSIBLE	40" MAX
	CLARITY). MEASURED FROM FLOOR TO BOTTOM OF REFLECTING SURFACE.		
11	11. MOP BASIN / SERVICE SINK (ONE PER ROOM LABELED CUSTODIAN)		
12	12. MOP HOLDER (ONE PER ROOM LABELED CUSTODIAN)		48" MAX
13	13. TOILET PARTITION / URINAL SCREEN	NOT NOTE	D FOR CLARITY




FLOOR TILE EQUAL TO: DAL TILE UNITY, ASH GREY P405 UNPOLISHED




 $(5) \frac{\text{INTERIOR ELEVATION - GIRLS J100}}{1/4" = 1'-0"}$

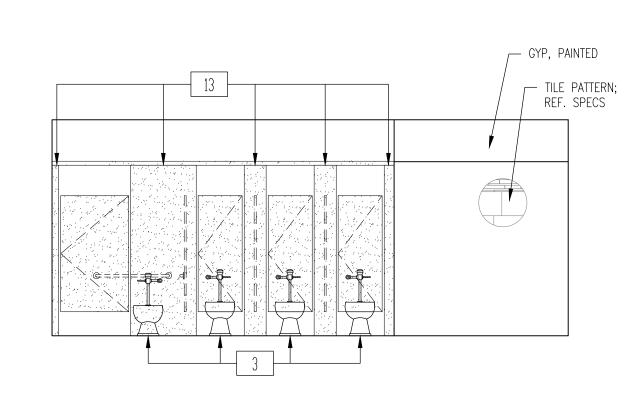

1 INTERIOR ELEVATION - GIRLS H100

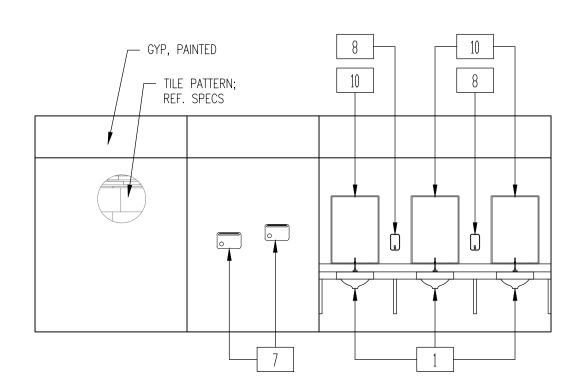


6 INTERIOR ELEVATION - GIRLS J100

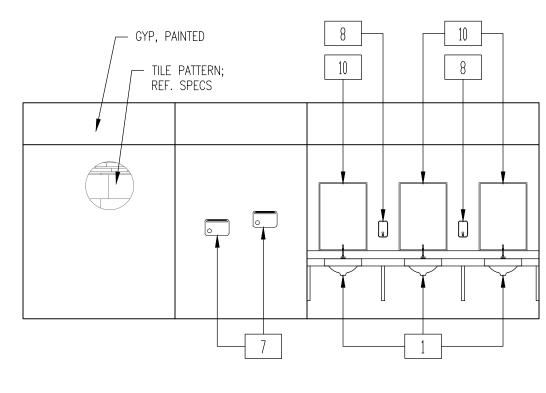


2 INTERIOR ELEVATION - GIRLS H100


1/4" = 1'-0"

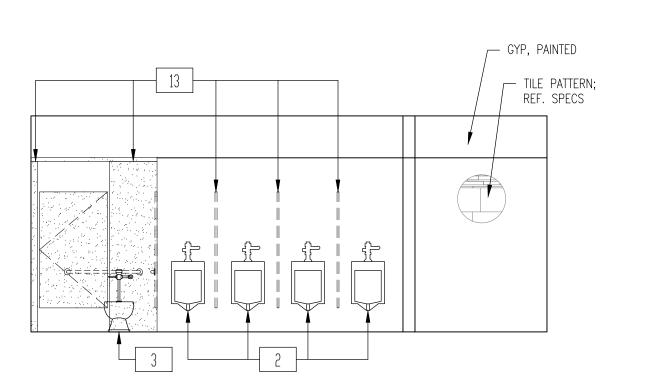


7 INTERIOR ELEVATION — BOYS J101

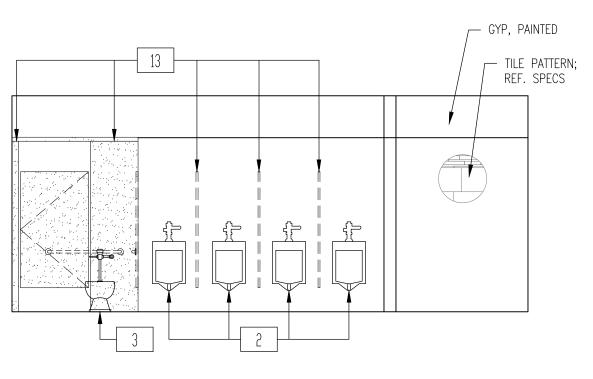

3 INTERIOR ELEVATION — BOYS H101

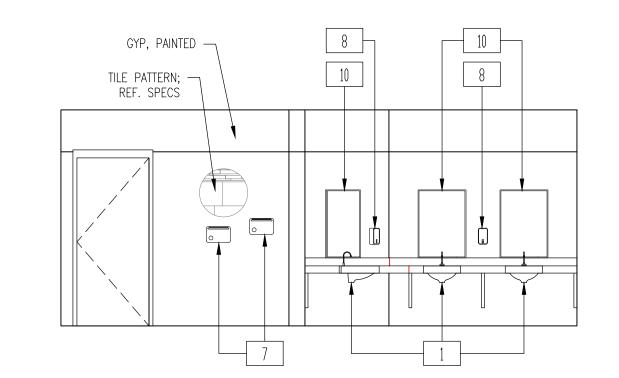

8 INTERIOR ELEVATION — BOYS J101

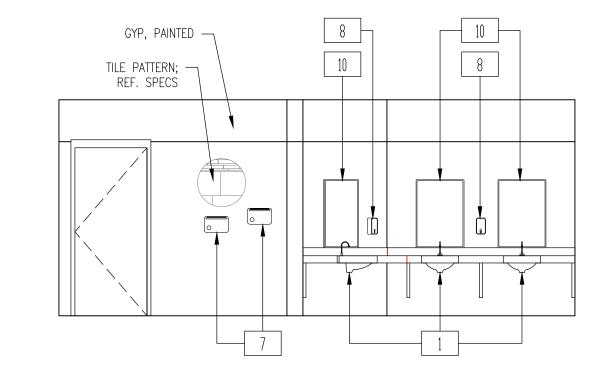

 $\begin{pmatrix} 4 \end{pmatrix}$ INTERIOR ELEVATION — BOYS H101

GIGNAC | ARCHITECTS

416 STARR STREET CORPUS CHRISTI, TEXS 78401 T 361.884.2661 F 361.884.4232

222 E. VAN BUREN, SUITE 102 HARLINGEN, TEXAS 78550 T 956.365.4820 F 956.365.4822

> 3700 N. 10TH, SUITE 205 MCALLEN, TEXAS 78501 T 956.686.0100 F 956.622.7313


Consultants:

<u>CIVIL:</u> MELDEN & HUNT

STRUCTURAL: GREEN, RUBIANO &

ASSOCIATES INC.

MEP: DBR ENGINEERING

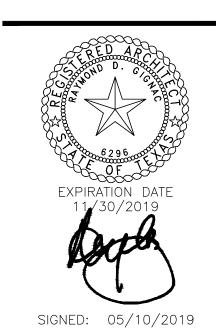




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STUDENT RESTROOM RENOVATIONS



KEYPLAN

Project Number: 19.04
Drawing Date: MAY 10, 2019
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Scale: VARIES
ACAD File: DEMO PLAN

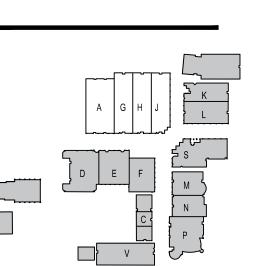Revisions:
1 - ADD 1 - 5/24/19

Sheet Title


BLDG. A-G-H-J INT. ELEV.

ADD. 2 A-125-N


- 1. DEMOLITION AND PROPOSED WORK WILL HAVE TO BE COORDINATED WITH THE OWNER TO MINIMIZE DISRUPTIONS TO THE CAMPUS, WHICH MAY BE IN USE.
- 2. ANY EXISTING WALLS TO REMAIN THAT REQUIRE REPAIR AFTER DEMOLITION IS COMPLETE, SHALL BE OBSERVED BY THE DESIGN TEAM AND OWNER PRIOR TO REPAIR. COORDINATION WILL BE REQUIRED.
- 3. ANY OPENINGS IN EXISTING WALLS SCHEDULED TO BE INFILLED SHALL HAVE THE SAME MATERIAL AND FINISH AS THAT OF THE EXISTING WALL. ALL INFILLED OPENINGS SHALL BE FLUSH WITH EXISTING WALL SURFACES AND PAINTED.

				DOOR	R SCH	HEDULE	
DOOR SCHEDULE	WIDTH	HEIGHT	DOOR TYPE	MATERIAL	TYPE	RAME MATERIAL	REMARKS
K100A	3'-0"	7′-0″	FL	WD	А	НМ	
K100B	3'-0"	7′-0″	FL	НМ	А	НМ	FIELD VERIFY EXISTING OPENING
K101	3'-0"	7′-0″	FL	НМ	А	НМ	
K102A	3'-0"	7′-0″	FL	WD	А	НМ	
K102B	3'-0"	7'-0"	FL	НМ	Α	НМ	FIELD VERIFY EXISTING OPENING


					ROOM FINISH	SCHEDULE				
NUMBER	NAME	FLOOR	BASE	NORTH WALL	SOUTH WALL	EAST WALL	WEST WALL	CEILING	CLG HT.	NDTES
K100	BDYS	TILE: UNITY ASH GREY	TILE: UNITY AVORIO/PT	GYP. PTD.	9'-0"					
K101	JANITOR	SEALED CONCRETE	NONE	PT	PT	PT	PT	EXP STRUC		PAINT EXPOSED STRUCTURE & DECK
K102	GIRLS	TILE: UNITY ASH GREY	TILE: UNITY AVORIO/PT	GYP, PTD,	9'-0"					

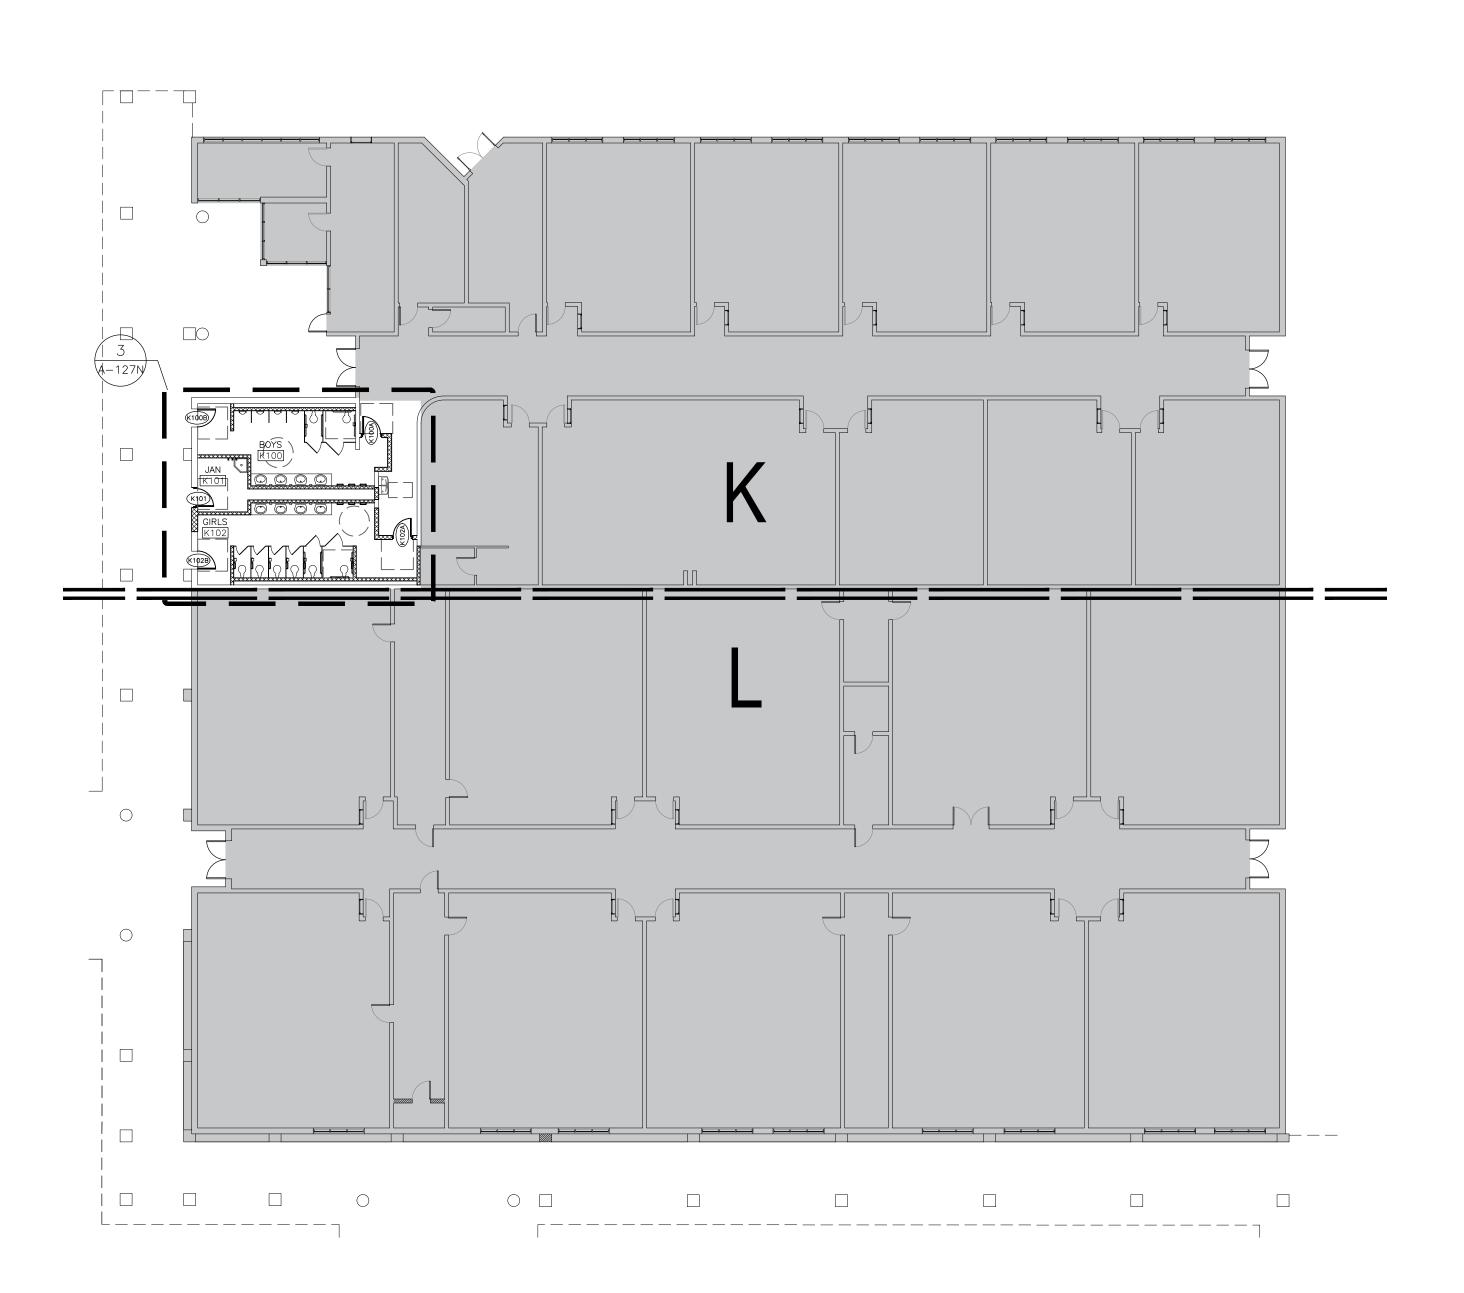



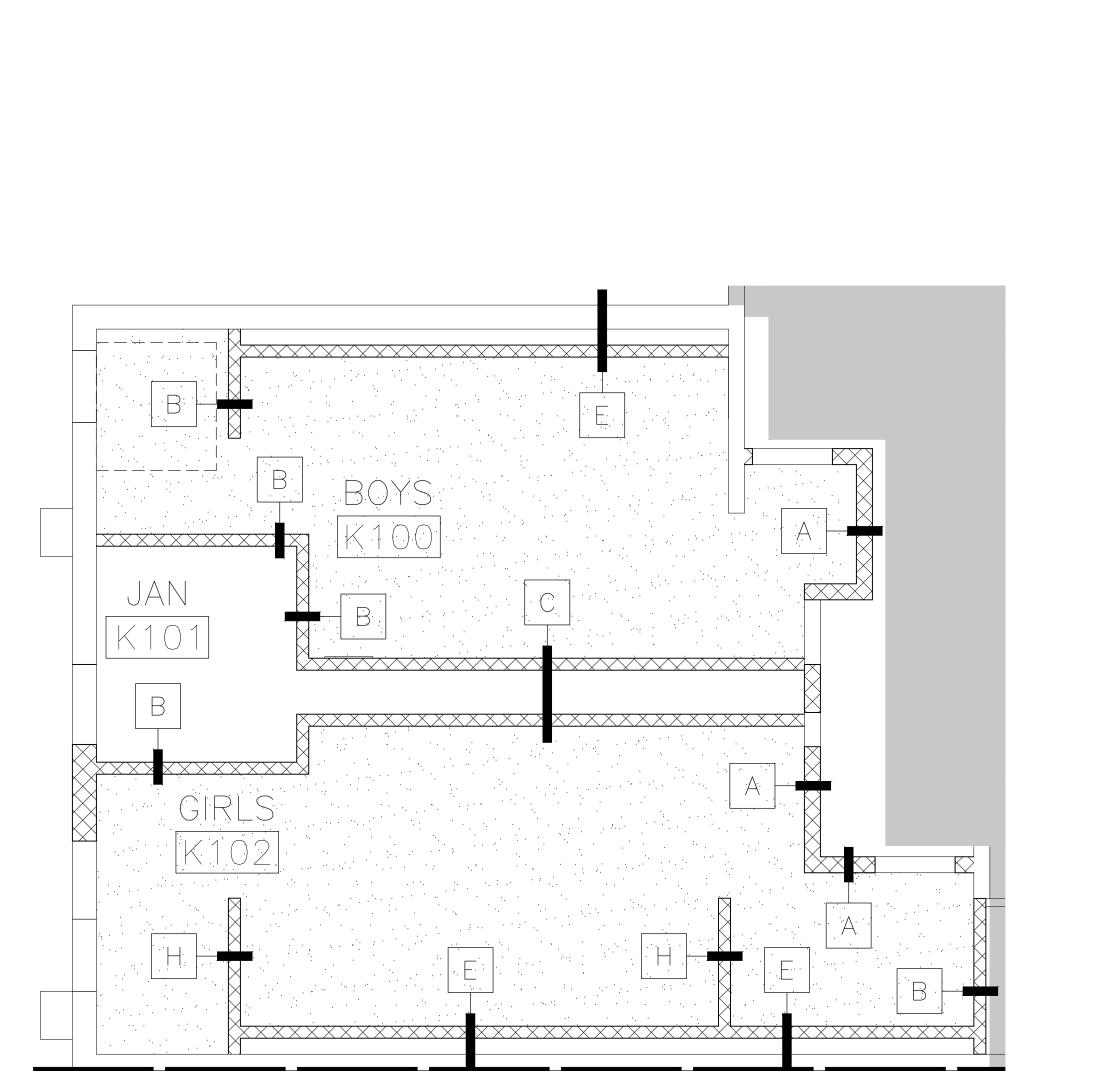

REFLECTED CEILING PLAN - BUILDING K

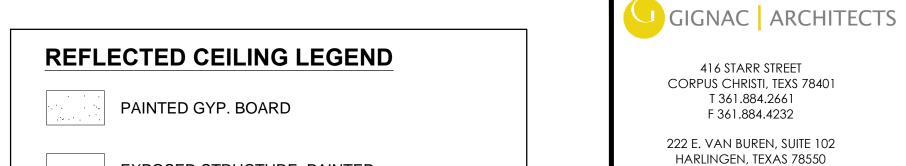

EXPOSED STRUCTURE, PAINTED

THIS AREA NOT IN SCOPE

REFLECTED CEILING NOTES:

1. REFER TO MEP DRAWINGS FOR CEILING MOUNTED ITEMS.

2. FIELD VERIFICATION OF EXISTING STRUCTURE AND COORDINATION WITH MEP DURING SUBMITTAL PROCESS SHALL BE REQUIRED IN ORDER TO ACHIEVE MAXIMUM CEILING HEIGHTS.

STRUCTURAL: GREEN, RUBIANO & ASSOCIATES INC. DBR ENGINEERING

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McALLEN, TEXAS 78501

T 956.686.0100

F 956.622.7313

Consultants:

MELDEN & HUNT




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STUDENT RESTROOM RENOVATIONS



KEYPLAN


Project Number: Drawing Date: MAY 10, 2019 Checked: Scale: ACAD File: DEMO PLAN

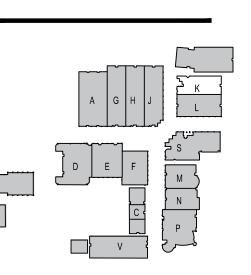Revisions: <u>1</u> - ADD 1 - 5/24/19

BUILDING K FLOORPLAN & REFL. CLG. PLN.


ADD. 2 A-126-N


	FIXTURE MOUNTING HEIGHT SCHEDULE * REFER TO ADA GUIDELINES ON SHEET G-102.		ADULTS
1	LAVATORIES/SINK (MEASURED FROM FLOOR TO RIM)	STANDARD	32"
	(METOORED TROM TEOOR TO RIMI)	ACCESSIBLE	34" MAX (29" MIN KNEESPACE)
2	2. URINALS (MEASURED FROM FLOOR TO RIM)	STANDARD	16" MAX
	(ACCESSIBLE	17" MAX
3	3. WATER CLOSETS (MEASURED FROM FLOOR TO TOP OF SEAT)	STANDARD	15"
	(MENSONED THOM FEOOR TO TOT OF SERT)	ACCESSIBLE	17" TO 19"
4	4. DRINKING FOUNTAINS AND EWC'S	STANDARD	42"
	FRONTAL APPROACH (MEASURED FROM FLOOR TO SPOUT OUTLET)	ACCESSIBLE	36" MAX (27" MIN KNEESPACE)
	5. GRAB BARS	STANDARD	
5	(MEASURED FROM FLOOR TO CENTERLINE OF BAR — 36" LONG @ REAR WALL & 42" LONG @ SIDE WALL OR 90 DEGRESS CONT. GRAB BAR WHERE INDICATED	ACCESSIBLE	33" TO 36" TO TOP OF GRAB BAR
	6. TOILET TISSUE DISPENSER	STANDARD	20"
6	(MEASURED FROM FLOOR TO CENTERLINE OF ROLL)	ACCESSIBLE	19" MIN
7	7. ELECTRIC HAND DRYER	STANDARD	48"
/	(MEASURED FROM FLOOR TO CENTER OF CONTROL)	ACCESSIBLE	45" MAX
8	8. SOAP DISPENSER	STANDARD	38"
0	(MEASURED FROM FLOOR TO CENTERLINE OF PUSH BUTTON)	ACCESSIBLE	38"
9	9. SANITARY NAPKIN DISPOSAL UNIT	STANDARD	40"
7	(MEASURED FROM FLOOR TO TOP OF UNIT) (ONLY IN ROOMS LABELED WOMEN & GIRLS)	ACCESSIBLE	
10	10. MIRRORS	STANDARD	
	1 MIRROR PER LAVATORY (NOT NOTED FOR CLARITY). MEASURED FROM FLOOR TO BOTTOM OF REFLECTING SURFACE.	ACCESSIBLE	40" MAX
11	11. MOP BASIN / SERVICE SINK (ONE PER ROOM LABELED CUSTODIAN)		
12	12. MOP HOLDER (ONE PER ROOM LABELED CUSTODIAN)		48" MAX
13	13. TOILET PARTITION / URINAL SCREEN	NOT NOTE) FOR CLARITY

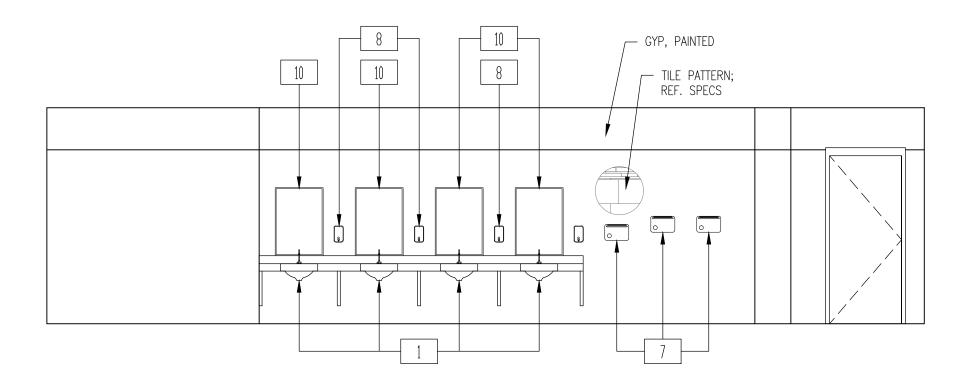


4 INTERIOR ELEVATION - GIRLS K102

1/4" = 1'-0"

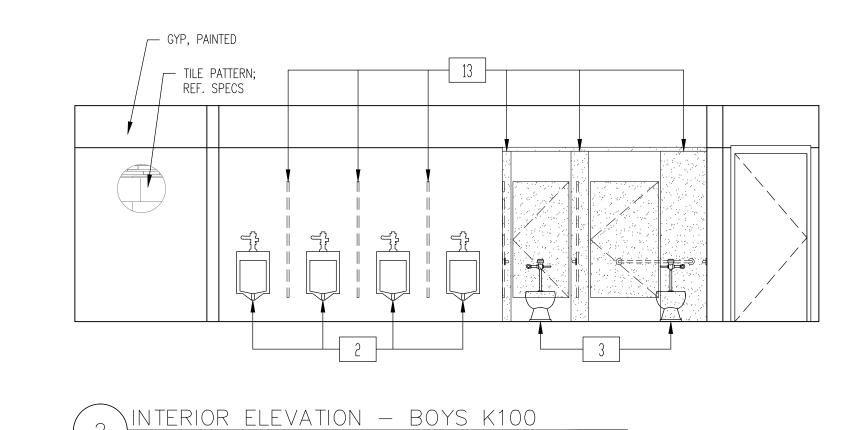


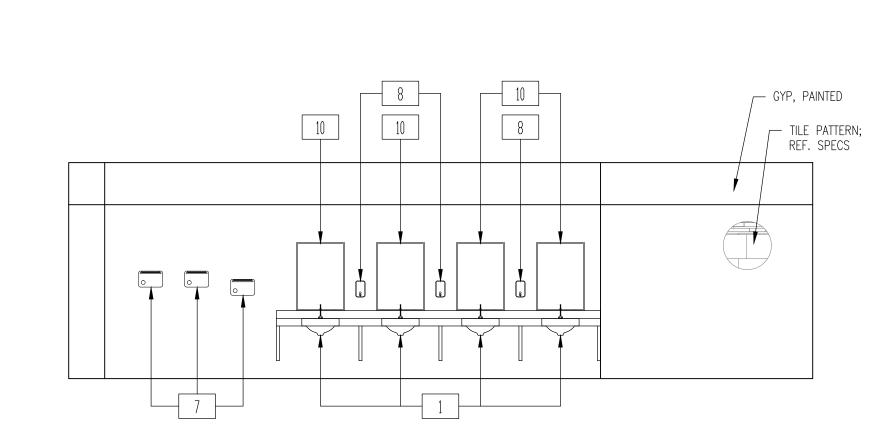





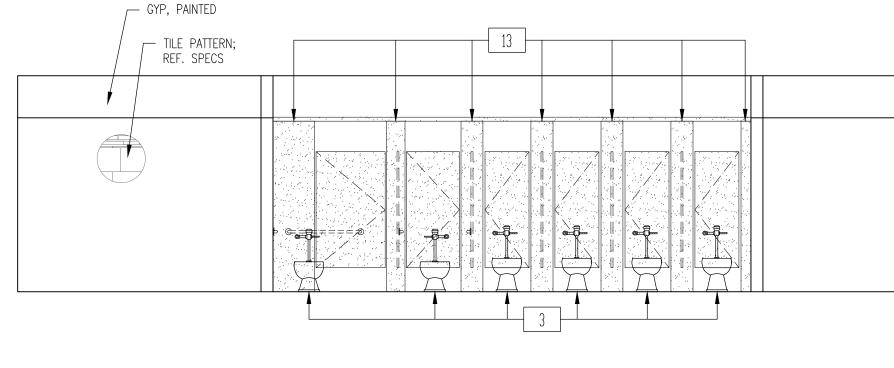

5 INTERIOR ELEVATION - GIRLS K102

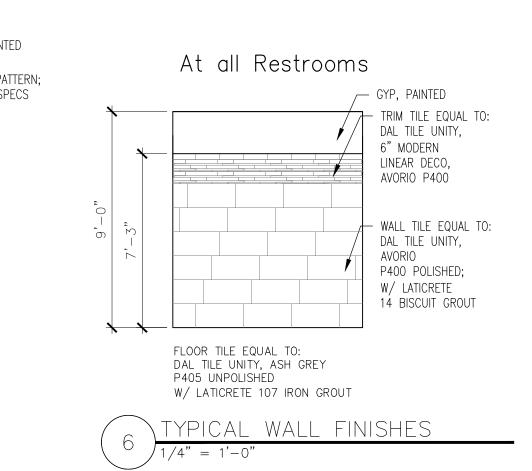

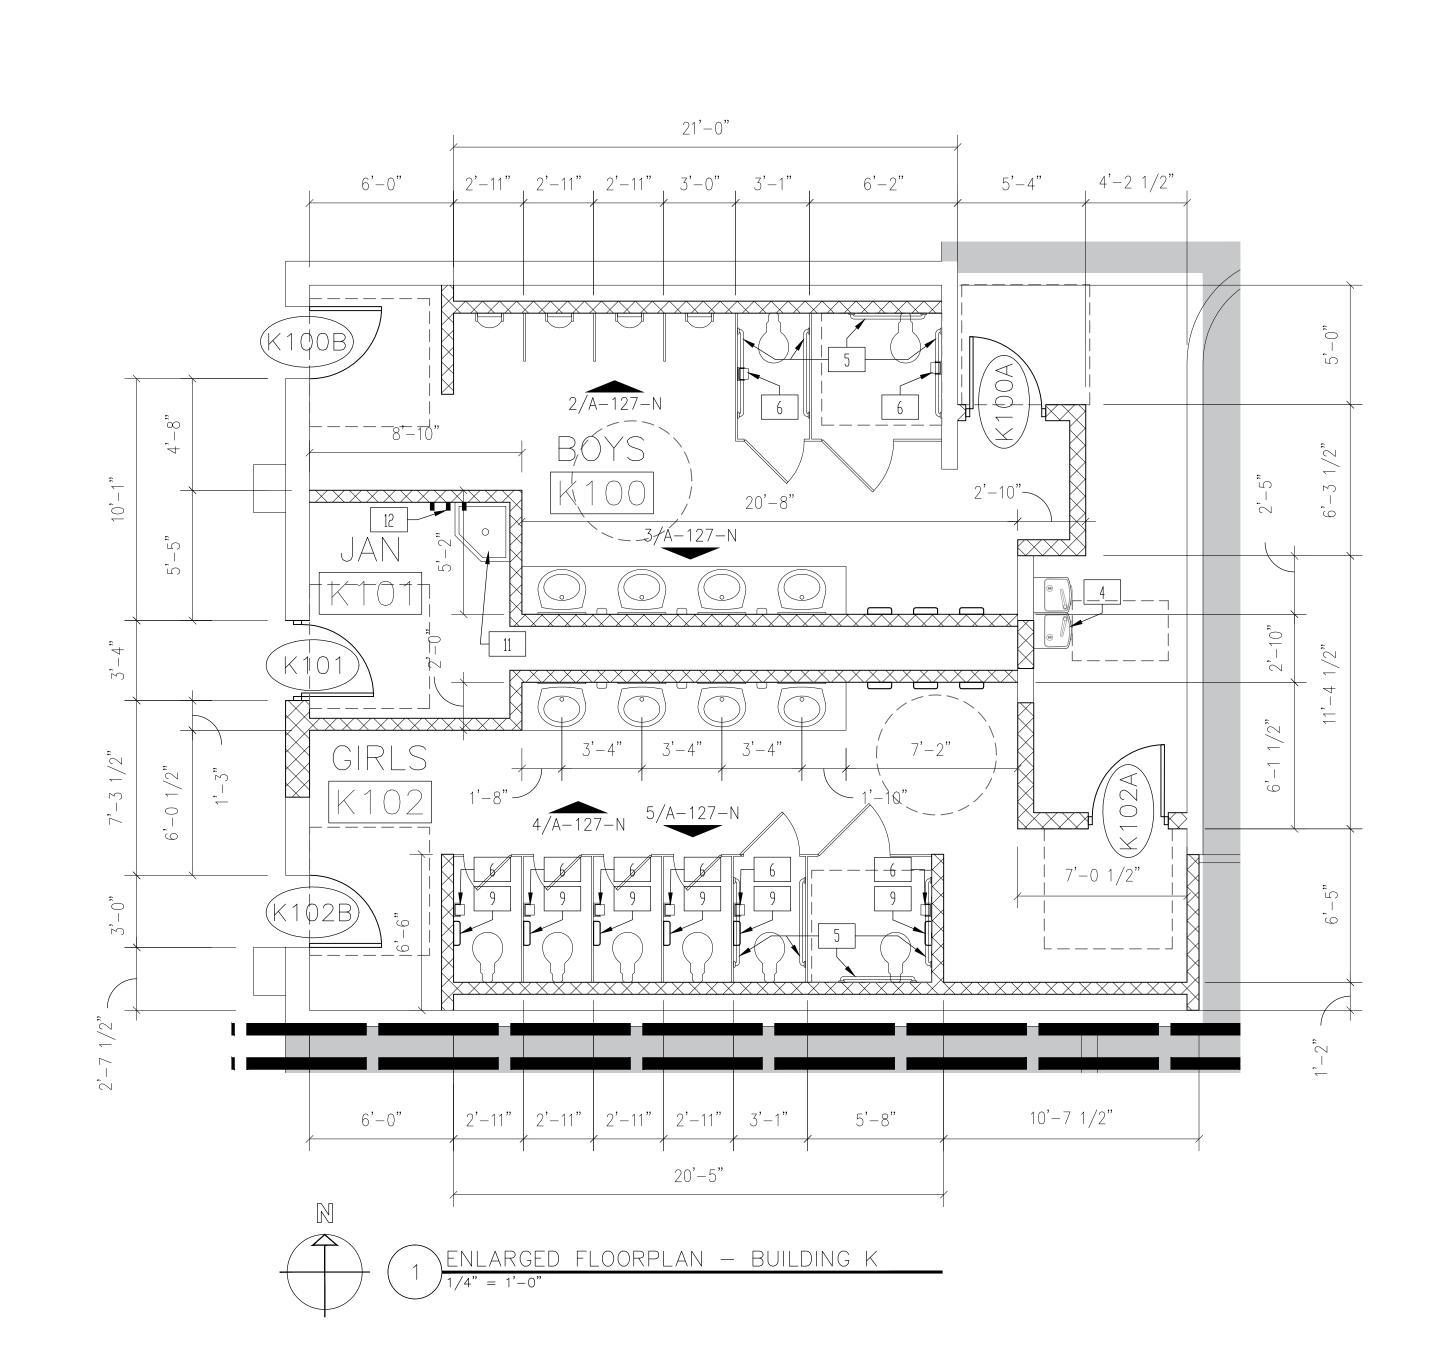

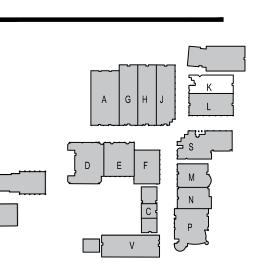

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Consultants:

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DBR ENGINEERING

EXPIRATION DATE 11/30/2019

SIGNED: 05/10/2019

COLLEGE³
READY.CONNECTED.COMPLETE ...

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STUDENT

RESTROOM

RENOVATIONS

STRUCTURAL:

KEYPLAN

Project Number: 19.04
Drawing Date: MAY 10, 2019
Drawn: CQ
Checked: JM
Scale: VARIES
ACAD File: DEMO PLAN


Revisions:

<u>1</u> - ADD 1 - 5/24/19

Sheet Title:

BUILDING K INT ELEV. & ENLRG. FLRPLN.

ADD. 2 A-127-N

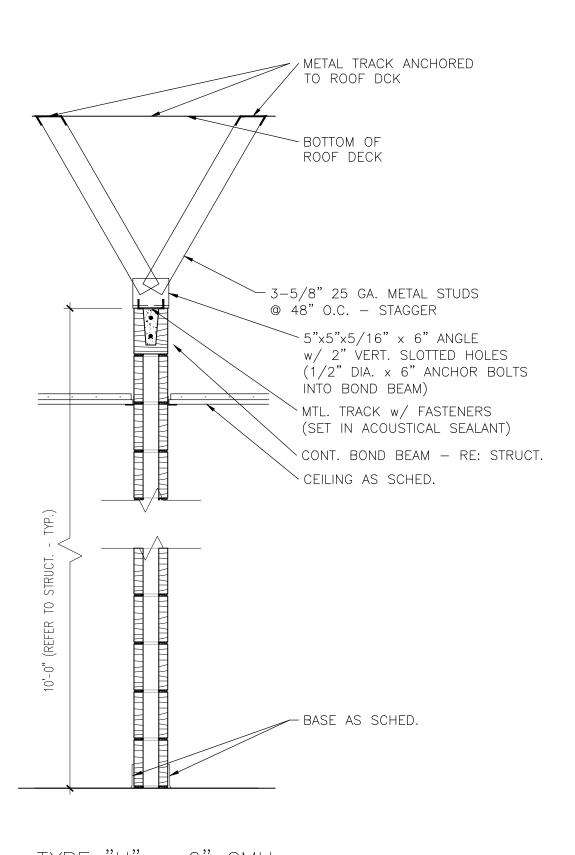


MTL. TRACK w/ FASTENERS


CEILING AS SCHED.


BASE AS SCHED.


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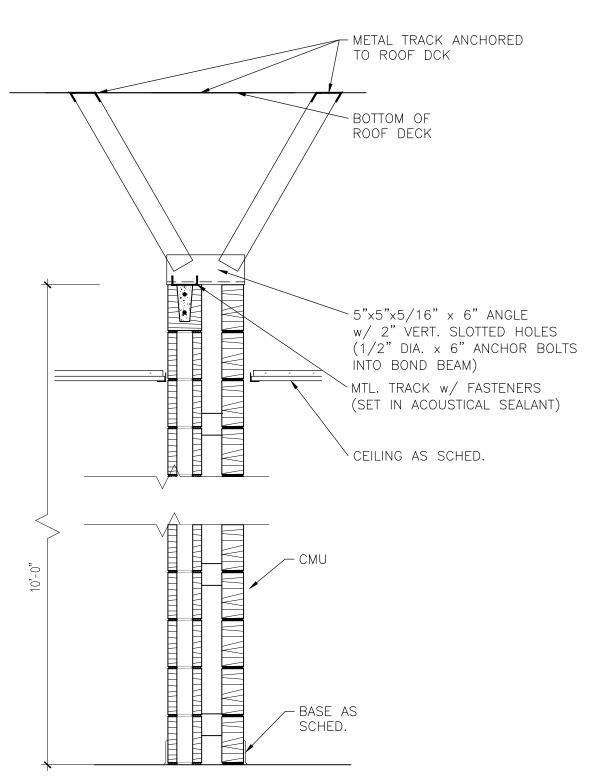
CONT. BOND BEAM - RE: STRUCT.



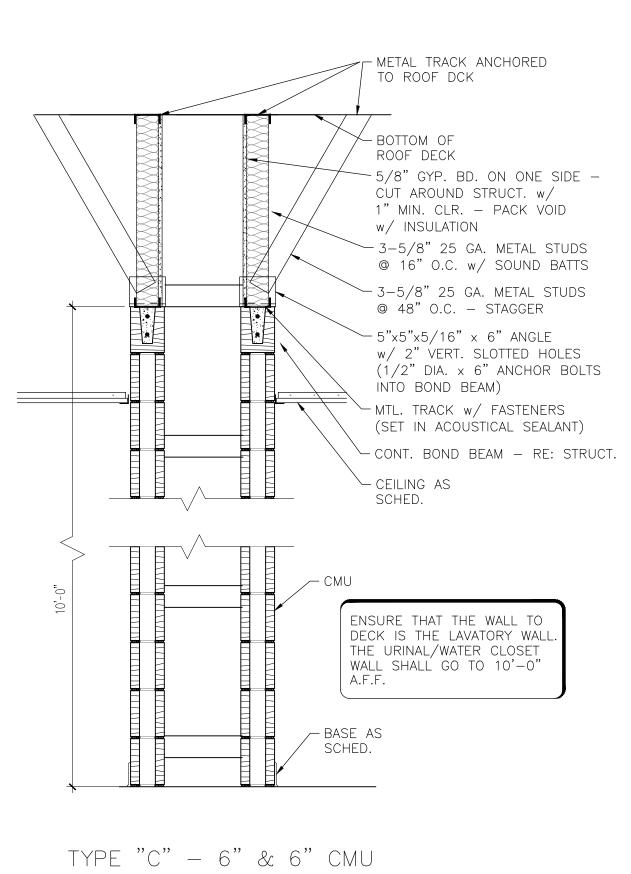

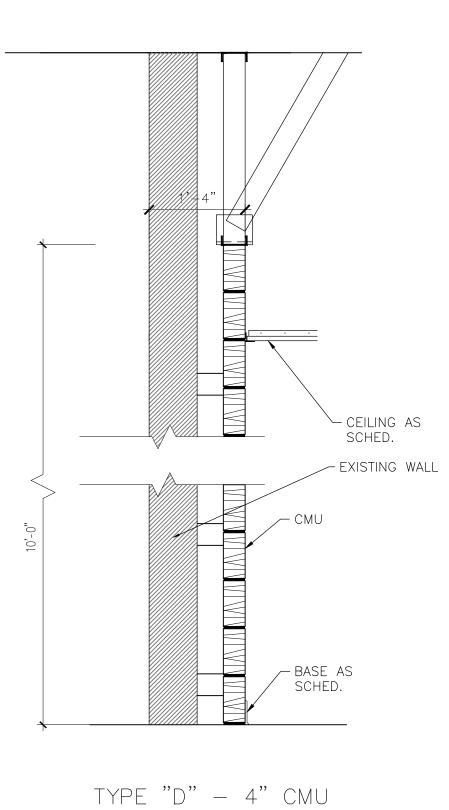

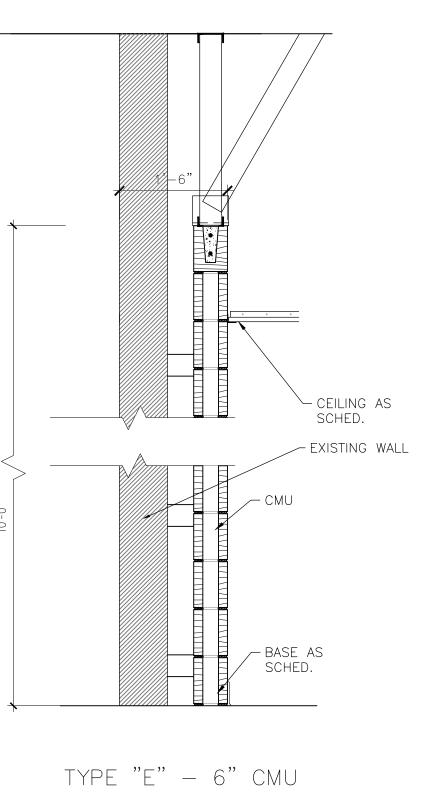

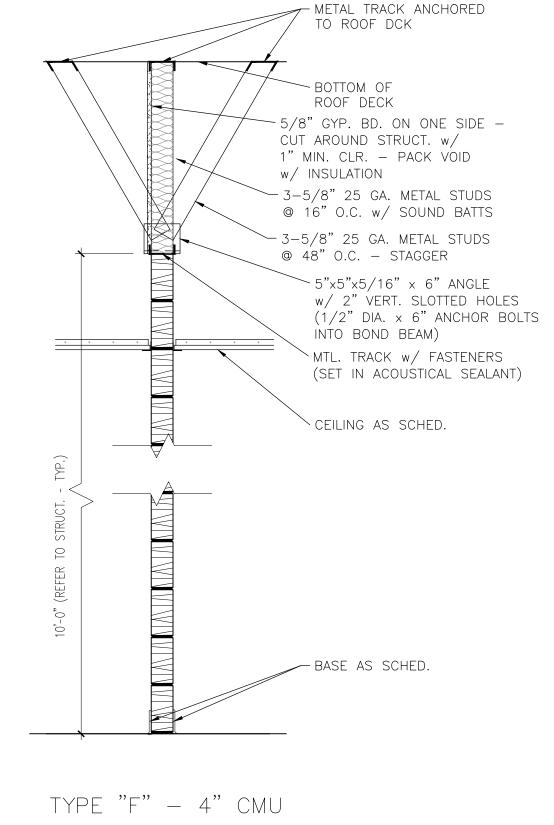

ADD. 2

WALL TYPES

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STRUCTURAL:

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SIGNED: 05/10/2019

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KEYPLAN

Drawing Date: MAY 10, 2019

<u>1</u> - ADD 1 - 5/24/19

VARIOUS

A-230-U

Project Number:

Drawn:

Scale:


Checked:

ACAD File:

Revisions:

TYPE "H" — 6" CMU

/ METAL TRACK ANCHORED TO ROOF DCK → BOTTOM OF ROOF DECK - 5/8" GYP. BD. ON ONE SIDE -CUT AROUND STRUCT. w/ 1" MIN. CLR. – PACK VOID w/ INSULATION ─ 3-5/8" 25 GA. METAL STUDS @ 16" O.C. w/ SOUND BATTS ─ 3-5/8" 25 GA. METAL STUDS @ 48" O.C. — STAGGER `5"x5"x5/16" x 6" ANGLE w/ 2" VERT. SLOTTED HOLES (1/2" DIA. \times 6" ANCHOR BOLTS INTO BOND BEAM)

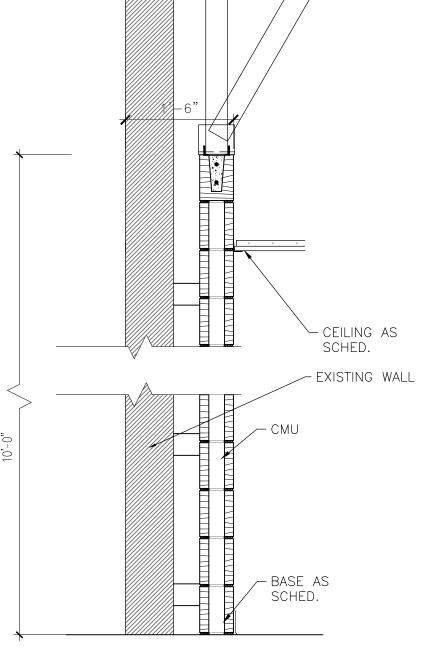

TYPE "G" - 6" & 4" CMU

TYPE "A" - 8" CMU

TYPE "B" - 6" CMU



Addendum

DATE 5/28/2019

ADDENDUM NO.

2

PROJECT 198008.000 | Pharr-San Juan-Alamo ISD – North EHS & College and University Campus – Renovations

The work described herein shall be added to the scope of work defined by the contract documents or it shall modify the scope of work defined by the contract documents as described. This work shall become a part of the contract documents by addendum.

DRAWINGS

Item 01 Sheet MEP2.01U – MEP Site Plan Univ. Campus

A. Added site plan sheet. Re: MEP 2.01U

Item 02 Sheet MD2.12U – Mechanical Demo Plan – Univ. Campus

A. Outside air units to remain and all associated ductwork and air devices shall not be removed and noted to be relocated. Transfer ducts to be relocated. Re: MD2.12U.

Item 03 Sheet M2.12U – Mechanical Plan – Univ. Campus

- A. Replaced sheet in its entirety. Refer to M2.12U for new mechanical plan.
- B. Omit roof top units, venturi valves, and plum fume hood exhaust fans. Refer to M2.12U for new scope. Architect has scheduled new ductless fume hoods with integrated exhaust fan system.

Item 04 Sheet M5.01U – Mechanical Schedules – Univ. Campus

A. Omit roof top units, venturi valve, and plume fume exhaust fan schedules.


Item 05 Sheet EP2.12U – Electrical Enlarged Power Plans

- A. Removed electrical circuit information for roof top units. Re: EP 2.12U
- B. Removed electrical circuit information for fume hood exhaust fans. Re: EP 2.12U
- C. Modified electrical circuiting to lab hoods. Re: EP 2.12U

Item 06 Sheet E5.01U – Electrical Schedules

A. Updated electrical circuit information on panel schedules; HMSB1, LMSBL1, LMSBL2, and LMSBL3. Re: E 5.01U

END OF ADDENDUM

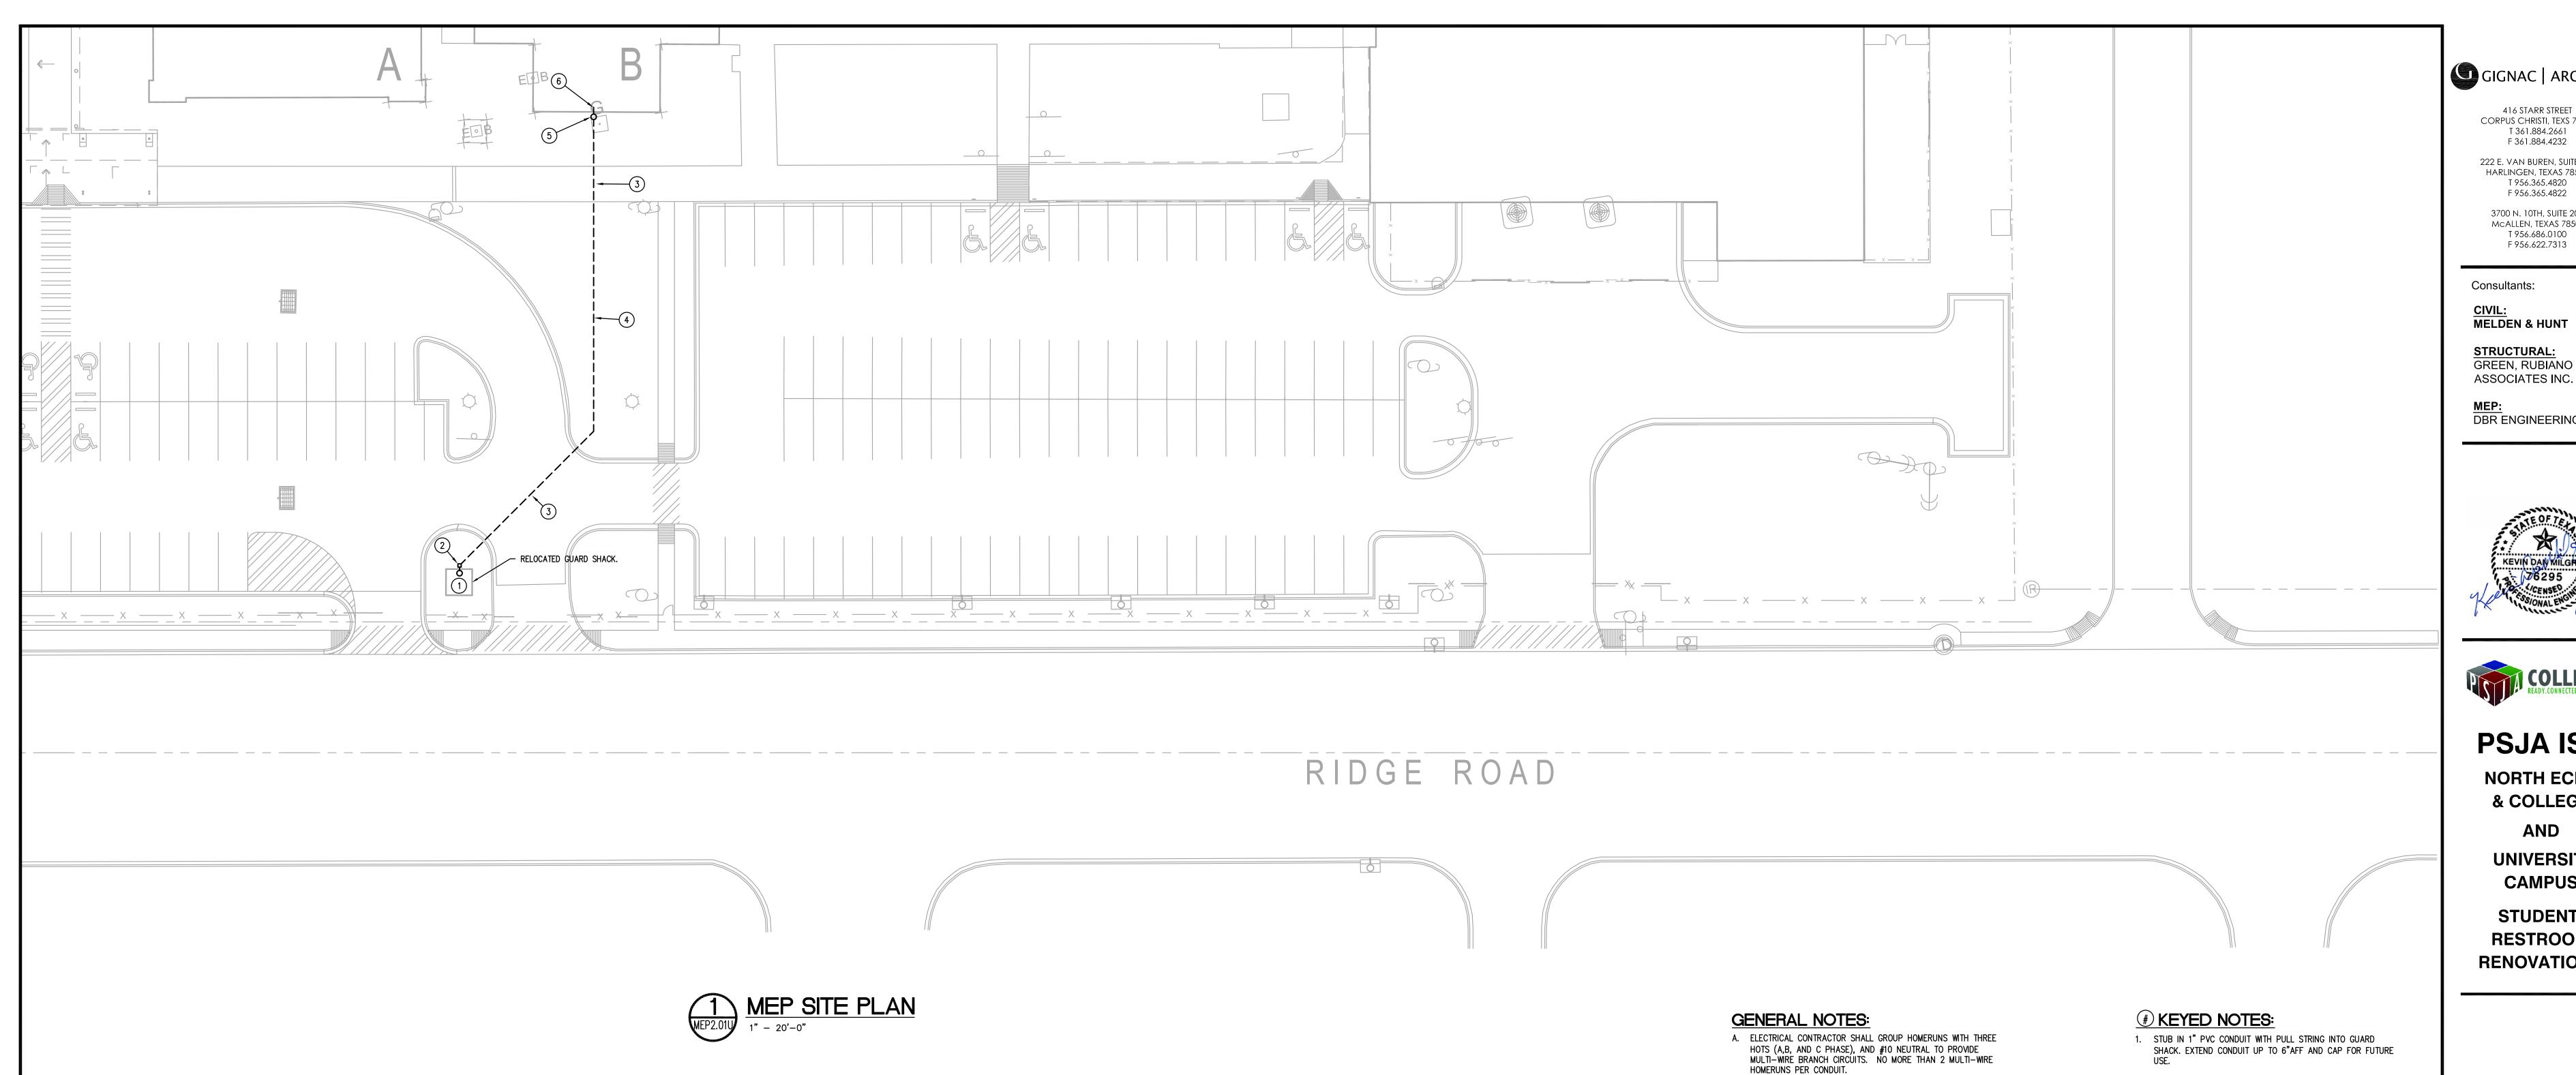

- B. CONTRACTOR SHALL INDICATE CIRCUIT SERVING EACH RECEPTACLE BY PROVIDING TYPE WRITTEN LABELING LOCATED ON INSIDE FACE OF EACH RECEPTACLE COVER PLATE.
- 2. PROVIDE SYNERTECH DUO 12x12 INGROUND ELECTRICAL BOX
- WITH TIER 15 COVER. 3. CONTRACTOR TO BORE 6" SLEEVE AT THIS APPROXIMATE
- LOCATION. COORDINATE EXACT LOCATION WITH OWNER.
- 4. PROVIDE 1"PVC CONDUIT WITH PULL STING FOR FUTURE ELECTRICAL CIRCUITS TO GUARD SHACK.
- 5. STUB CONDUIT UP AT BUILDING PERIMETER AND TRANSITION TO
- GRC. ROUTE EXPOSED ON EXTERIOR WALL TO A HEIGHT ABOVE INTERIOR CEILING LINE AND STUB INTO ACCESSIBLE ATTIC SPACE. PROVIDE LB FITTING AT 90 INTO BUILDING.
- 6. TRANSITION FROM GRC TO EMT CONDUIT ABOVE CEILING AND EXTEND CONDUIT TO NEAREST ELECTRICAL PANEL WITH AVAILABLE SPARES. FIELD VERIFY LOCATION OF PANEL AND ROUTING CONDITIONS.

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STRUCTURAL:
GREEN, RUBIANO &

MEP: DBR ENGINEERING





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KEYPLAN


Project Number: Drawing Date: 5-10-2019 Drawn: Checked: 1/4" = 1'-0" Scale: ACAD File: A-240-U

Revisions: <u>/2</u> Addendum #2 - 2019.5.28

MEP SITE PLAN - UNIV. CAMPUS

200 South 10th Street Suite 901
Mc Allen, Texas 78501
956.683.1640 p 956.683.1903 f
TBPE Firm Registration No. 2234

DM MG JCH TL -

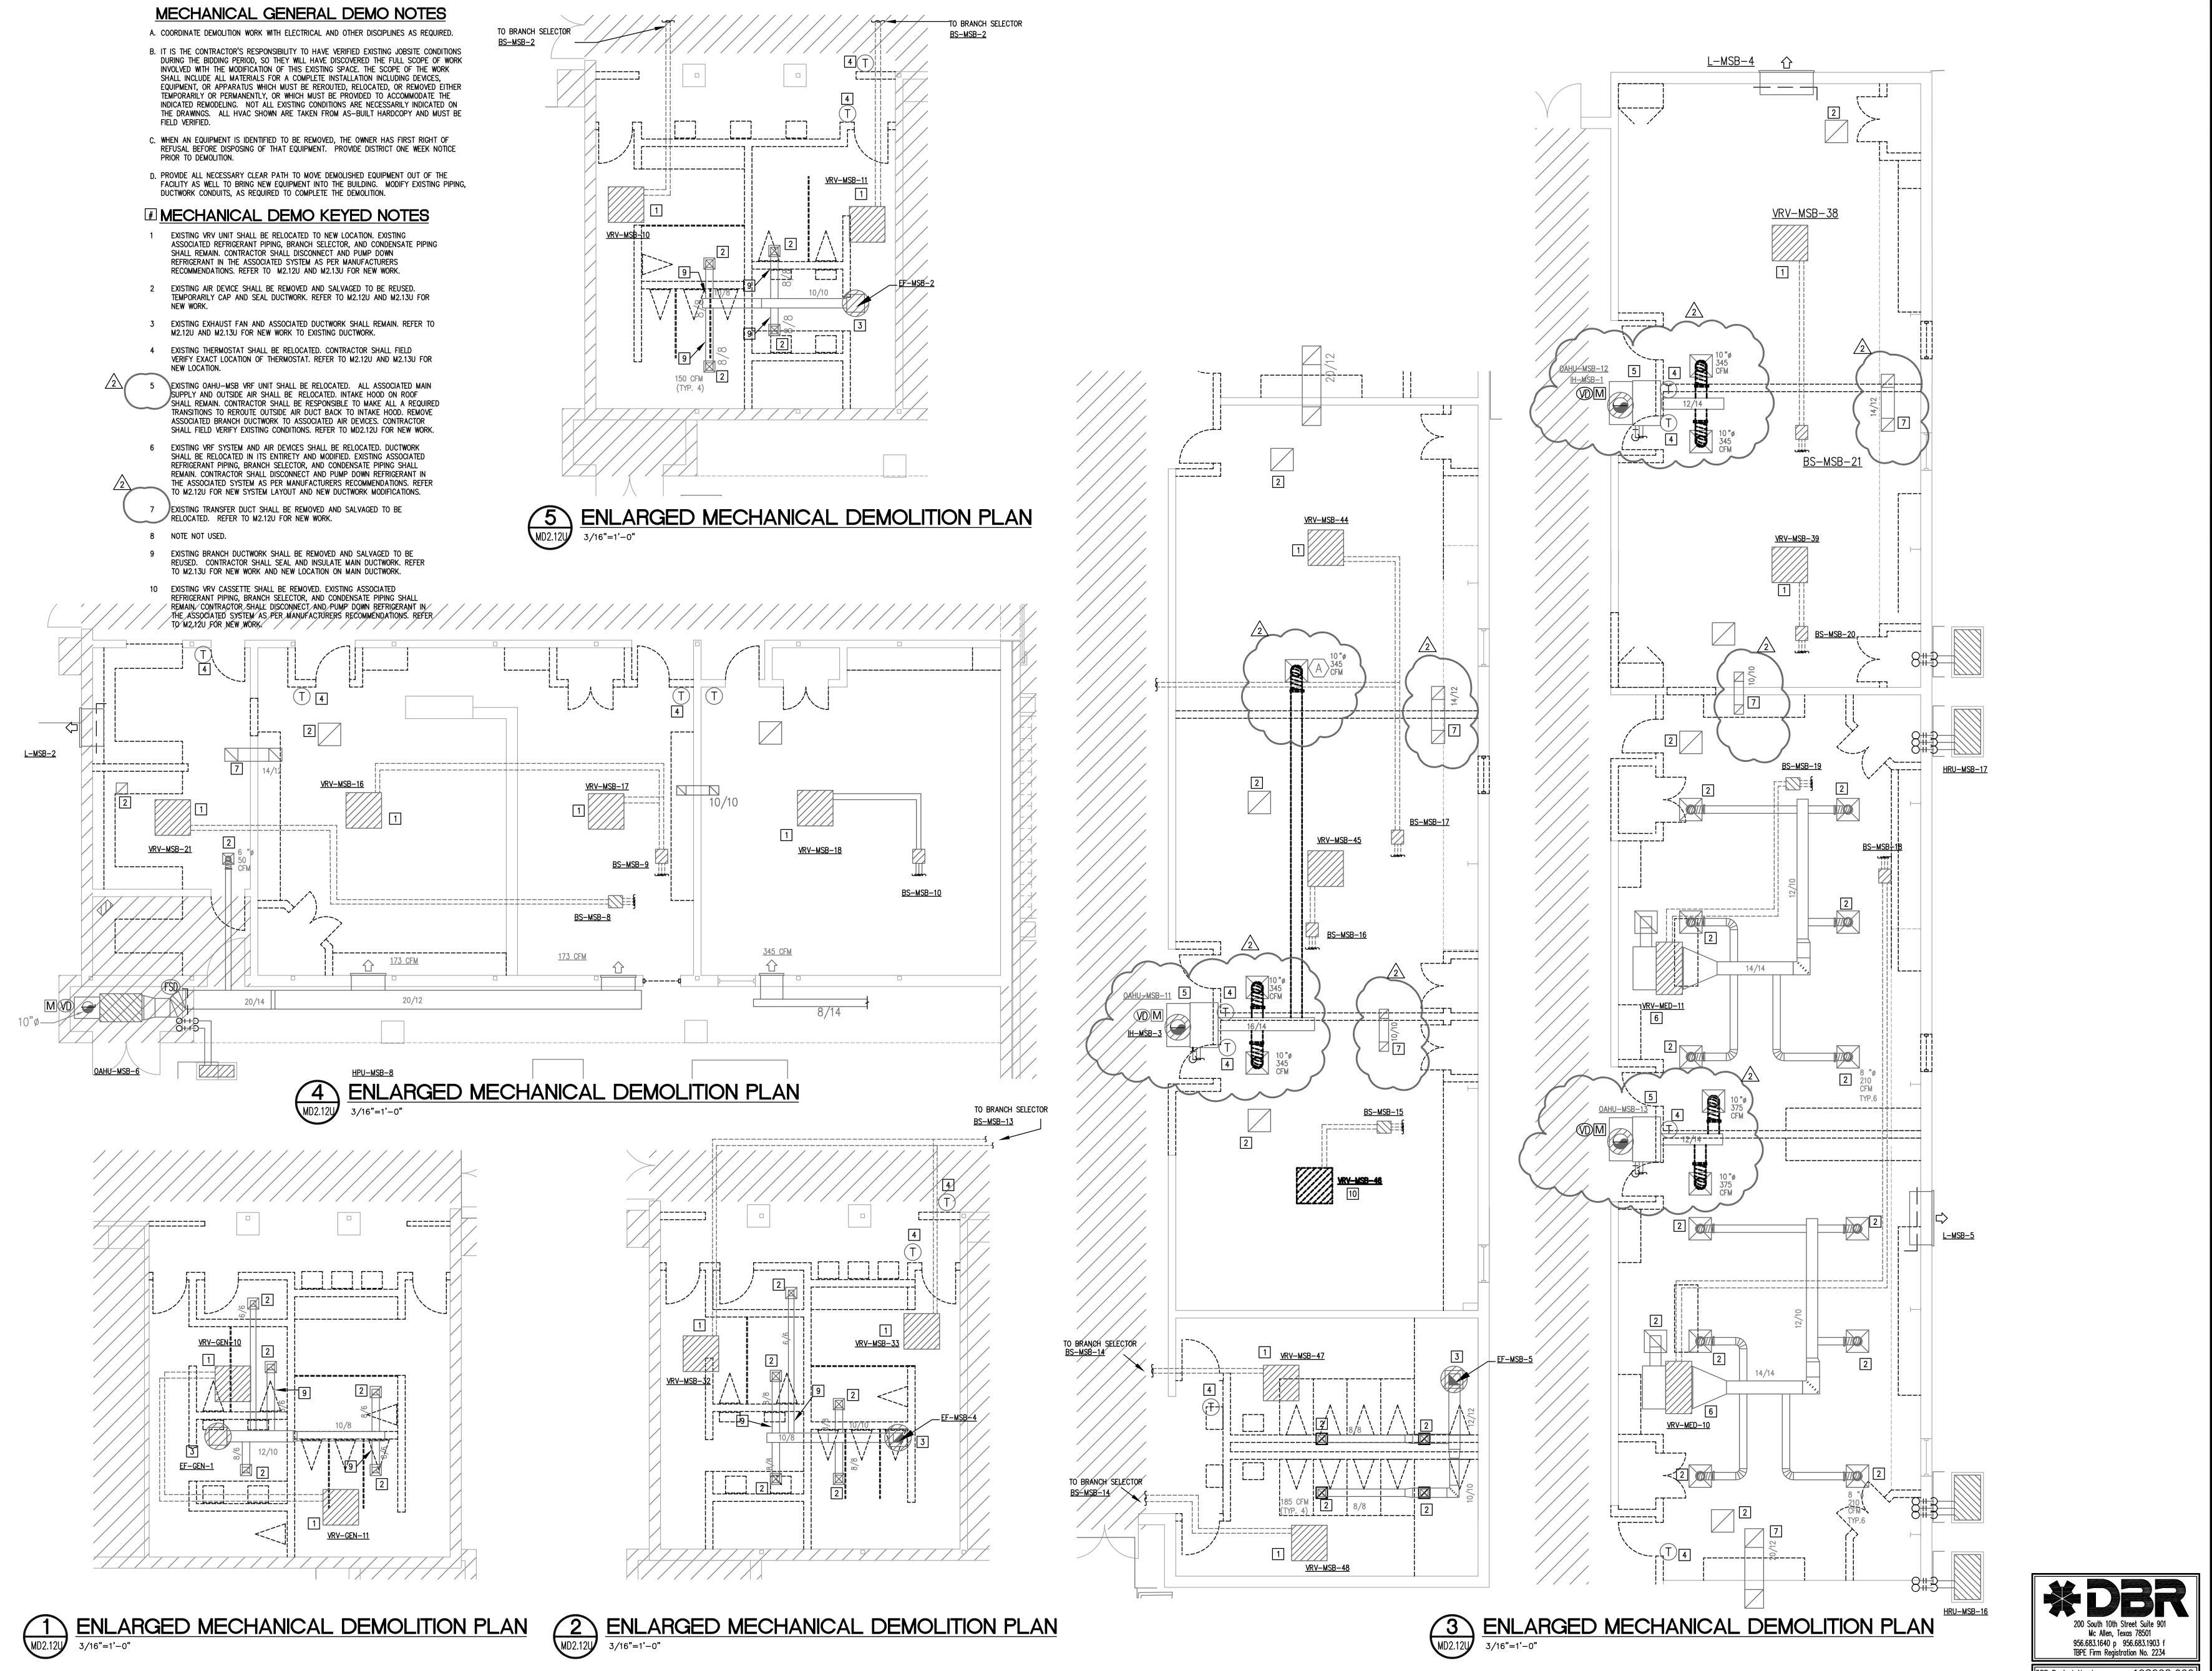

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ASSOCIATES INC.

<u>MEP:</u> DBR ENGINEERING





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STUDENT RESTROOM RENOVATIONS

KEYPLAN

Project Number: 19.04
Drawing Date: 5-10-2019
Drawn: Al
Checked: JM
Scale: 1/4" = 1'-0
ACAD File: A-240-L


Revisions: 2 Addendum #2 - 2019.5.28

COMPOSITE MECHANICAL DEMO PLAN -UNIV. CAMPUS

MD2.12U

DM MG JCH TL

ENLARGED MECHANICAL PLAN
3/16"=1'-0"

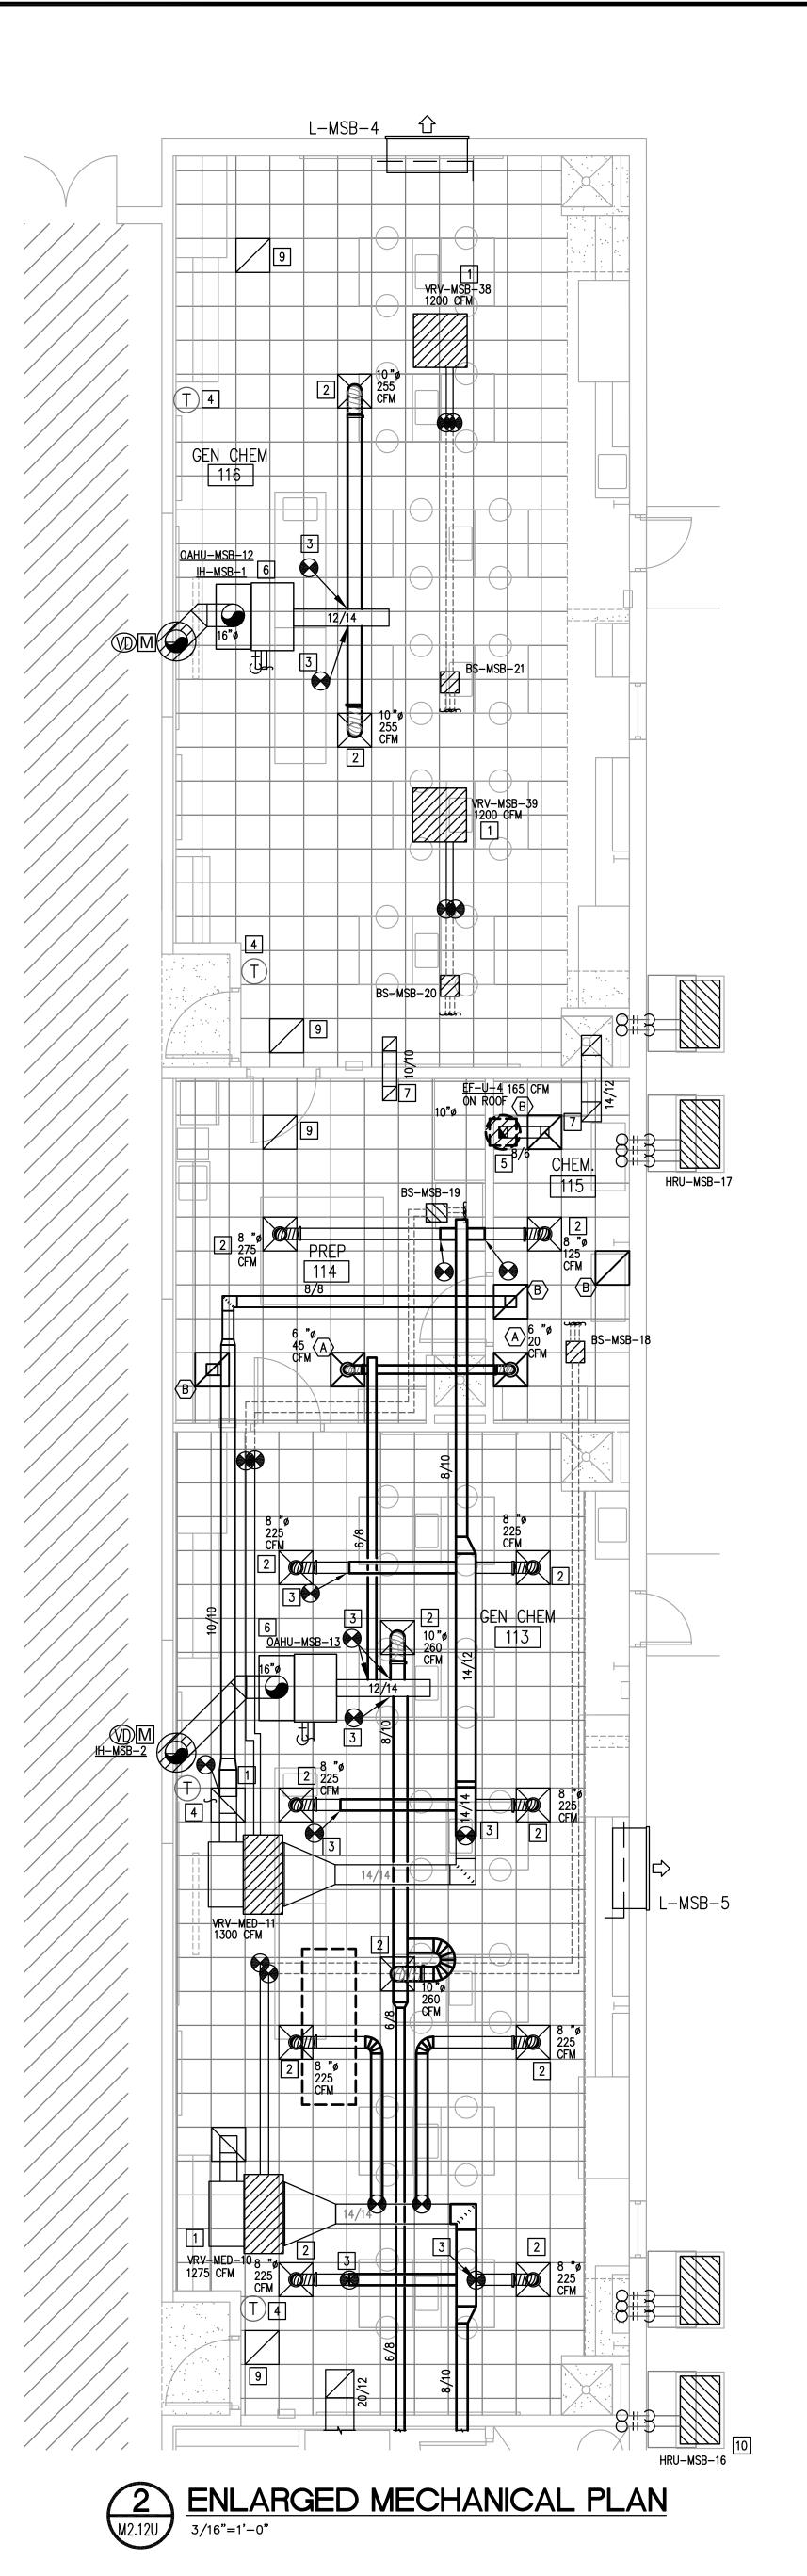


GENERAL MECHANICAL NOTES

- A. THE DRAWINGS ARE DIAGRAMMATIC AND INDICATE THE GENERAL LOCATION OF EQUIPMENT, DUCTS, AND GRILLES, ETC. IT IS THE INTENT OF THESE DRAWINGS AND SPECIFICATIONS THAT COMPLETE MECHANICAL SYSTEMS BE FURNISHED, INSTALLED, TESTED, AND READY FOR OPERATION WHETHER OR NOT EVERY ITEM OF EQUIPMENT, ACCESSORY, DEVICE, ETC. IS SHOWN. REFERENCE SHALL BE MADE TO THE FULL DRAWING PACKAGE INCLUDING ARCHITECTURAL, STRUCTURAL, ELECTRICAL, AND PLUMBING DRAWINGS FOR COORDINATION AND POTENTIAL CONFLICTS. THE MECHANICAL SUBCONTRACTOR SHALL, WITHOUT EXTRA CHARGE, MAKE REASONABLE MODIFICATIONS IN THE LAYOUT AS NEEDED TO PREVENT CONFLICTS WITH OTHER TRADES, OR FOR PROPER EXECUTION OF THE WORK. FIELD VERIFY ALL DIMENSIONS BEFORE FABRICATING DUCTWORK.
- B. EQUIPMENT SIZES, DIMENSIONS, AND REQUIRED CONNECTIONS SHALL BE VERIFIED WITH THE MANUFACTURER'S DRAWINGS AND CUT SHEETS BEFORE FABRICATING OF DUCTWORK, PIPING, OR POURING
- OF HOUSEKEEPING PADS. C. ALL FLEXIBLE DUCTWORK SHALL NOT EXCEED 5 FEET IN TOTAL LENGTH.
- D. ALL DUCTWORK AND ASSOCIATED ACCESSORIES SHALL BE CONSTRUCTED TO MEET THE LATEST SMACNA STANDARDS FOR LOW PRESSURE DUCTWORK.
- E. EXACT LOCATION OF GRILLES AND DAMPERS SHALL BE FIELD COORDINATED WITH OTHER TRADES TO AVOID CONFLICTS AND ALLOW ADEQUATE CLEARANCES.
- F. DIVISION 23 MECHANICAL CONTRACTOR SHALL COORDINATE WITH ELECTRICAL CONTRACTOR FOR ALL ELECTRICAL POWER REQUIREMENTS.
- G. PROVIDE INSULATION FOR ALL PIPING AND DUCTWORK THAT MEETS THE LATEST EDITION OF IECC.
- H. PROVIDE AIRFOIL TYPE TURNING VANES IN ALL NEW 90 DEGREE ELBOWS.
- I. ALL CEILING MOUNTED AND WALL MOUNTED AIR DEVICES SHALL MATCH ADJACENT ARCHITECTURAL SURFACE. CONTRACTOR SHALL COORDINATE COLOR WITH ARCHITECT.
- J. ALL SUPPLY AIR TAPS TO DIFFUSERS AND GRILLES SHALL BE SUPPLIED WITH MANUAL VOLUME DAMPERS. PROVIDE YOUNG'S REGULATORS FOR DAMPERS LOCATED ABOVE INACCESSIBLE CEILINGS.
- K. DUCT DIMENSIONS INDICATED ON DRAWINGS ARE CLEAR INSIDE AIR STREAM DIMENSIONS.

MECHANICAL KEYED NOTES

NEW LOCATION OF RELOCATED VRV UNIT. CONTRACTOR SHALL EXTEND WITH NEW REFRIGERANT AND CONNECT TO CORRESPONDING REFRIGERANT PIPING. EXTEND WITH NEW CONDENSATE PIPING TO EXISTING CONDENSATE PIPING. CONTRACTOR SHALL FIELD VERIFY EXACT LOCATION OF CONDENSATE PIPING. CONTRACTOR SHALL COORDINATE EXACT LOCATION WITH ALL CEILING DEVICES. SUPPORT FROM

- 2 NEW LOCATION OF SALVAGED AIR DEVICE. EXTEND WITH NEW DUCTWORK AS REQUIRED TO NEW LOCATION. BALANCE TO CFM AS NOTED ON PLAN.
- 3 CONNECT NEW DUCTWORK TO RELOCATED DUCTWORK. SIZE AS NOTED ON PLAN.
- 4 NEW LOCATION OF THERMOSTAT. MOUNT 48" A.F.F. COORDINATE EXACT HEIGHT AND LOCATIONS WITH OWNER AND ARCHITECT.
- 5 PROVIDE EXHAUST FAN ON ROOF AS SCHEDULED WITH PREFABRICATED ROOF CURB. ROUTE DUCTWORK UP AND TRANSITION AS REQUIRED. COORDINATE ROUTING WITH ALL DISCIPLINES AND STRUCTURAL MEMBERS PRIOR TO INSTALLATION. RE: DETAIL 7/M4.01U.
- 6 NEW LOCATION OF OUTSIDE AIR UNIT OAHU. CONTRACTOR SHALL ROUTE NEW OUTSIDE AIR DUCT TO ASSOCIATED INTAKE HOOD. PROVIDE NEW BRANCH DUCTWORK TO NEW LOCATION OF AIR DEVICES. CONTRACTOR SHALL TEST AND BALANCE UNIT AND OUTSIDE AIR AS REQUIRED. REFER TO PLAN FOR
- 7 NEW LOCATION OF AIR TRANSFER BOOT.
- 8 NOTE NOT USED.
- 9 NEW LOCATION OF SALVAGED AIR DEVICE.
- 10 REFER TO M6.01U FOR NEW REFRIGERANT PIPE CHARGE. CONTRACTOR SHALL CHARGE ENTIRE VRV SYSTEM AS REQUIRED FOR A COMPLETE OPERATING SYSTEM. REFER TO MANUFACTURER RECOMMENDATIONS FOR CHARGE AND INSTALLATION OF VRV SYSTEM.
- PROVIDE NEW VRV FAN COIL UNIT AS SCHEDULED ON M6.01U TAG VRV-MSB-46. CONNECT AND ROUTE REFRIGERANT PIPING TO EXISTING BRANCH SELECTOR. ROUTE CONDENSATE TO EXISTING CONDENSATE PIPING. SUSPEND FROM STRUCTURAL ABOVE.

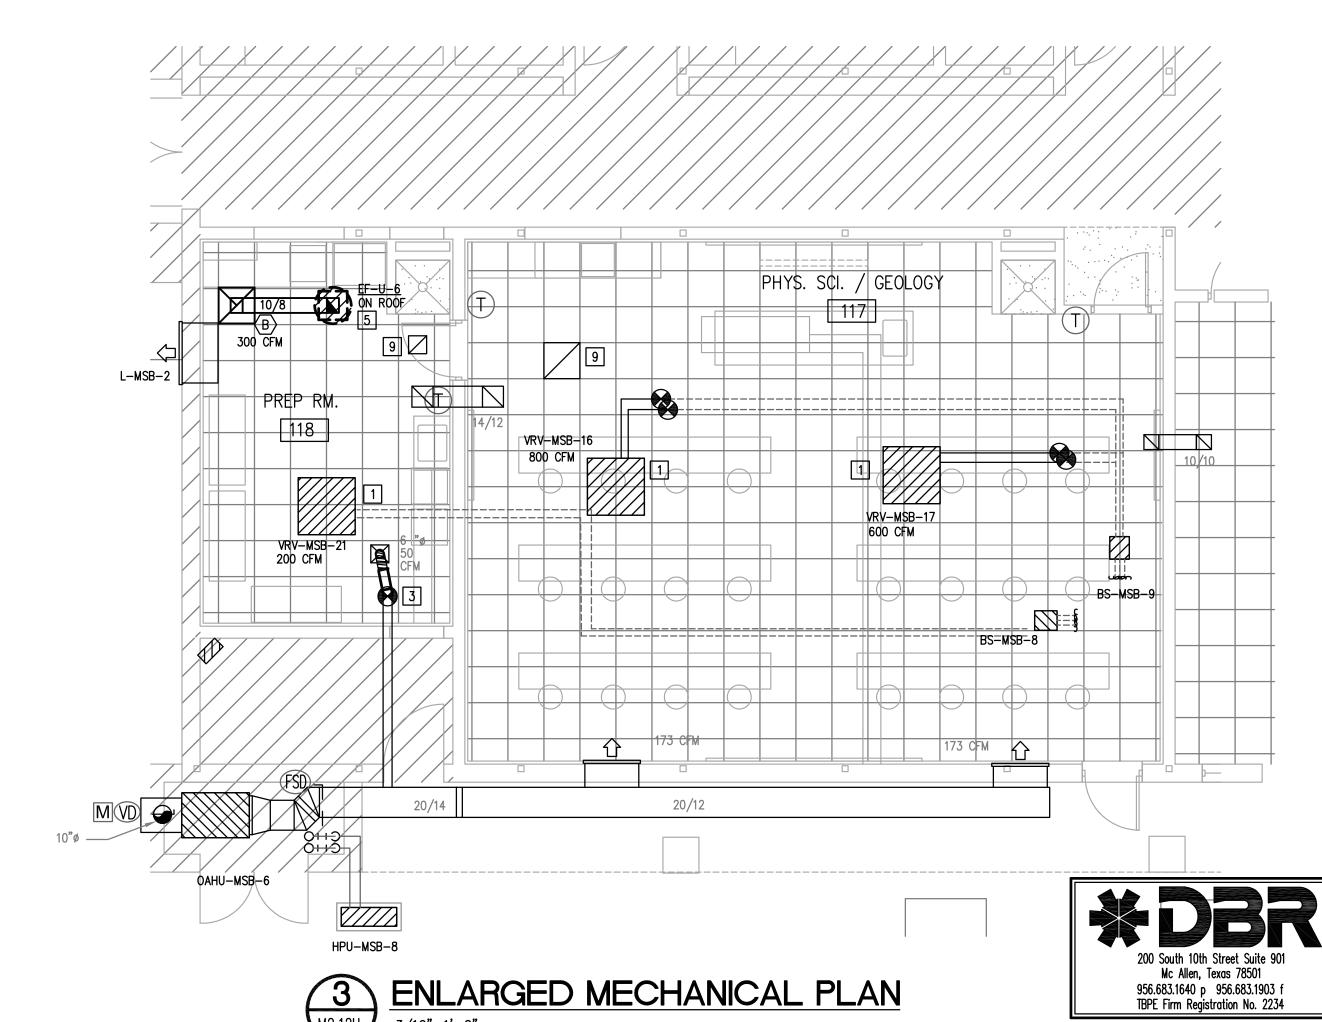


S ENLARGED MECHANICAL PLAN
3/16"=1'-0"

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RENOVATIONS

Project Number:	19.04
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Revisions:	

/2\ Addendum #2 - 2019.5.28

COMPOSITE MECHANICAL PLAN -

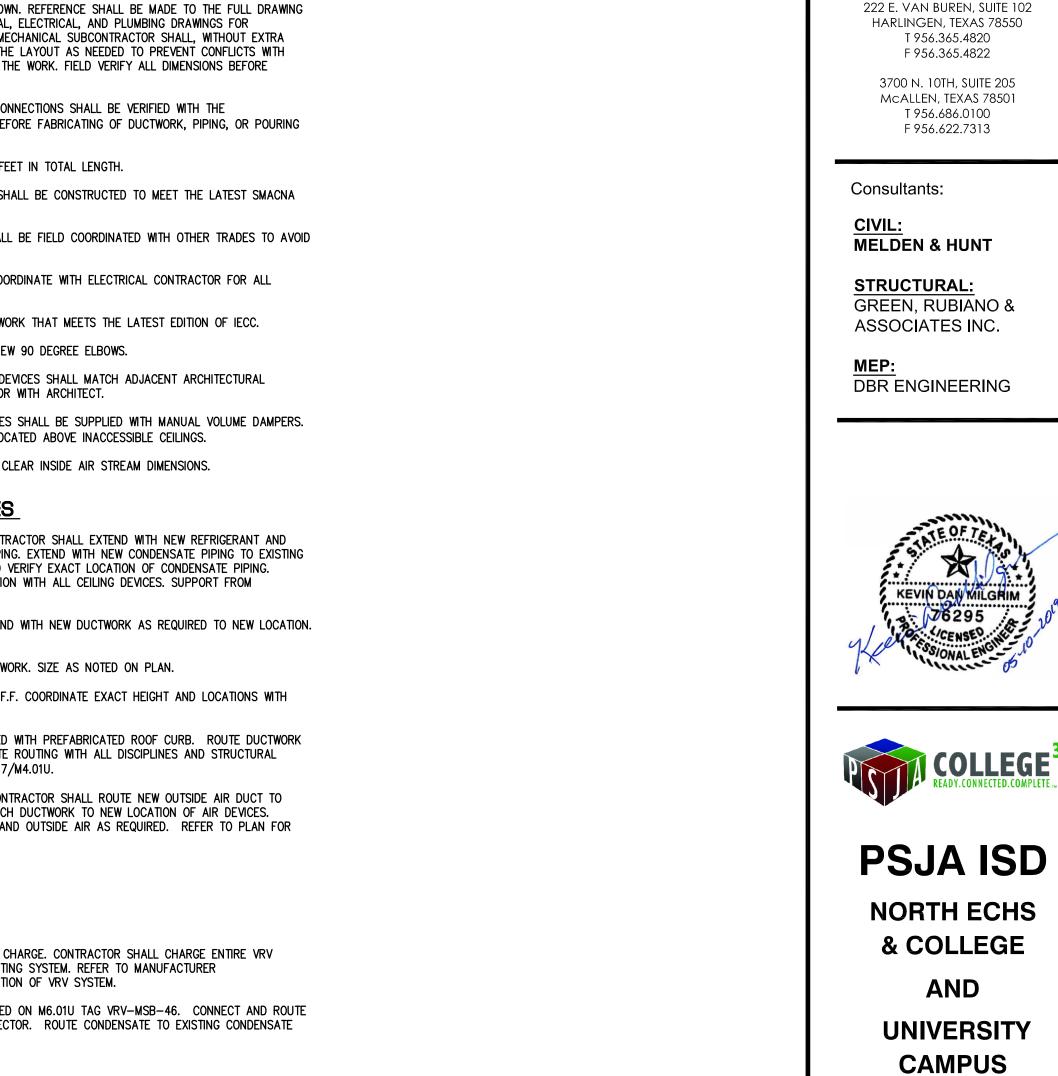DBR Project Number

DM MG JCH TL

UNIV. CAMPUS

	FAN SCHEDUI	LE			
MARK		EF-U-4	EF-U-5	EF-U-6	
SERVES		CHEM STO.115	CHEM STO.110	PREP RM 118	
CFM		165	165	300	
E.S.P. (IN W.G.)		0.375	0.375	0.375	
TYPE		ROOF	ROOF	ROOF	
DIRECT/BELT DRIVE		DIRECT	DIRECT	DIRECT	
FAN RPM		1,725	1,725	1,725	
MOTOR HORSEPOWER		1/6	1/6	1/6	
VOLTS/PHASE/HERTZ		120/1/60	120/1/60	120/1/60	
WEIGHT (LBS)		30	30	30	
SONES		3.9	3.9	5.1	
MANUFACTURER		COOK	соок	COOK	
MODEL NO.		90C17DEC	90C17DEC	90C17DEC	
NOTES		1, 2, 3	1, 2, 3	1, 2, 3	

- 1. PROVIDE WITH PRE-FABRICATED ROOF CURB (MINIMUM OF 12"), WEATHERPROOF DISCONNECT SWITCH, BACKDRAFT DAMPER, AND BIRD SCREEN. PROVIDE WITH ECM.
- 2. INTERLOCK WITH ASSOCIATED AIR HANDLING UNIT.
- 3. ALL ROOF CURBS MUST MEET THE WIND LOAD REQUIREMENTS BASED ON A MINIMUL OF 130 MPH OR GREATER IN OUR REGION. TYPICAL FOR ALL ROOF MOUNTED EQUIPMENT.

		AIR DEVICE SC	HEDULE	
MARK	MANUFACTURER/MODEL	TYPE	NC	REMARKS
А	TITUS/TMS-AA	24"X24" SUPPLY	25	ALUMINUM CONSTRUCTION. NECK SIZES AS INDICATED BELOW UNLESS NOTED ON PLAN.
В	TITUS/50F	24"X24" EGGCRATE RETURN	20	ALUMINUM CONSTRUCTION. PROVIDE DAMPER F EXHAUST.
С	TITUS/TMS	12"X12" SUPPLY	25	STEEL CONSTRUCTION. NECK SIZES AS INDICATE BELOW UNLESS NOTED ON PLAN.
D	TITUS/50F	12"X12" EGGCRATE RETURN	20	ALUMINUM CONSTRUCTION. PROVIDE DAMPER FEXHAUST.
Е	TITUS/300FS	SIDEWALL SUPPLY	25	ALUMINUM CONSTRUCTION. SEE MECHANICAL P FOR SIZE.
F	TITUS/350FL	SIDEWALL RETURN	20	ALUMINUM CONSTRUCTION. PROVIDE DAMPER FOR EXHAUST.SEE MECHANICAL PLAN FOR SIZE.

- 2. PAINT ALL SURFACES VISIBLE THROUGH FACE OF RETURN AIR GRILLES FLAT BLACK. THIS SHALL INCLUDE PIPING, CONDUIT,
- DUCTWORK, AND STRUCTURAL MEMBERS.
- B. PROVIDE FRAME FOR MOUNTING AIR DEVICE IN LAY-IN GRID CEILING UNLESS REFLECTED CEILING PLAN INDICATES HARD CEILING.
- I. UNLESS OTHERWISE NOTED, BRANCH DUCTS SERVING AIR DEVICES SHALL BE SAME SIZE AS NECK OF AIR DEVICE.
- FOR ROUND NECK DIFFUSERS:
- 5. WHERE THERE IS NO ACCESS ABOVE CEILING, PROVIDE REMOTE OPERATED DAMPERS WITH THROUGH THE AIR DEVICE CONTROL.
- 6" DIA: 0-120 CFM
- 12" DIA: 385-600 CFM

1. PROVIDE STANDARD WHITE FINISH FOR ALL AIR DEVICES UNLESS NOTED OTHERWISE ON PLAN.

IN AREAS WITH HARD CEILINGS, PROVIDE FRAMES FOR SURFACE MOUNTING. PROVIDE REMOTE OPERATOR DAMPER AND CONTROL.

- 8" DIA: 125-220 CFM
- 10" DIA: 225-380 CFM



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KEYPLAN

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Revisions: <u>2</u> Addendum #2 - 2019.5.28

MECHANICAL SCHEDULES



MECHANICAL SCHEDULES

NOT TO SCALE

	S	SPD SCH	EDULE	
MARK	MANUFACTURER	MODEL	RATING PHASE TO PHASE	LIEBERT ACCUGUIDE CABLE SIZE
SPD 1	LIEBERT	560YC12ANCG1S	250 kA	5 #6, 1 1/2" C
SPD 2	LIEBERT	510YA08ANAJ2S	160 kA	5 #10, 1 1/2" C
SPD 3	LIEBERT	510YC08ANAJ2S	160 kA	5 #6, 1 1/2" C

		FEEDER SCHEDU	LE			
		COPPER CONDUCTORS			ALUMINUM CONDUCTORS	
AMPERAGE	SETS	CONDUCTOR SIZE	CONDUIT (INCHES)	SETS	CONDUCTOR SIZE	CONDUIT (INCHES)
30A	1	4#10, 1#10 G.	3/4"C	1	N/A	N/A
40A	1	4#8, 1#10 G.	1 " C	1	N/A	N/A
50A	1	4#8, 1#10 G.	1"C	1	N/A	N/A
60A	1	4#6, 1#10 G.	1"C	1	N/A	N/A
70A	1	4#4, 1#8 G.	1 1/4"C	1	N/A	N/A
80A	1	4#4, 1#8 G.	1 1/4"C	1	N/A	N/A
90A	1	4#3, 1#8 G.	1 1/4"C	1	N/A	N/A
100A	1	4#3, 1#8 G.	1 1/4"C	1	N/A	N/A
125A	1	4#1, 1#6 G.	1 1/2°C	1	N/A	N/A
150A	1	4#1/0, 1#6 G.	1 1/2"C	1	N/A	N/A
175A	1	4#2/0, 1#6 G.	2"C	1	N/A	N/A
200A	1	4#3/0, 1#6 G.	2 " C	1	4#250KCMIL, 1#4G.	2 1/2°C
225A	1	4#4/0, 1#4 G.	2 1/2°C	1	4#300KCMIL, 1#2G.	3"C
250A	1	4#250KCMIL, 1#4 G.	2 1/2°C	1	4#350KCMIL, 1#2G.	3"C
300A	1	4#350KCMIL, 1#4 G.	3 " C	1	4#500KCMIL, 1#2G.	4"C
350A	1	4#500KCMIL, 1#3 G.	3 1/2°C	2	4#4/0, 1#1G.	2 1/2°C
400A	1	4#500KCMIL, 1#3 G.	4"C	2	4#250KCMIL, 1#1G.	2 1/2°C
450A	2	4#4/0, 1#2 G.	2 1/2°C	2	4#300KCMIL, 1#1/0G.	3"C
500A	2	4#250KCMIL, 1#2G.	2 1/2°C	2	4#350KCMIL, 1#1/0G.	3"C
600A	2	4#350KCMIL, 1#1G.	3"C	2	4#500KCMIL, 1#2/0G.	3"C
700A	2	4#500KCMIL, 1#1/0G.	4 "C	3	4#350KCMIL, 1#3/0G.	3"C
800A	2	4#600KCMIL, 1#1/0G.	4"C	3	4#400KCMIL, 1#3/0G.	3"C
1000A	3	4#500KCMIL, 1#2/0G.	4"C	4	4#350KCMIL, 1#4/0G.	4"C
1200A	4	4#350KCMIL, 1#3/0G.	3 " C	4	4#500KCMIL, 1#250KCMIL G.	4"C
1600A	4(600) OR 5(500)	4#600KCMIL, 1#4/0G. OR 4#500KCMIL, 1#4/0G.	4"C	5	4#750KCMIL, 1#350KCMIL G.	4"C
2000A	5(600) OR 6(500)	4#600KCMIL, 1#250KCMIL G. OR 4#500KCMIL, 1#250KCMIL G.	4"C	6	4#750KCMIL, 1#400KCMIL G.	4"C
2500A	6(600) OR 7(500)	4#600KCMIL, 1#350KCMIL G. OR 4#500KCMIL, 1#350KCMIL G.	4"C	7	4#750KCMIL, 1#600KCMIL G.	4"C
3000A	8(500)	4#500KCMIL, 1#400KCMIL G.	4"C	8	4#750KCMIL, 1#600KCMIL G.	4 "C
3500A	9(600) OR 10(500)	4#600KCMIL, 1#500KCMIL G. OR 4#500KCMIL, 1#500KCMIL G.	4"C	10	4#750KCMIL, 1#750KCMIL G.	4"C
4000A	10(600) OR 11(500)	4#600KCMIL, 1#500KCMIL G. OR 4#500KCMIL, 1#500KCMIL G.	4"C	11	4#750KCMIL, 1#750KCMIL G.	4 "C
5000A	12(600) OR 14(500)	4#600KCMIL, 1#700KCMIL G. OR 4#500KCMIL, 1#700KCMIL G.	4"C	13	4#750KCMIL, 2#600KCMIL G.	5"C

^{1.} ALUMINUM CONDUCTORS SHALL BE COMPRESSION TYPE CONDUCTORS AND SHALL USE PENETROX WITH COMPRESSION TERMINATION

			F	Pan	elbo	ard	D	P	3A			•	00 AIC Rating Existing X New			
	120/208	3 Volt,3-Phase,4-	Wire	X	MCB	500	AM	ΡM	СВ		X	Singl	е		Mounti	ng
		1 Section			MLO	600	AM	РΒ	US (C	Copper)	1	Doub	le		X Surface	e
	,	I -Nema Rating										Feed	- Thru		Flush	
Notes	Load (VA) Descripti	on	Туре	Wire	СВ	CKT #	PH	CKT #	СВ	Wire	Туре	Description		Load (VA)	Notes
	12810			SP			1	Α	2			SP			11300	
	18238	PANEL 'LM	ISBL1'	SP	3/0	200/3	3	В	4	100/3	3	SP	PANEL 'LMSBL	.2'	11828	
	17030			SP			5	С	6			SP			11300	
	10900			SP			7	Α	8			SP			6108	
	10860	PANEL 'LM	ISBL3'	SP	3	100/3	9	В	10	100/3	3	SP	PANEL 'LMSBL	.4'	5760	
	10360			SP			11	С	12			SP			5580	
		SPACE					13	Α				II II	SPACE			
		SPACE					15	В				II II	SPACE			
		SPACE					17	С	18				SPACE		-1.0-0	
		Subtotal				·		11		(<u> </u>			Subtotal		51,876	
	. (2011)	Load Type	Conn		Fct.	Divers		N.E		(2011)		уре	Conn.	Fct.	Diver	sity
	ll l	(R) Recept.	0			0			220.	ll l	(L) Lighting		0	125%	ll .	
	ll l	(K) Kitchen	0		100%	0			220.		(EL) Ext. Lt	_	0	125%	ll .	
	ll l	(C) Cooling	0		0%	0			620.	ll l	(E) Elevator		0	100%	ll .	
	ll l	(H) Heating	0		0%	0			000	ll.	(WH) Water		0	100%	ll .	
	ll l	(F) Fans	0		100%	0			220	ll.	(MT) Lrg. Me		0	125% 100%	ll .	
63	ll l	(W) Welders (M) Misc.	0		100%	0					(SP) Sub Pa	anei	132,074	100%	132,0	0/4
		Total Connected Total Load (Dive	Load =		132,074 132,074	VA =			AMF AMF	ll.	Location o	of Pane	<u> </u>			

			F	an	elbo	ard	L	M;	SB	L3		10,0	00 AIC Rating Existing X New			
	120/208	3 Volt,3-Phase,4-	\/\/iro	1	MCB	0	AMF	<u> М</u>	CB		X	Sing			Mounti	na
		1 Section	VVIIC	×	MLO	100				Copper	II	Dou			Surface	_
		l -Nema Rating		^	IVILO	100	/ \IVII), 00	оррсі,	′		d - Thru		X Flush	•
Notes	Load (VA	1	ion	Туре	Wire	СВ	CKT #	PH	CKT #	СВ	Wire	Туре	Description		Load (VA)	Notes
	900	RM116-FRONT	COUNT.	R	12	20/1	1	A	2	20/1	12	R	RM116-STUDENT ST	TA.	900	
	900	RM116-FRONT		R	12	20/1	3	В	4	20/1	12	R	RM116-STUDENT ST	ll l	900	1
	900	RM116-TEACH	ERS STA.	R	12	20/1	5	С	6	20/1	12	R	RM116-STUDENT ST	TA.	900	
	720	RM116-TV'S		R	12	20/1	7	A	8	20/1	12	R	RM116-STUDENT ST	TA.	900	
	900	RM116-REAR C	COUNT.	R	12	20/1	9	В	10	20/1	12	R	RM116-STUDENT ST	TA.	900	
	900	RM116-REAR C	COUNT.	R	12	20/1	11	С	12	20/1	12	R	RM116-STUDENT ST	TA.	900	
	900	RM116-REAR C		R	12	20/1	13	Α	14	20/1	12		RM116-STUDENT S	ll.	900	1
	900	RM116-STUDE	NT STA.	R	12	20/1	15	В	16	20/1	12		RM116-STUDENT ST	ll.	900	1
	900	RM116-STUDE		R	12	20/1	17	С	18	20/1	12	R	RM116-STUDENT ST	TA.	900	1
	900	RM116-STUDE		R	12	20/1	19	A	20	20/1	12		RM116-STUDENT S	ll.	900	1
	360	PREP114		R	12	20/1	21	В	22	20/1	12	R	RM116-STUDENT S	ll.	900	-
	360	PREP114		R	12	20/1	23	С	24	20/1	12	R	RM116-STUDENT S	ll.	900	
	500	DI-1		R	12	20/1	25	Ā	26	20/1	12	R	RM116-STUDENT S	ll.	900	
	500	DP-1		MT	12	20/1	27	В	28	20/1	12	R	RM116-STUDENT S	ll l	900	
	500	WSU-1	R		12	20/1	29	С	30	20/1	12	R	RM116-STUDENT S	TA.	900	1
~	~180~	LAB UTILITY 60	-YOUTHO	~	12	20/1	31	A	32	20/1	12	R	RM116-STUDENT ST	TA.	900	1
	500	FUME HOOD		М	12	20/1	33	В	34	20/1	12	R	RM116-STUDENT S	TA.	900	
	500	FUME HOOD		М	12	20/1	35	С	36	20/1	12	R	RM116-STUDENT ST	TA.	900	
	500	FUME HOOD		М	12	20/1	37	Α	38	20/1	12	R	RM116-STUDENT ST	TA.	900	
	500	FUME HOOD		М	12	20/1	39	В	40	20/1	12	R	RM116-STUDENT ST	TA.	900	
~	~~~	SPARE BREAK	ER		12	20/1	41	С	42	20/1	12	R	RM116-STUDENT ST	TA.	900	1
	13,220	Subtotal			1								Subtotal		18,900	
I.E.C	. (2011)	Load Type	Conn		Fct.	Divers	sity	N. E	E.C. (2011)	Load T	уре	Conn.	Fct.	Diver	sity
22	0.44	(R) Recept.	29,44	0		19,7	20		220.	12	(L) Lighting		0	125%)
22	ll l	(K) Kitchen	0		100%	0			220.	ll l	(EL) Ext. Lt	g.	0	125%)
22		(C) Cooling	0		0%	0			620.	ll l	(E) Elevator	_	0	100%)
22	0.60	(H) Heating	0		0%	0					(WH) Water	Ht.	0	100%)
		(F) Fans	0		100%	0			220	ll l	(MT) Lrg. M		500	125%	II .	:5
63		(W) Welders	0			0				ll l	(SP) Sub Pa		0	100%	II .	
	ll.	(M) Misc.	2,180)	100%	2,18	80				` ,					
	<u>"</u>	Total Connected Total Load (Dive			32,120 22,525				AMF	ll l	Location o	of Pan	el:		,	

			F	ar	elbo	ard	L	M:	SB	L4		10,0	000 AIC Rating Existing X New			
	120/208	3 Volt,3-Phase,4-V	Vire		MCB	0	AM	P M	СВ		Х	Sin	gle		Mounti	ng
		1 Section		X	MLO	100	AM	РΒ	JS (C	Copper)) 	Dou	ıble		Surface	Э
	•	1 -Nema Rating										Fee	d - Thru		X Flush	
Notes	Load (VA) Description	on	Туре	Wire	СВ	CKT #	PH	CKT #	СВ	Wire	Туре	Description		Load (VA)	Note
	720	RM118		R	12	20/1	1	Α	2	20/1	12	R	RM122-COMPUTERS	3	720	
	900	RM118-ICEMAK	ER	R	12	20/1	3	В	4	20/1	12	R	RM122-COMPUTERS	3	720	
	900	RM118-REFRIG	ERATOR	R	12	20/1	5	С	6	20/1	12	R	RM122-COMPUTERS	3	720	
	180	RM117-FRONT	COUNT.	R	12	20/1	7	Α	8	20/1	12	R	RM122-COMPUTERS	3	720	
	180	RM117-FRONT	COUNT.	R	12	20/1	9	В	10	20/1	12	R	RM122-COMPUTERS	3	720	
	360	RM117-TEACHE	RS STA.	R	12	20/1	11	С	12	20/1	12	R	RM122-COMPUTERS	3	720	
	720	RM117-STUDEN	IT STA.	R	12	20/1	13	Α	14	20/1	12	R	RM122-COMPUTERS	3	720	
	720	RM117-STUDEN	IT STA.	R	12	20/1	15	В	16	20/1	12	R	RM122-COMPUTERS	3	720	
	720	RM117-STUDEN	IT STA.	R	12	20/1	17	С	18	20/1	12	R	RM122-COMPUTERS	3	720	
	720	RM117-STUDEN	IT STA.	R	12	20/1	19	Α	20	20/1	12	R	RM122-COMPUTERS	3	720	
	720	RM117-STUDEN	IT STA.	R	12	20/1	21	В	22	20/1	12	R	RM122-COMPUTERS	3	720	
	720	RM117-STUDEN	IT STA.	R	12	20/1	23	С	24	20/1	12	R	RM122-COMPUTERS	3	720	
	360	RM117		R	12	20/1	25	Α	26	20/1	12	MT	EF-U-6		528	
	360	RM117		R	12	20/1	27	В	28	20/1	12		SPARE BREAKER			
		SPARE BREAK	ER		12	20/1	29	С	30	20/1	12		SPARE BREAKER			
		SPARE BREAK	ER		12	20/1	31	Α	32	20/1	12		SPARE BREAKER			
		SPARE BREAK	ER		12	20/1	33	В	34	20/1	12		SPARE BREAKER			
		SPARE BREAK	ER		12	20/1	35	С	36	20/1	12		SPARE BREAKER			
		SPARE BREAK	ER		12	20/1	37	Α	38	20/1	12		SPARE BREAKER			
		SPARE BREAK	ER		12	20/1	39	В	40	20/1	12		SPARE BREAKER			
		SPARE BREAK	ER		12	20/1	41	С	42	20/1	12		SPARE BREAKER			
	8,280	Subtotal		II							ı.		Subtotal		9,168	
N.E.C	(2011)	Load Type	Conn		Fct.	Divers	sity	N.E	.C. (2011)	Load T	уре	Conn.	Fct.	Diver	sity
22	0.44	(R) Recept.	16,92	0		13,4		JL	220.		(L) Lighting		0	125%	0	
	l I	(K) Kitchen	0		100%	0		II	220.		(EL) Ext. Lt	g.	0	125%	II	
	III	(C) Cooling	0		0%	Ō		II	620.		(E) Elevator	-		100%	II .	
	ll.	(H) Heating	0		0%	٥				l II	(WH) Wate			100%	ll .	
		(F) Fans	0		100%	ا آ			220	- 11	(MT) Lrg. M		528	125%	II .	
		(W) Welders	0		,	0					(SP) Sub P		0 0	100%	III .	
		` ′	0		100%	0					,					
	` '				17,448 14,120				AMF	- 11	Location	of Par	nel:			

			F	an	elbo	ard	Н	M	SE	31			65,0	000 AIC F Exist X New	-			
	277/480	Volt,3-Phase,4-	Wire		MCB	0	AMI	- М	СВ			Χ	Sin	gle			Mounting	
	•	1 Section		X	MLO	225	AMP BUS (Copper			Copper)		Dοι	ıble			Surface	
	1	-Nema Rating					·				Feed -			d - Thru			X Flush	
Notes	Load (VA)	Descripti	Description		Wire	СВ	CKT #	PH	CKT #	СВ	,	Wire	Туре		Description		Load (VA)	Notes
		SPACE					1	Α	2					SPACE				
		SPACE					3	В	4					SPACE				
		SPACE					5	С	6					SPACE				
		SPACE					7	Α	8				WH				5000	
		SPACE					9	В	10	25/3		10	WH	EWH-4			5000	
		SPACE					11	С	12				WH				5000	
		SPACE					13	Α	14					SPACE				
		SPACE					15	В	16					SPACE				
		SPACE					17	С	18					SPACE				
		SPACE					19	Α	20	40/1		8	WH	IWH-1			8320	
		SPACE					21	В	22	40/1		8	WH	IWH-2			8320	
		SPACE					23	С	24					SPACE				
		SPACE					25	Α	26					SPACE				
		SPACE					27	В	28					SPACE				
		SPACE					29	С	30					SPACE				
	0	Subtotal													Subtotal		31,640	
N.E.C	. (2011)	Load Type	Conn.		Fct.	Divers	sity	N.E	E.C. ((2011)		Load Ty	уре		Conn.	Fct.	Diver	sity
22	0.44	R) Recept.	0			0			220.	12	(L) Li	ghting			0	125%	0	
22	0.56	K) Kitchen	0		100%	0			220.	12	(EL) Ext. Ltg.			0	125%	0		
22	0.60	C) Cooling	0		0%	0			620.	14	(E) E	levators	S		0	100%	0	
22	0.60	H) Heating	0		0%	0					(WH)	Water	Ht.		31,640	100%	31,6	40
22	0.60	F) Fans	0	100%		0			220	.5		Lrg. Mo			0	125%	.∥ o	
63	0.11	W) Welders	0			0					(SP)	Sub Pa	anel		0	100%	.∥ o	
	-	M) Misc.	0		100%	0												
		Total Connected Total Load (Dive			31,640 31,640		38 38		AMF	-	Loc	ation c	of Par	nel:				

			F	Pan	elbo	ard	L	M:	SE	BL1		10,	000 AIC Rating Existing X New				
	120/208 Volt,3-Phase,4-Wire 1 Section 1 -Nema Rating			х	MCB MLO	0 AMP MCB 225 AMP BUS (Copper)) X	Sir Do Fee		Mounting Surface X Flush			
Notes	Load (VA)	Descripti	on	Туре	Wire	СВ	CKT #	РН	CKT #	СВ	Wire	Туре	Description		Load (VA)	Notes	
	900	RM109			12	20/1	1	Α	2	20/1	12	R	RM108-STUDENT S	TA.	900		
	900	RM110		R	12	20/1	3	В	4	20/1	12	R	RM108-STUDENT S	TA.	900		
	720	RM108-INCUBA	TOR	М	12	20/1	5	С	6	20/1	12	R	RM108-STUDENT S	TA.	900		
	720	RM108-INCUBA	TOR	М	12	20/1	7	Α	8	20/1	12	R	RM108-STUDENT S	TA.	900		
	900	RM108-REAR C	OUNT.	R	12	20/1	9	В	10	20/1	12	R	RM108-STUDENT S	TA.	900		
	900	RM108-REAR C	OUNT.	R	12	20/1	11	С	12	20/1	12	R	RM108-STUDENT S	TA.	900		
	900	RM108-REAR C	OUNT.	R	12	20/1	13	Α	14	20/1	12	R	RM108-STUDENT S	TA.	900		
	900	RM108-FRONT	COUNT.	R	12	20/1	15	В	16	20/1	12	R	RM108-STUDENT S	TA.	900		
	720	RM108-TV'S		R	12	20/1	17	С	18	20/1	12		RM108-STUDENT S	TA.	900		
	900	RM108-TEACHE	RS STA.	R	12	20/1	19	Α	20	20/1	12	R	RM108-STUDENT S	TA.	900		
	900	RM108-STUDEN	NT STA.	R	12	20/1	21	В	22	20/1	12	R	RM108-STUDENT S	TA.	900		
	900	RM108-STUDEN	NT STA.	R	12	20/1	23	С	24	20/1	12	R	RM108-STUDENT S	TA.	900		
	900	RM108-STUDEN	NT STA.	R	12	20/1	25	Α	26	20/1	12	R	RM108-STUDENT S	TA.	900		
	900	RM111		R	12	20/1	27	В	28	20/1	12	R	RM108-STUDENT S	TA.	900		
	900	RM111	R	12	20/1	29	С	30	20/1	12	R	RM108-STUDENT S	TA.	900			
	900	RM111	R	12	20/1	31	Α	32	20/1	12	R	RM108-STUDENT S	TA.	900			
	900	RM111		R	12	20/1	33	В	34	20/1	12	R	RM108-STUDENT S	RM108-STUDENT STA.			
	900	RM111		R	12	20/1	35	С	36	20/1	12	R	RM108-STUDENT S	M108-STUDENT STA.			
	360	RM109-COUNTE	ER .	R	12	20/1	37	Α	38	20/1	12	R	RM108-STUDENT S	TA.	900		
	360	RM109-ICE MAI	KER	R	12	20/1	39	В	40	20/1	12	R	RM108-STUDENT S	TA.	900		
	540	RM109-REFRIG	ERATOR	R	12	20/1	41	С	42	20/1	12	R	RM108-STUDENT S	TA.	900		
~	-180	LAB UTILITY CO	MIROL	₩~	12	20/1	43	Α	44	20/1	12	МТ	CIRCULATION PUN	IP CP-4	250		
	500	FUME HOOD		М	12	20/1	45	В	46	20/1	12	МТ	EF-U-5		528		
	500	FUME HOOD		М	12	20/1	47	С	48	20/1	12		SPARE BREAKER				
	500	FUME HOOD		М	312	20/1	49	Α	50	20/1	12		SPARE BREAKER				
	500	FUME HOOD		М	12	20/1	51	В	52	60/2	6	М	AUTOCLAVE		4650		
~	~~~	SPARE BREAK	ER	~~	12	20/1	53	С	54	00/2		М	AUTOCLAVE		4650		
	19,100	Subtotal					•			•		.,	Subtota	I	28,978		
.E.C	. (2011)	Load Type	Conn.		Fct.	Divers	sity	N.E	E.C. ((2011)	Loa	d Type	Conn.	Fct.	Dive	sity	
22	0.44 (R) Recept.	34,38)		22,1	90	Ì	220.	12	(L) Light	ing	0	125%	5 C)	
22	П,	K) Kitchen 0			100%	o			220.		(EL) Ext	-	0	125%	, c)	
	ш`	C) Cooling 0			0%	ll l		620.14			(E) Eleva	•	O)	
		H) Heating	, <u> </u>		0%		0				(WH) Water Ht.		O)	
	11 `	F) Fans	0		100%	ō			220		(MT) Lrg		778	125%	II .		
	ш`	W) Welders	0			o					(SP) Sul		0	100%	II .		
	11 '	M) Misc.	12,920	o	100%	12,9	20			, , = 3							


			F	Pan	elbo	ard	L	M	SB	L2		10,0	000 AIC Rating Existing X New			
	120/208	Volt,3-Phase,4-	Wire		MCB	0	AMI	- М	СВ		X	Sin	gle		Mounti	ng
1 Section 1 -Nema Rating			Х	MLO	100	AMP BUS (Copper			Copper)		Dou	ible		Surface		
											Fee	d - Thru		X Flush		
Notes	Load (VA)	Descripti	ion	Туре	Wire	СВ	CKT #	PH	CKT #	СВ	Wire	Туре	Description		Load (VA)	Note
	900	RM113-FRONT	COUNT.	R	12	20/1	1	Α	2	20/1	12	R	RM113-STUDENT S	TA.	900	
	900	RM113-FRONT	COUNT.	R	12	20/1	3	В	4	20/1	12	R	RM113-STUDENT S	TA.	900	
	900	RM113-TEACHE	ERS STA.	R	12	20/1	5	С	6	20/1	12	R	RM113-STUDENT S	TA.	900	
	720	RM113-TV'S		R	12	20/1	7	Α	8	20/1	12	R	RM113-STUDENT ST	TA.	900	
	900	RM113-REAR C	COUNT.	R	12	20/1	9	В	10	20/1	12	R	RM113-STUDENT S	TA.	900	
	900	RM113-REAR C	COUNT.	R	12	20/1	11	С	12	20/1	12	R	RM113-STUDENT ST	TA.	900	
	900	RM113-REAR C	COUNT.	R	12	20/1	13	Α	14	20/1	12	R	RM113-STUDENT ST	TA.	900	
	900	RM114, RM115		R	12	20/1	15	В	16	20/1	12	R	RM113-STUDENT ST	TA.	900	
	900	RM114-COUNT	ER	R	12	20/1	17	С	18	20/1	12	R	RM113-STUDENT ST	TA.	900	
	900	RM114-COUNT	ER	R	12	20/1	19	A	20	20/1	12	R	RM113-STUDENT S	TA.	900	
	900	RM114-ICE MA	KER	R	12	20/1	21	В	22	20/1	12	R	RM113-STUDENT ST	TA.	900	
	900	RM114-REFRIG	ERATOR	R	12	20/1	23	С	24	20/1	12	R	RM113-STUDENT S	TA.	900	
	900	RM113-STUDE	NT STA.	R	12	20/1	25	A	26	20/1	12	R	RM113-STUDENT S	TA.	900	
	900	RM113-STUDE	NT STA.	R	12	20/1	27	В	28	20/1	12	R	RM113-STUDENT S	TA.	900	
	900	RM113-STUDE	NT STA.	R	12	20/1	29	С	30	20/1	12	R	RM113-STUDENT S	TA.	900	
\sim	180~	LAB UTILITY CO	ONTROL	₩-	12	20/1	31	Α	32	20/1	12	R	RM113-STUDENT S	TA.	900	
	528	EF-U-4		МТ	12	20/1	33	В	34	20/1	12	R	RM113-STUDENT S	TA.	900	
	500	FUME HOOD		М	₹ 12	20/1	35	С	36	20/1	12	R	RM113-STUDENT S	TA.	900	
	500	FUME HOOD		М	12	20/1	37	A	38	20/1	12	R	RM113-STUDENT S	TA.	900	
	500	FUME HOOD		М	₹ 12	20/1	39	В	40	20/1	12	R	RM113-STUDENT S	TA.	900	
~~		SPARE BREAK	ER		12	20/1	41	С	42	20/1	12	R	RM113-STUDENT S	TA.	900	
	15,528	Subtotal			ı	Ш						Ш	Subtotal		18,900	
N.E.C	. (2011)	Load Type	Conn.		Fct.	Divers	sity	N.E	E.C. (2011)	Load T	уре	Conn.	Fct.	Diver	sity
220	0.44 (R) Recept.	32,220)		21,1	10		220.	12	(L) Lighting		0	125%	0	
220	0.56 (K) Kitchen	0		100%	0		220.12		12	(EL) Ext. Lt	g.	0	125%	0	
220	0.60	C) Cooling	0		0%	0			620.	14	(E) Elevators	s	0	100%	0	
22	0.60 (H) Heating	0		0%	0					(WH) Water Ht.		0	100%	0	
220	0.60 (F) Fans	· "		100%	0			220	.5	(MT) Lrg. Mot.		528	125%	66	0
630	0.11	(W) Welders 0				0					(SP) Sub Pa	anel	0	100%	o	
		M) Misc.	1,680		100%	1,68	30									
	<u>''</u>	Total Connected			34,428 23,450				AMF	ll ll	Location o	of Par	el:		'	

Total Connected Load = 48,078 VA = 133.6 AMPS Location of Panel:

36,083 VA = 100.2 AMPS

Total Load (Diversified)=

LIGHT FIXTURE SCHEDULE											
TYPE	MANUF.	CATALOG No.	MOUNTING		LAMPS	001.00	VOLTAGE	INPUT W	MOUNTING	REMARKS	NOTES:
				# TYPE		COLOR			HEIGHT *		
Х	LITHONIA	LQM-S-W-3-R-120/277-EL N	SURFACE	-	LED	-	MVOLT	6	-	LED EXIT SIGN WITH RED LETTERING.	
		ES TO ALL FIXTURES NOT SURFACE MOUNTED TO CEILING O SE ON DRAWINGS. IT IS THE CONTRACTORS RESPONSIBILITY		•							XTURE,
					NOTES:						
	ALL FIXTURES WITH 'E' SUFFIX (A1E) SHALL HAVE [BODINE GTD -OR- EMERGENCY BATTERY PACK].										

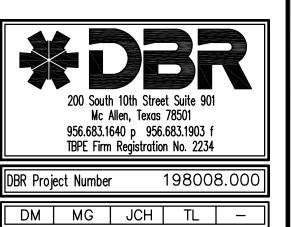

GIGNAC | ARCHITECTS

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Consultants: MELDEN & HUNT

STRUCTURAL:

ASSOCIATES INC.

GREEN, RUBIANO &

DBR ENGINEERING





PSJA ISD

NORTH ECHS & COLLEGE

UNIVERSITY **CAMPUS**

STUDENT **RESTROOM RENOVATIONS**

KEYPLAN

Project Number: 19.04 Drawing Date: 5-10-2019 Drawn: Checked: 1/4" = 1'-0" Scale: ACAD File: A-240-U Revisions:

2 Addendum #2 - 2019.5.28


ELECTRICAL SCHEDULES

^{2.} ALUMINUM FEEDERS ARE NOT APPROVED FOR USE ON THE FOLLOWING:

TRANSFORMER SECONDARY ELEVATORS

VARIABLE FREQUENCY DRIVE 3. ELECTRICAL CONTRACTOR SHALL PROVIDE THE NUMBER OF LUGS AND PROPER LUG SIZES TO ACCEPT CONDUCTOR SIZES SHOWN. 4. GROUND NOT REQUIRED AT SERVICE LATERAL.

^{5.} ALUMINUM CONDUCTORS MAY BE USED FOR FEEDERS RATED FOR GREATER THAN 200 AMPS EXCEPT FOR EQUIPMENT LOADS. ALL MOTORS, CHILLERS, ETC. SHALL REQUIRE THE USE OF COPPER CONDUCTORS ONLY.

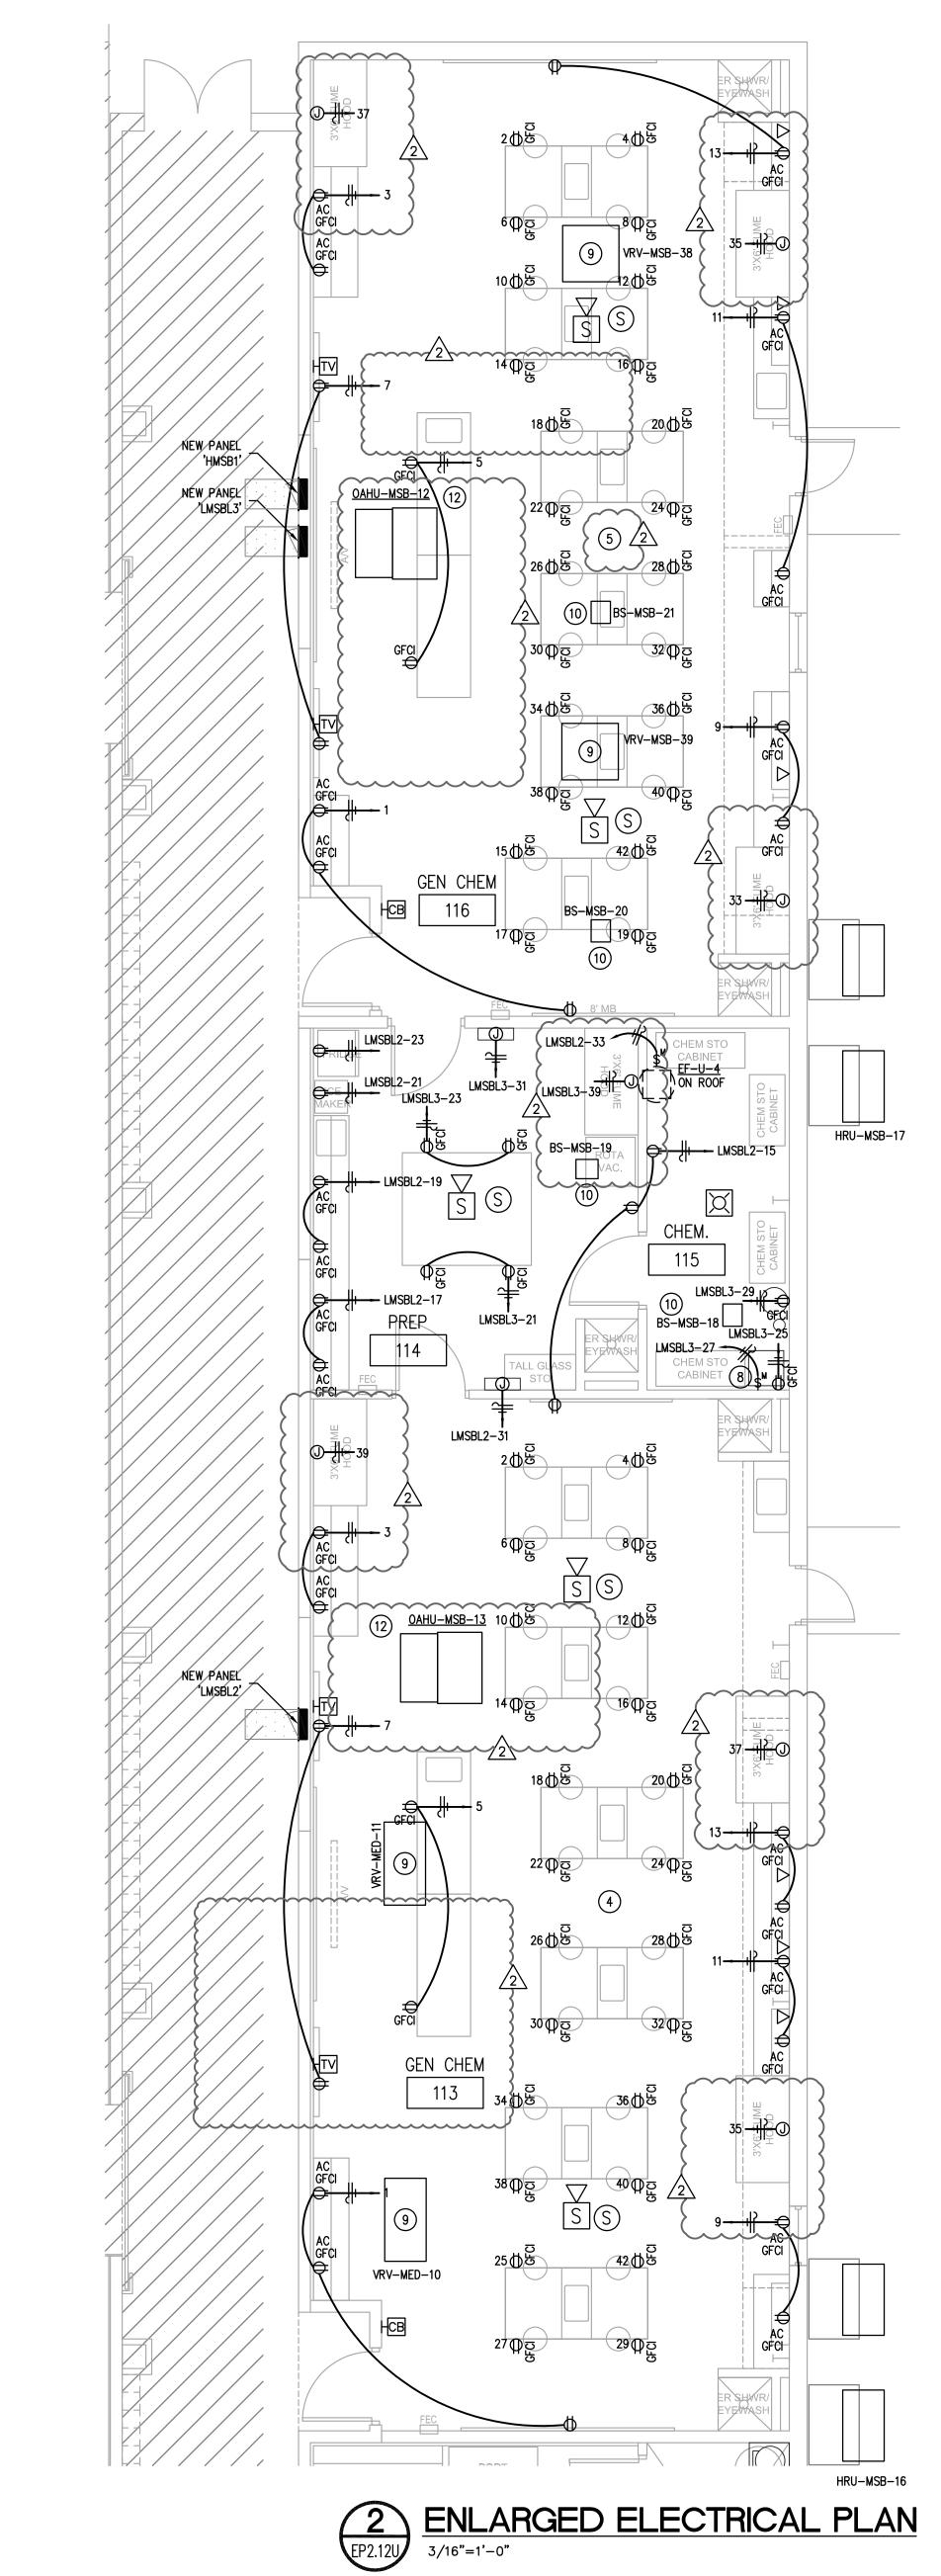



- A. ELECTRICAL CONTRACTOR SHALL GROUP HOMERUNS WITH THREE HOTS

 GIGNAC ARCHITECTS BRANCH CIRCUITS. NO MORE THAN 2 MULTI-WIRE HOMERUNS PER
- B. CONTRACTOR SHALL VERIFY DEVICE LOCATIONS WITH ARCHITECT PRIOR TO ROUGH-IN. REFER TO ARCHITECTURAL CASEWORK AND MILLWORK ELEVATIONS.
- C. ELECTRICAL CONTRACTOR SHALL REFERENCE TECHNOLOGY DRAWINGS FOR ADDITIONAL CONDUIT AND BACK BOX REQUIREMENTS. DIVISION 26 SHALL PROVIDE ALL PATHWAYS FOR LOW VOLTAGE SYSTEMS. DIVISION 26 CONTRACTOR SHALL COORDINATE WITH DIVISION 27 AND 28 CONTRACTORS FOR PATHWAY AND ROUGH-IN NEEDS.
- D. ELECTRICAL CONTRACTOR SHALL COORDINATE WITH MECHANICAL
- SHOWN ON ELECTRICAL DRAWINGS. COORDINATE EXACT LOCATIONS
- WITH MECHANICAL AND PLUMBING CONTRACTOR.
- G. PROVIDE A DEDICATED HOT, NEUTRAL, AND GROUND FOR ALL COPY
- CONTRACTOR SHALL INDICATE CIRCUIT SERVING EACH RECEPTACLE BY PROVIDING TYPE WRITTEN LABELING LOCATED ON INSIDE FACE OF
- J. ELECTRICAL CONTRACTOR SHALL ROUTE ELECTRICAL CONDUIT AND WIRING TO ALL ROOF HVAC EQUIPMENT THROUGH ROOF CURBS. ELECTRICAL CONTRACTOR SHALL COORDINATE WITH MECHANICAL CONTRACTOR PRIOR TO ROUGH-IN.
- K. MECHANICAL CONTRACTOR SHALL FURNISH INTEGRAL DISCONNECT SHALL BE PROVIDED BY DIVISION 26.
- L. PROVIDE JUNCTION BOX AND POWER FOR ALL HARD WIRED PLUMBING FLUSH VALVES AND SENSOR EQUIPMENT TRANSFORMERS FROM ROUGH-IN FOR EXACT LOCATION.
- MECHANICAL ROOMS, ELEVATOR PITS OR SHAFTS, ELEVATOR EQUIPMENT ROOMS, SERVING ELECTRIC DRINKING FOUNTAINS OR VENDING MACHINES, LOCATED WITHIN 6' OF A SINK, LOCATED ABOVE A WET COUNTERTOP OR IN A KITCHEN OR COFFEE BAR SHALL BE GFCI. EACH GFCI PROTECTED RECEPTACLE SHARING THE SAME
- N. POWER TO RECEPTACLE DEVICES AT STUDENT STATIONS SHALL COME FROM BELOW SLAB. ROUTE CONDUIT IN SAME TRENCH AS PLUMBING UTILITIES AND STUB INTO FURNITURE STORAGE SPACE. REFER TO ARCHITECTURAL MILLWORK DETAILS FOR STUB UP LOCATION.

KEYED NOTES:

- 1. #12 WIRE, 3/4"C TO NEAREST PANEL. PROVIDE NEW 20A/1P
- 2. CONNECT TO EXISTING ELECTRICAL WATER COOLER CIRCUIT. FIELD

- 6. ALL CIRCUIT IN THIS SPACE ARE FED FROM PANEL 'LMSBL4'.
- BY SCHOOL DISTRICT. CONDUIT SHALL BE ROUTED BELOW SLAB. COORDINATE ROUTING WITH OTHER TRADES.
- 8. PROVIDE FLEXIBLE, LIQUID TIGHT CONNECTION TO PUMP.
- 9. EXTEND CONDUIT AND CIRCUIT WIRING TO RELOCATE VRV CASSETTE.
- 11. CONNECT NEW VRV-MSB-46 EQUIPMENT TO EXISTING DISCONNECT AND CIRCUIT. EXTEND CONDUIT AND CIRCUIT WIRING AS REQUIRED. 12. TYPICAL OF ALL OUT SIDE AIR UNITS. RELOCATE DISCONNECT WITH UNIT AND EXTEND ELECTRICAL CIRCUIT AS REQUIRED. COORDINATE

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RESTROOM

RENOVATIONS

KEYPLAN

2\ Addendum #2 - 2019.5.28

ENLARGED ELECTRICAL POWER PLANS - UNIV. CAMPUS

5-10-2019

1/4" = 1'-0"

A-240-U

Project Number:

Drawing Date:

Drawn: Checked:

Scale:

ACAD File:

Revisions:

STRUCTURAL:

CONTRACTOR FOR ALL EXHAUST FAN CONTROLS. PROVIDE A FAN

SWITCH IF INDICATED BY MECHANICAL. ALL EXHAUST FANS SHALL B PROVIDED WITH BUILT-IN DISCONNECT SWITCH. E. HVAC AND PLUMBING EQUIPMENT MAY DIFFER FROM LOCATIONS AS

F. ALL RECEPTACLES MOUNTED ABOVE COUNTERS AND WITHIN 6 FEET OF SINKS OR LAVATORIES SHALL BE GFCI TYPE.

H. CONTRACTOR SHALL PROVIDE HANDLE TIES MANUFACTURED BY THE SWITCH GEAR SUPPLIER ON ALL MULTI-WIRE CIRCUITS TO MEET THE REQUIREMENTS OF ARTICLE 210.4(B) OF THE 2011 NEC. AT THE CONTRACTOR'S OPTION, TWO AND THREE POLE BREAKERS MAY BE

EACH RECEPTACLE COVER PLATE.

SWITCH FOR ALL MECHANICAL EQUIPMENT. ELECTRICAL CONNECTIONS


NEAREST 120V/20A CIRCUIT. COORDINATE WITH PLUMBER PRIOR TO M. ALL RECEPTACLES LOCATED IN RESTROOMS, JANITOR CLOSETS,

CIRCUIT SHALL HAVE ITS OWN RE-SET AND TEST BUTTON.

- BREAKER AS REQUIRED.
- 3. ALL CIRCUIT IN THIS SPACE ARE FED FROM PANEL 'LMSBL1'.
- 4. ALL CIRCUIT IN THIS SPACE ARE FED FROM PANEL 'LMSBL2'.
- 5. ALL CIRCUIT IN THIS SPACE ARE FED FROM PANEL 'LMSBL3'.
- 7. PROVIDE SINGLE GANG BOX, 1" CONDUIT WITH PULL STRING FOR INSTALLATION OF DATA DEVICES. DEVICES AND CABLING INSTALLED

- 10. EXISTING BRANCH SELECTORS TO REMAIN.

UNIT LOCATION WITH MECHANICAL CONTRACTOR.

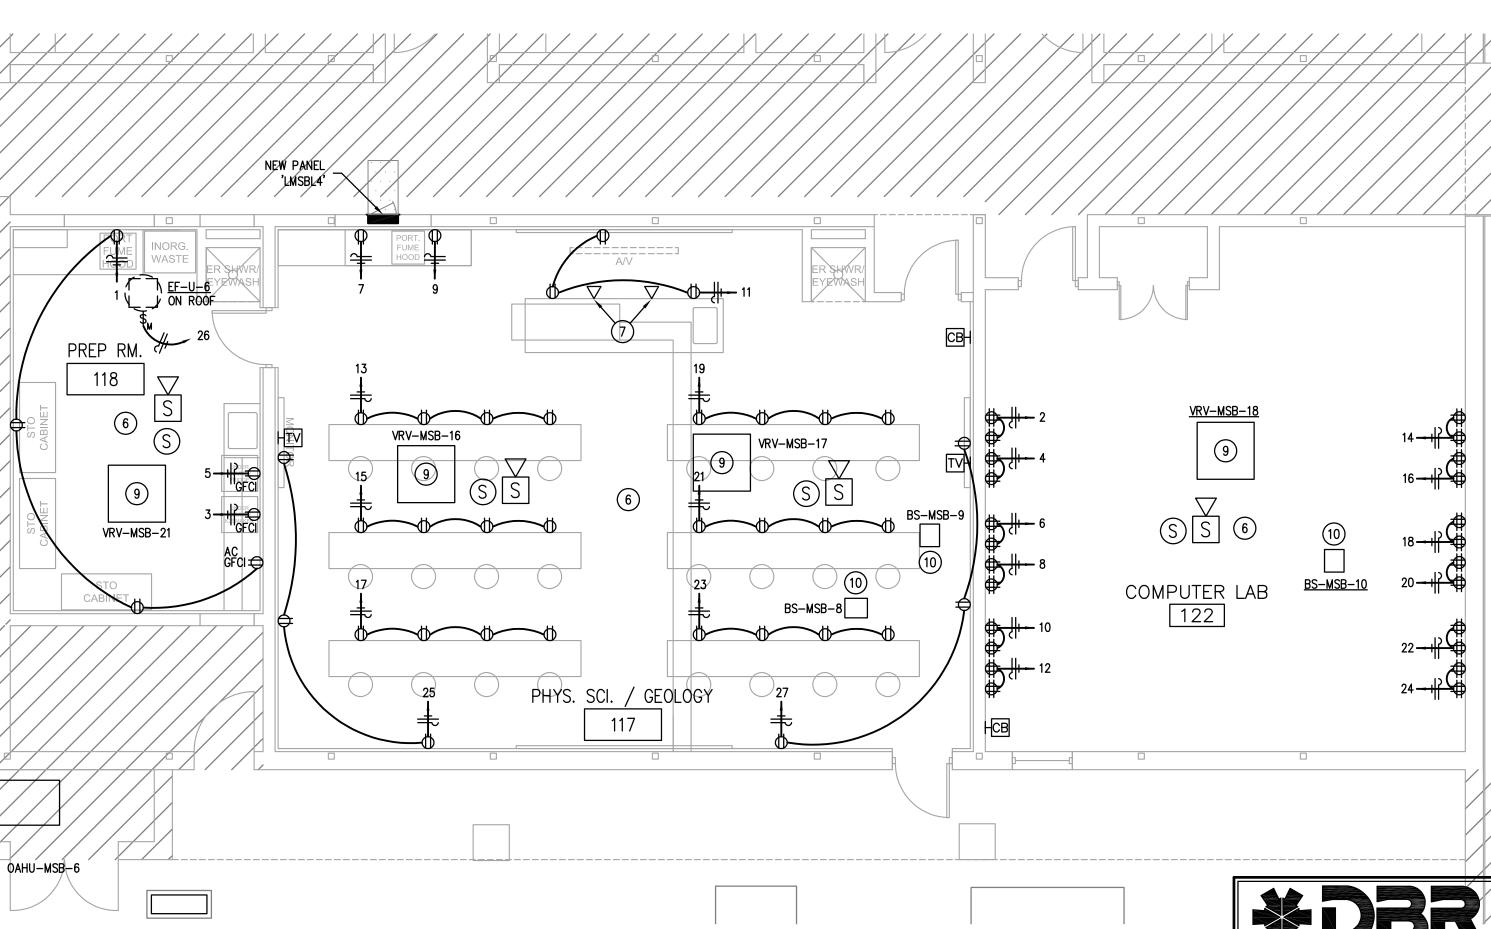

ENLARGED ELECTRICAL PLAN

*DBR 200 South 10th Street Suite 901 Mc Allen, Texas 78501 956.683.1640 p 956.683.1903 f TBPE Firm Registration No. 2234 DBR Project Number

DM MG JCH TL

EP2.12U

May 28, 2019 - 8:26 N:\19\198008.000\

OAHU-MSB-11

MICROBIO/ORG CHEM

108

ORG. PREP RM.

ENLARGED ELECTRICAL PLAN

BS-MSB-15

110