RENOVATIONS AT ADMINISTRATION BUILDING

SANTA ROSA INDEPENDENT SCHOOL DISTRICT SANTA ROSA, TX

SANTA ROSA ISD BOARD OF TRUSTEES

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HERIBERTO VILLARREAL, SUPERINTENDENT

OWNER'S REPRESENTATIVE

HERIBERTO VILLARREAL, SUPERINTENDENT 102 JESUS R. CRUZ, SANTA ROSA, TEXAS 78593 PHONE: 956-636-9800, FAX: 956-636-1439

INDEX OF DRAWINGS

COVER SHEET PROJECT DATA ACCESSIBILTY SCHEDULE & DETAILS

FLOOR PLAN & ROOM FINISH SCHEDULE DOOR & WINDOW SCHEDULES / ELEVATIONS & DETAILS



ALTERNATES ARCHITECTURAL ALTERNATES ALTERNATE A-1: SECURITY CAMERA SYSTEM ALTERNATE A-2: ACCESS CONTROLLED CARD READERS FOR DOORS **GENERAL NOTES** GENERAL CONTRACTOR SHALL VISIT THE SITE TO INSPECT EXISTING CONDITIONS WITH REGARD TO THE SCOPE OF WORK PRIOR TO BIDDING PROJECT. IMMEDIATELY NOTIFY ARCHITECT IN WRITING OF ANY QUANTITIES, ETC. PRIOR TO SUBMITTING BID. 3. ALL EXISTING ITEMS TO REMAIN OR BE RELOCATED SHALL BE PROTECTED FROM DAMAGE DURING CONSTRUCTION. ALL EXISTING ITEMS TO REMAIN WHICH ARE DAMAGED DURING CONSTRUCTION SHALL BE REPAIRED OR REPLACED BY THE CONTRACTOR AT NO ADDITIONAL COST TO THE OWNER, AS DIRECTED BY 4. CONTRACTOR TO LEGALLY DISPOSE OF ALL CONSTRUCTION DEBRIS, EXCESS SOIL, EXTRA MATERIALS AND 5. AT NO TIME DURING THE PROCESS OF THE WORK SHALL THE CONTRACTOR INTERRUPT THE CONTINUITY OWNER. ANY DAMAGE TO THESE SERVICES SHALL BE REPAIRED BY THE CONTRACTOR AT NO COST TO 6. CONTRACTOR SHALL WALK THE SITE, WHERE THE WORK WILL TAKE PLACE, WITH THE OWNER'S REPRESENTATIVE AND IDENTIFY, LOCATE AND PHOTOGRAPH ALL DAMAGED WALKS, ETC. TO DETERMINE LOCATION AND AMOUNTS OF EXISTING DAMAGE PRIOR TO BEGINNING WORK. MAIL A COPY OF THE LIST AND PHOTOGRAPHS TO THE OWNER AND THE ARCHITECT. VIDEO TAPE WITH VERBAL DESCRIPTION AND CALL BEFORE YOU DIG!



48 HOURS NOTICE BEFORE YOU DIG, DRILL, OR BLAST - STOP AND CALL

811

THE LONE STAR NOTIFICATION COMPANY AT 1-800-669-8344

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ATION

KEYPLAN

REVISION:

SHEET NUMBER

A001

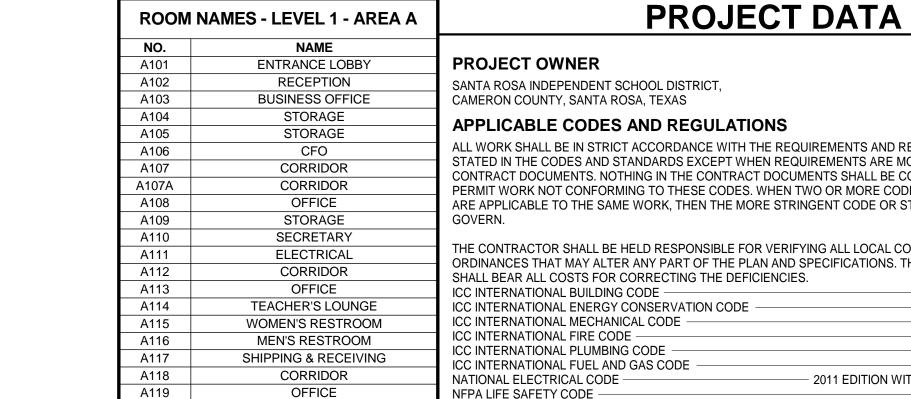
COVER SHEET

SET NO.

MECHANICAL, ELECTRICAL & PLUMBING ENGINEERS DBR ENGINEERING CONSULTANTS. INC.

400 MANN ST #602, CORPUS CHRISTI, TX 78401 PHONE: 361-888-5797

RCP, FLOOR GRAPHICS PLAN, ENLARGED PLANS, & FIXTURE SCHEDULE **EXTERIOR & INTERIOR ELEVATIONS** WALL SECTIONS, PARTITION SCHEDULE, DETAILS, & EXP. JOINTS MEP101 ROOF LEVEL MEP DEMO PLAN ROOF LEVEL MEP PLAN MECHANICAL SYMBOLS AND ABBREVIATIONS LEVEL 1 MECHANICAL DEMO PLAN LEVEL 1 MECHANICAL PLAN LA RUSSIA AVE. MECHANICAL DETAILS AND SCHEDULES ELECTRICAL SYMBOL LEGEND LEVEL 1 LIGHTING DEMO PLAN AMARILLO LEVEL 1 LIGHTING PLAN LEVEL 1 POWER DEMO PLAN LEVEL 1 POWER PLAN LEVEL 1 FIRE ALARM PLAN **ELECTRICAL DETAILS AND SCHEDULES** ELECTRICAL SCHEDULES **ELECTRICAL DETAILS AND SCHEDULES** C EL PASO **ELECTRICAL DETAILS AND SCHEDULES** JESUS R. CRUZ ST.. **ELECTRICAL DETAILS AND SCHEDULES** ELECTRICAL DETAILS AND SCHEDULES LEVEL 1 TECHNOLOGY & SECURITY DEMO PLAN EXISTING SANTA ROSA LEVEL 1 TECHNOLOGY & SECURITY PLAN ADMINISTRATION SANTA VISTA AVE. BUILDING SAN ANTONIO **PLUMBING** LEVEL 1 PLUMBING DEMO PLAN JESUS AVILA ST. KINGSVILLE LEVEL 1 PLUMBING PLAN PLUMBING SCHEDULES AND DETAILS SANTA ROSA-LOCATION MAP VICINITY MAP



A120

A121

A122

A128

A129

A130

A134

CORRIDOR

CUSTODIAN

CORRIDOR

CLASSROOM

STORAGE

CLASSROOM

CORRIDOR

CORRIDOR

SECRETARY

STORAGE

RESTROOM

IDF ROOM

SUPERINTENDENT

ALL WORK SHALL BE IN STRICT ACCORDANCE WITH THE REQUIREMENTS AND RECOMMENDATIONS STATED IN THE CODES AND STANDARDS EXCEPT WHEN REQUIREMENTS ARE MODIFIED BY THE CONTRACT DOCUMENTS. NOTHING IN THE CONTRACT DOCUMENTS SHALL BE CONSTRUED TO PERMIT WORK NOT CONFORMING TO THESE CODES. WHEN TWO OR MORE CODES OR STANDARDS ARE APPLICABLE TO THE SAME WORK, THEN THE MORE STRINGENT CODE OR STANDARD SHALL THE CONTRACTOR SHALL BE HELD RESPONSIBLE FOR VERIFYING ALL LOCAL CODES AND ORDINANCES THAT MAY ALTER ANY PART OF THE PLAN AND SPECIFICATIONS. THE CONTRACTOR 2012 EDITION 2015 EDITION 2012 EDITION 2012 EDITION 2012 EDITION - 2012 EDITION 2011 EDITION WITH LOCAL AMENDMENTS NFPA LIFE SAFETY CODE -- 2012 EDITION - 2012 EDITION FLOOD HAZARD PREVENTION CODE -ASHRAE GUIDE -LATEST EDITION **BOY'S RESTROOM** TEXAS ACCESSIBILITY STANDARDS -2012 TAS EDITION CITY OF SANTA ROSA -ADOPTED CODES AND AMENDMENTS TO CODE GIRL'S RESTROOM TEXAS DEPARTMENT OF INSURANCE WINDSTORM AREA ———— (NOT USED - IS AN EXISTING BUILDING, TDI IS NOT IN SCOPE OF PROJECT) 110 M.P.H. INLAND II (WITH 3 SECOND GUST) (TDI)

BUILDING CLASSIFICATION

RENOVATION - EXISTING BUILDING AREA PRIMARY OCCUPANCY CLASSIFICATION -- BUSINESS, GROUP B PRIMARY OCCUPANCY WITH EDUCATIONAL GROUP E, ACCESSORY OCCUPANCY 9TH THROUGH 12TH GRADE **EXISTING CONSTRUCTION TYPE** — TYPE II B (ASSUMED) NEW CONSTRUCTION TYPE CLASSIFICATION — - TYPE II B (BUILDING ÉLEMENTS NONCOMBUSTIBLE MATERIALS) NONSEPARATED USE

ALLOWABLE BUILDING AREA AND HEIGHT (t. 503) -- 14,500 S.F. / 2 STORIES / 55 FEET 1. ALLOWABLE BUILDING AREA (WITH SPRINKLER INCREASE) - = 58,000 S.F.2. ACTUAL BUILDING AREA --= 14,257 S.F. (FRONTAGE INCREASE NOT INCLUDED, SINCE NOT REQUIRED -= (SINGLE STORY, < 24 FEET) 3. ACTUAL BUILDING HEIGHT -

FIRE PROTECTION SYSTEM (903) -- BUSINESS (B) / EDUCATIONAL (E) 1. SPRINKLER SYSTEM -- REQUIRED AND SPECIFIED (& VOICE ALARM COMMUNICATION) 2. FIRE ALARM SYSTEM -REQUIRED AND SPECIFIED 3. REFER TO FIRE SEPARATION PLAN, SHEET A002 FOR FIRE AREAS, WALLS, BARRIERS, AND PARTITIONS

= IN COMPLIANCE CODE REQUIREMENTS FIRE BARRIERS AND MEANS OF EGRESS PER CODE, AS SHOWN ON PLAN.

FIRE-RESISTANCE RATING FOR BUILDING (TABLE 601) - 0 HOUR RATED 1. PRIMARY STRUCTURAL FRAME 2. BEARING WALLS 0 HOUR RATED 3. NON-BEARING WALLS AND PARTITIONS -- 0 HOUR RATED 4. FLOOR CONSTRUCTION — - 0 HOUR RATED

5. ROOF CONSTRUCTION AND SECONDARY MEMBERS 0 HOUR RATED 6. INCIDENTAL USES (t.509) - RATED AS SHOWN ON FIRE SEPARATION PLAN = ALL IN COMPLIANCE

MEANS OF EGRESS WIDTHS
DOOR WIDTH 36" = 33" OPENING/.20" = 165 O.L. (RE: 1005.3.2) (WITH SPRINKLER = 33" OPENING/.15" = 220 O.L.) = ALL IN COMPLIANCE

PLUMBING FIXTURE COUNT (IN COMPLIANCE) = MIXED BUSINESS / EDUCATIONAL TOTAL OCCUPANT LOAD = 194/2 = 97 MALE & 97 FEMALE

MALE = REQUIRED 4 WATER CLOSETS & 3 LAVATORIES = PROVIDED 5 WATER CLOSETS & 3 LAVATORIES = IN COMPLIANCE (REFER TO BELOW FEMALE = REQUIRED 4 WATER CLOSETS & 3 LAVATORIES = PROVIDED 5 WATER CLOSETS & 3 LAVATORIES = IN COMPLIANCE (REFER TO BELOW) (UNISEX = PROVIDED 1 WATER CLOSETS & 1 LAVATORY)

STUDENTS = 75/2 = 38 MALE & 38 FEMALE (FOR CLASSROOMS) MALE = REQUIRED 1 WATER CLOSET & 1 LAVATORY = PROVIDED 3 WATER CLOSETS & 2 LAVATORIES FEMALE = REQUIRED 1 WATER CLOSET & 1 LAVATORY = PROVIDED 3 WATER CLOSETS & 2 LAVATORIES

<u>ADULTS</u> = 119/2 = 60 MALE & 60 FEMALE MALE = REQUIRED 3 WATER CLOSETS & 2 LAVATORIES = PROVIDED 5 WATER CLOSETS & 3 LAVATORIES FEMALE = REQUIRED 3 WATER CLOSETS & 2 LAVATORIES = PROVIDED 5 WATER CLOSETS & 3 LAVATORIES (UNISEX = PROVIDED 1 WATER CLOSET & 1 LAVATORY)

STRUCTURAL DESIGN CRITERIA

REFER TO STRUCTURAL PLANS

ROOF LIVE LOAD — WIND LOAD ---FLOOR LIVE LOAD

A. OFFICE (NOT INCLUDING PARTITIONS) B. PUBLIC AREAS, CORRIDORS, LOBBIES C. MECHANICAL ROOMS D. STORAGE (MINIMUM) E. CLASSROOMS —

STRUCTURE/ROOF SYSTEM -AND GIRTS, METAL ROOF DECK ROOF - EXISTING BUILT-UP TAR AND GRAVEL

UTILITY SERVICE INFORMATION

DOMESTIC WATER SOURCE - CITY OF SANTA ROSA SANITARY SEWER SERVICE - CITY OF SANTA ROSA - EXISTING ROOF SURFACE RUNOFF, SLOPED TO EDGE STORM SEWER SYSTEM (BUILDING) -WITH GUTTERS & DOWNSPOUTS. - EXISTING CITY SYSTEM, SURFACE RUNOFF STORM SEWER SERVICE (SITE) - EXISTING, VERIFY ON SITE ELECTRICAL SERVICE SOURCÉ -FROM THE EXISTING ADJACENT BUILDING

HVAC DESIGN CRITERIA

RATED WALL, BARRIER & PARTITION LEGEND

1 HOUR FIRE RATED WALL (EXTERIOR)

REFER TO FLOOR PLANS, PARTITION SCHEDULE, AND DOOR AND WINDOW

NOTE: ALL DOORS, FRAMES, WINDOWS AND GLASS IN FIRE RATED WALLS AND PARTITIONS ARE FIRE RATED. REFER TO DOOR AN WINDOW SCHEDULES AND SPECIFICATIONS.

SHEET NUMBER **A002**

KEYPLAN

A135 1768 SF A135 BOARDROOM A136 EXECUTIVE SESSION O.L. 45 RECORDS CORRIDOR A127 767 SF O.L. 39 A129 381 SF 2 HOUR FIRE RAJED WALL A134 200 SF A123 O.L. 2 EXISTING H.S. A125 719 SF /BUILDING/ O.L. 36 A121 A102 314 SF O.L. 4 O.L. 2 O.L. 2 A107 244 SF O.L. 5 1/HOUR FIRE RATED FXTERIOR WALL/ A106 378 SF O.L. 4 257 SF O.L. 3 O.L. 4

O.L. 19

O.L. 2

A136 418 SF

O.L. 21

1 FIRE SEPARATION - OCCUPANT LOADS & EGRESS PLAN

1/8" = 1'-0"

EXISTING H.S.

_BUILDING/

1 HOUR FIRE RATE

EXTERIOR WALL

MINISTR/ 4 - EXISTING (20 P.S.F.) - 100 M.P.H. (IS A TEXAS FIRST TIER COASTAL COUNTY TOI WINDSTORM AREA, BUT TDI IS NOT BEING USED - IS AN EXISTING BUILDING, TDI IS NOT IN SCOPE OF PROJECT) - EXISTING (50 P.S.F.) - EXISTING (100 P.S.F.) ENO — EXISTING (150 P.S.F.) - EXISTING (125 P.S.F.) - EXISTING (40 P.S.F.) EXISTING ADMINISTRATION BUILDING FOUNDATION SYSTEM EXISTING STRUCTURAL REINFORCED CONCRETE SLAB ON EXISTING STEEL COLUMNS, BEAMS, JOISTS, CHANNELS, TUBES

= IN COMPLIANCE

ELECTRICAL SERVICE SIZE -

DESIGN CONDITIONS (OUTSIDE TEMPERATURE) - 99 DEGREES FDB, 80 DEGREES FWB — 37 DEGREES FAHRENHEIT

2 HOUR FIRE RATED WALL, EXTEND 30" ABOVE BOTH ROOFS, OR FLOOR TO ROOF DECK IF BOTH BUILDINGS HAVE CLASS B ROOF COVERING

> SMOKE **RESISTANT** PARTITION, FLOOR TO CEILING OR ROOF DECK (INCIDENTAL USE AREAS IN SPRINKLERED BUILDINGS) (CONSTRUCTION CAPABLE OF RESISTING THE PASSAGE OF SMOKE; NOT A RATED SMOKE BARRIER NOR A RATED SMOKE PARTITION)

SCHEDULES

PROJECT DATA

ARCHITECTS

711 N. Carancahua, Suite 404

Corpus Christi, Texas 78401

American Bank Plaza

Phone: 361.884.7442

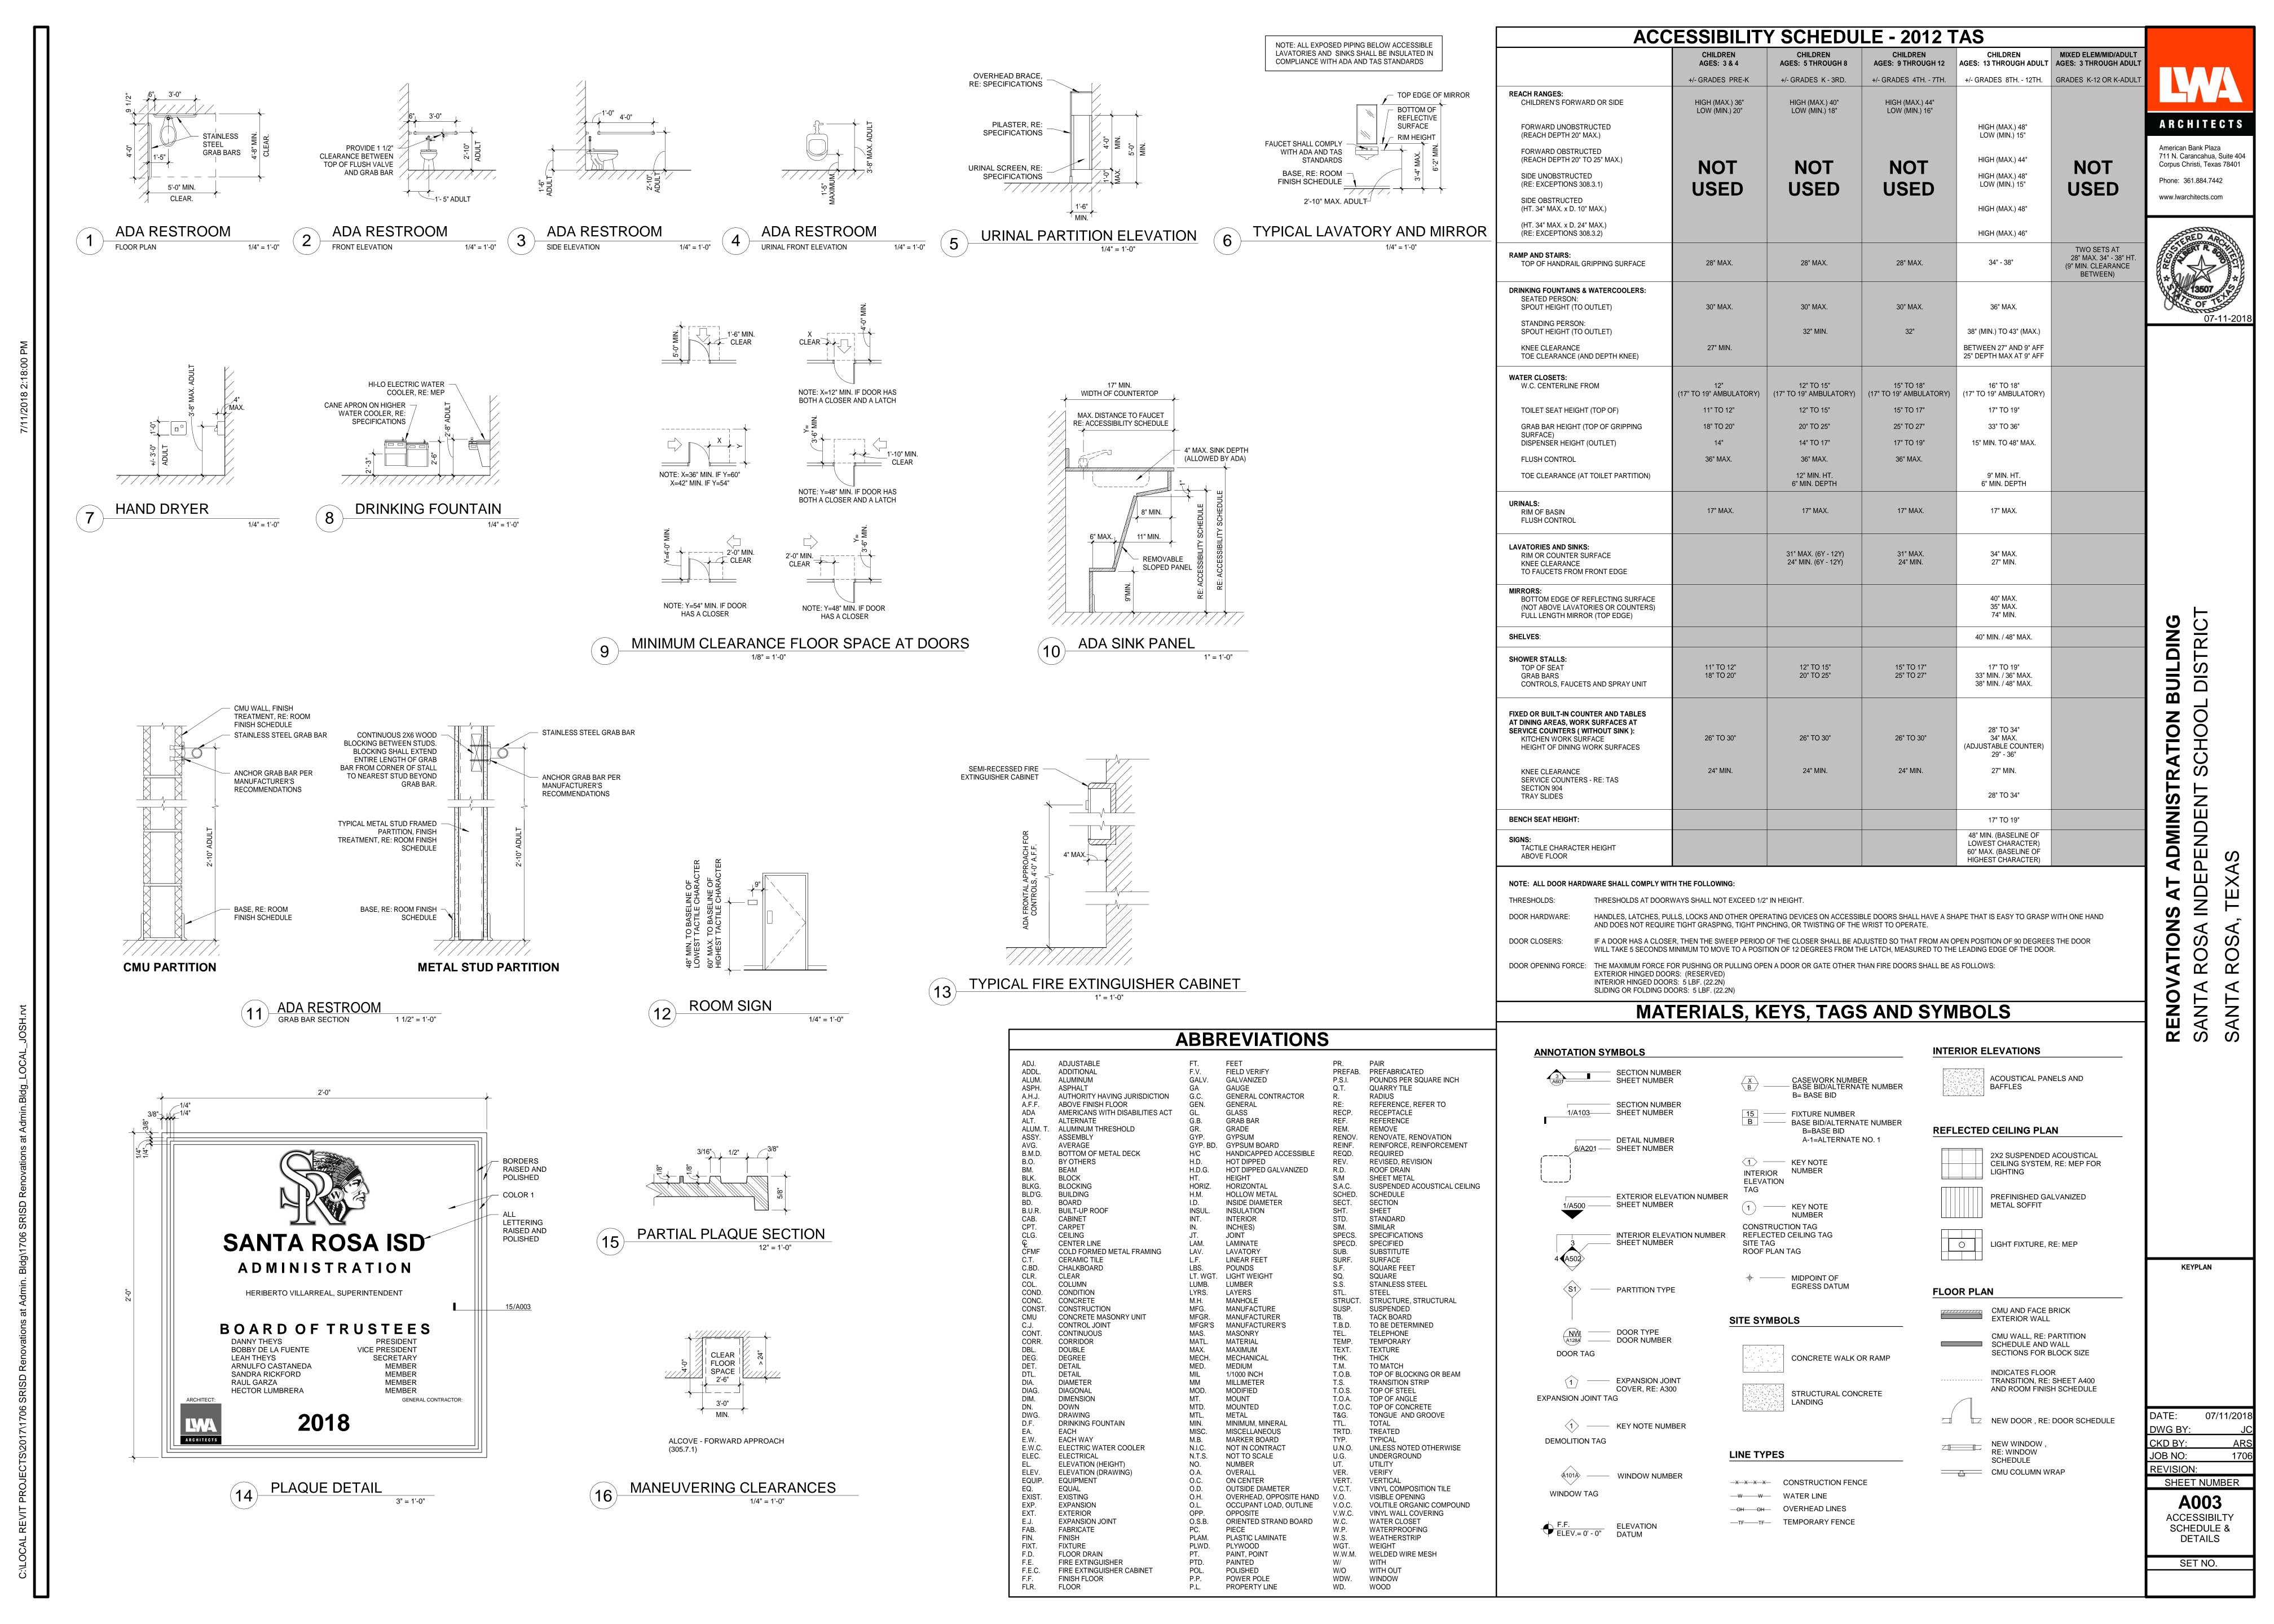
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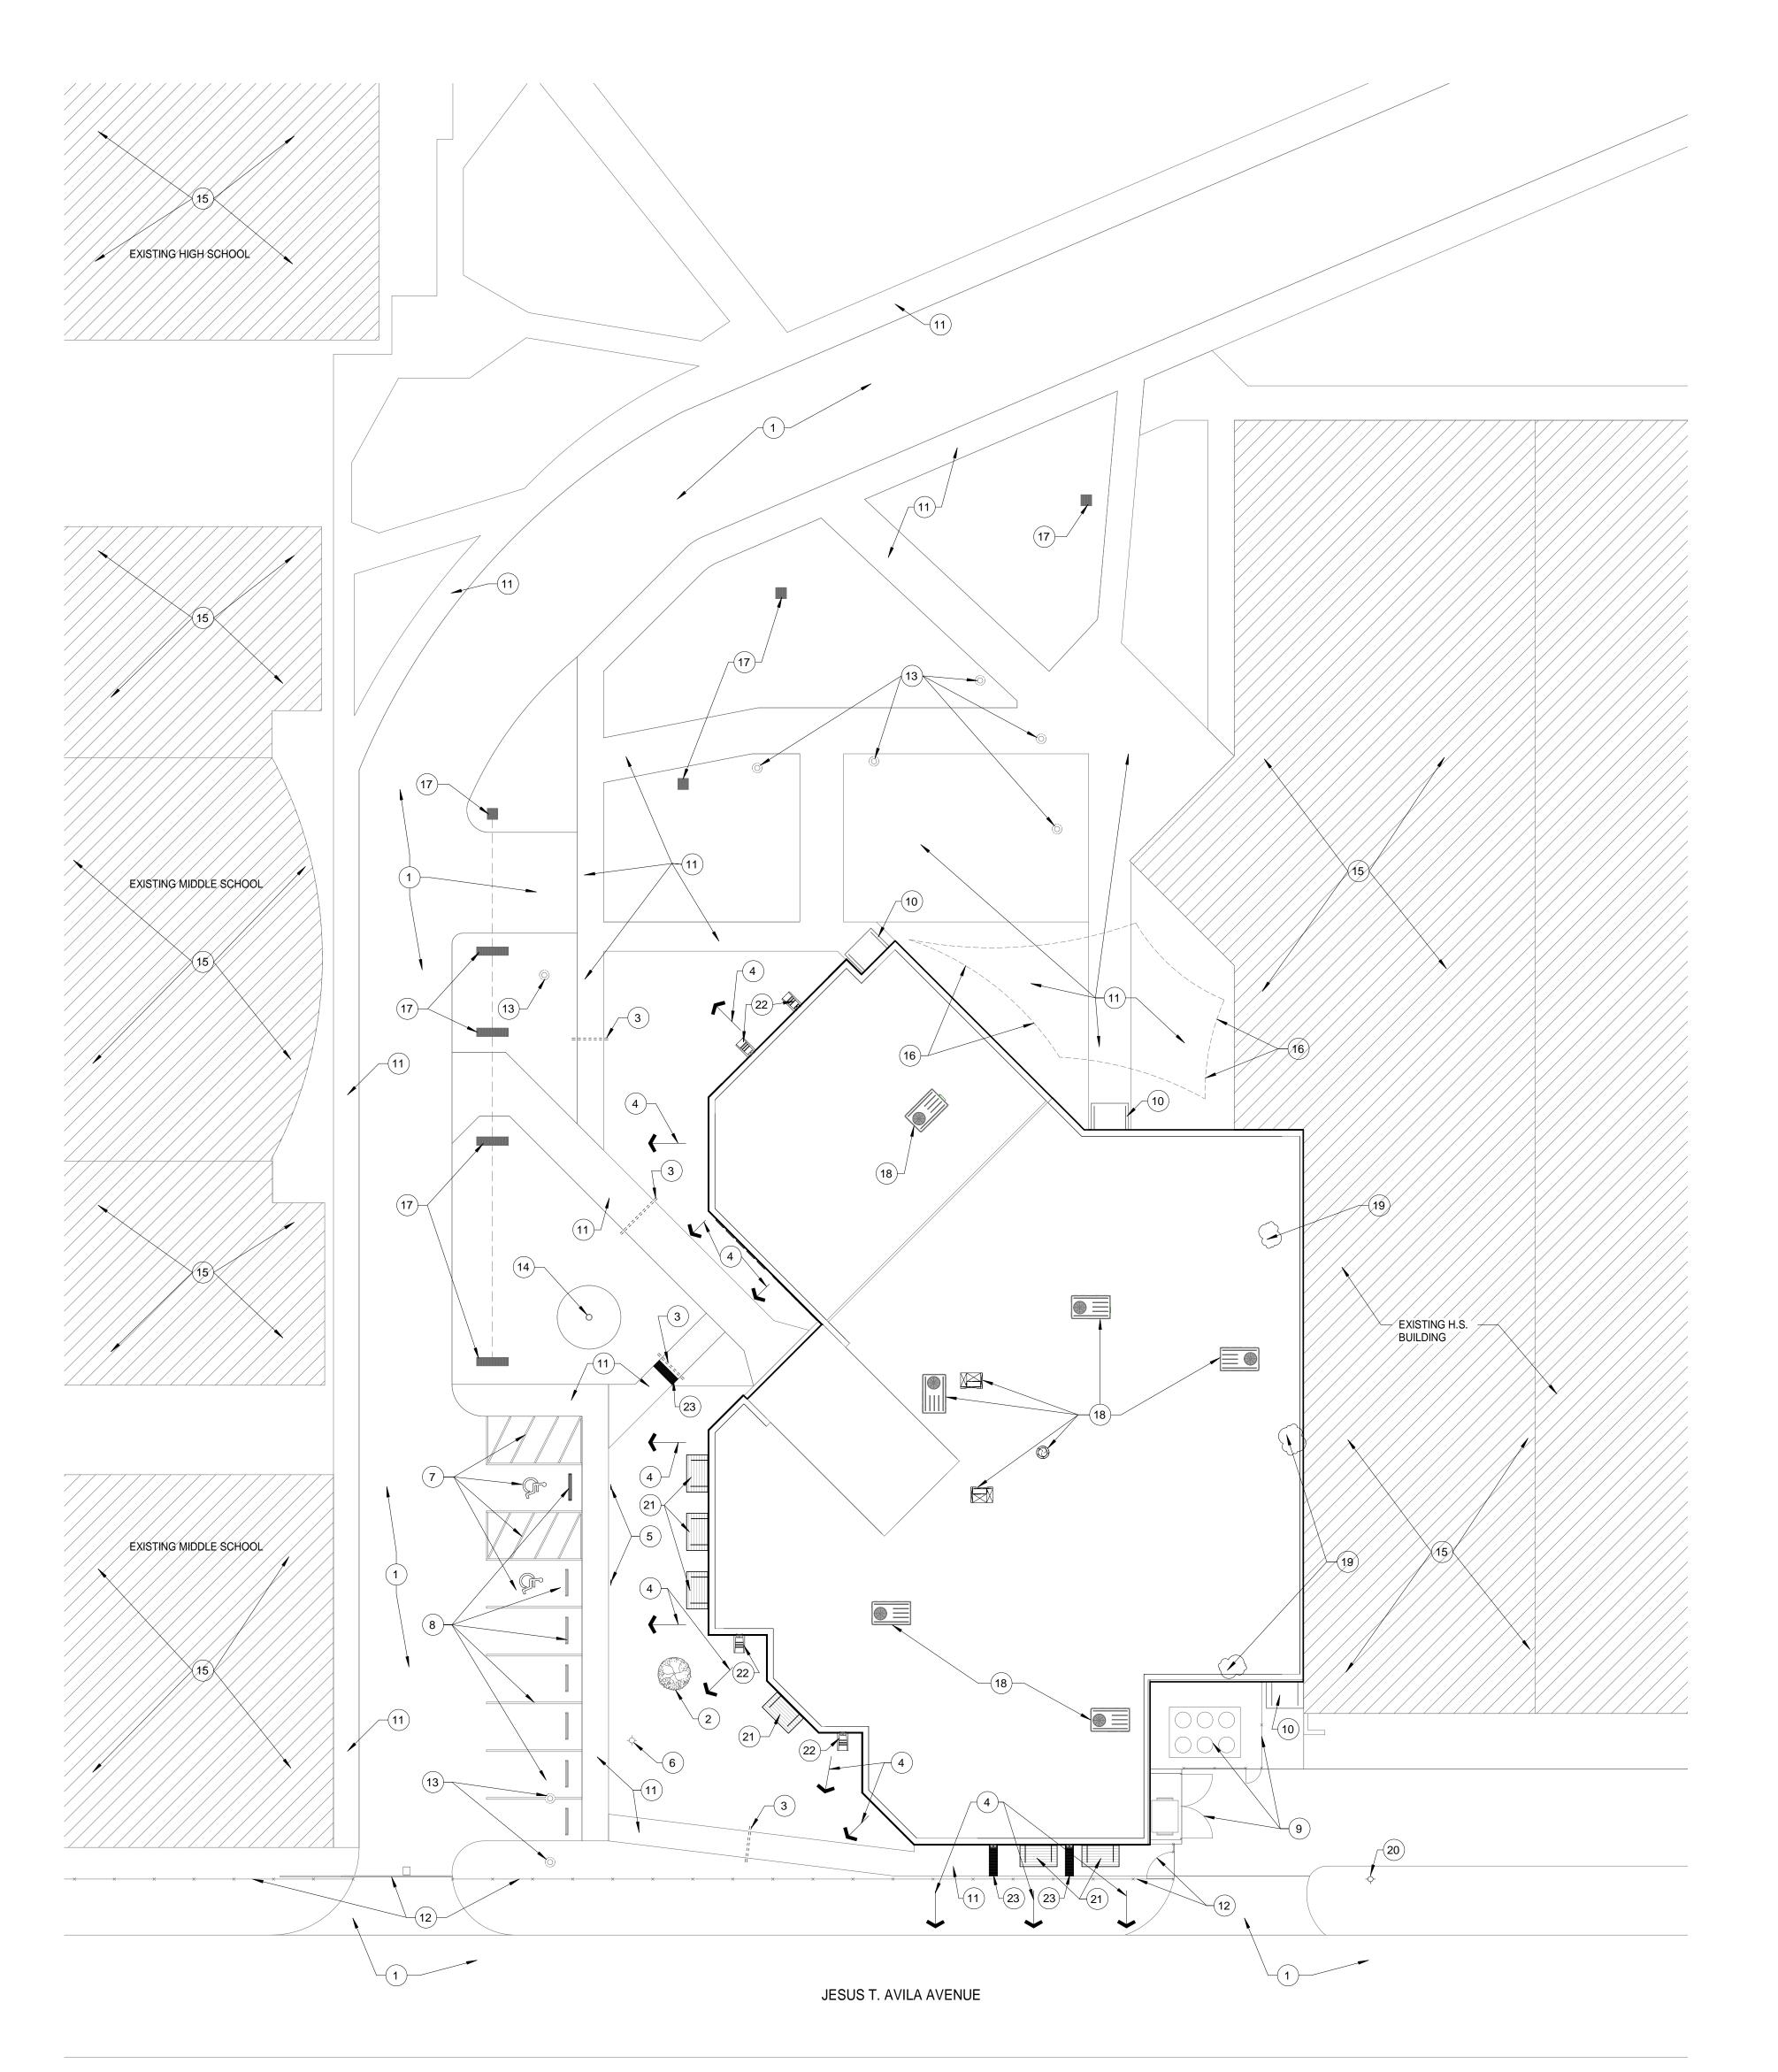
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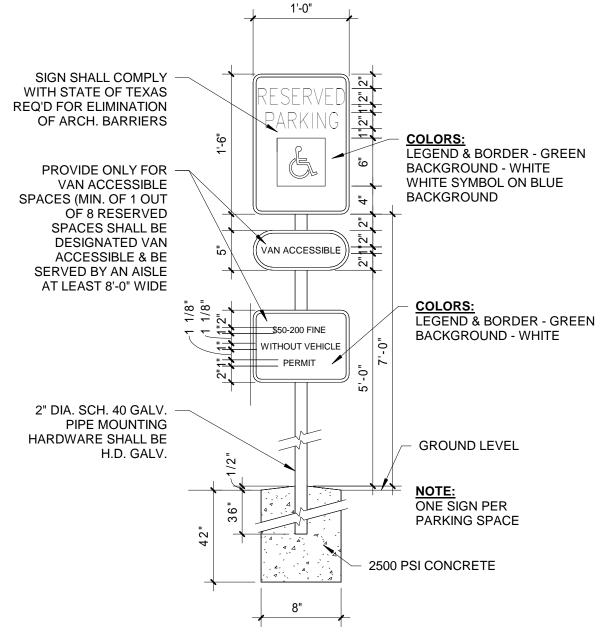
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SET NO.









2 ADA PARKING SIGN
1" = 1'-0"

SITE PLAN GENERAL NOTES

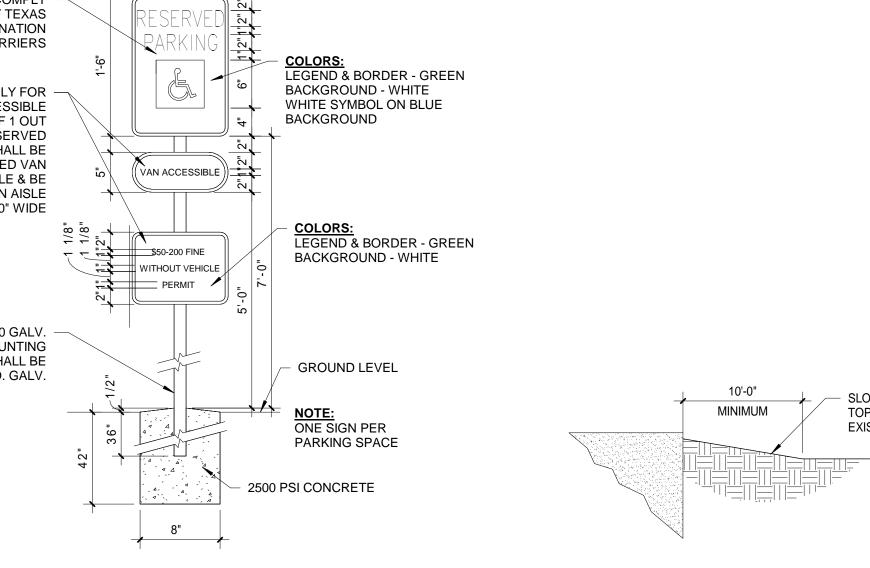
- A. IT IS THE RESPONSIBILITY OF THE CONTRACTOR TO NOTIFY ALL APPROPRIATE UTILITY COMPANIES 48 HOURS PRIOR TO ACTUAL CONSTRUCTION WORK FOR THE LOCATION OF ANY EXISTING UTILITIES
- B. REFER TO SHEET A002 FOR ADDITIONAL INFORMATION

DETERMINED BY THE ARCHITECT.

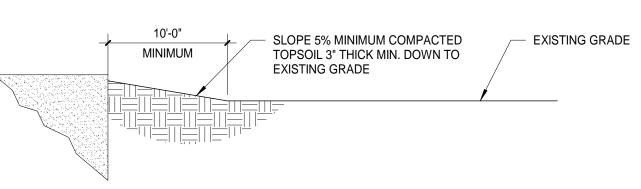
- C. CONTRACTOR SHALL COORDINATE WORK, DIMENSIONS, AND ETC. WITH MEP DRAWINGS AND
- D. FINISH FLOOR ON THE EXISTING ADMINISTRATION BUILDING IS 100'-0" ARCHITECTURAL E. CONSTRUCTION SITE SHALL BE FENCED AND FULLY SECURED THROUGHOUT THE CONSTRUCTION PROCESS. CONTRACTOR SHALL REMOVE FENCE UPON COMPLETION OF THE PROJECT AND RETURN THE LANDSCAPING/GRADES BACK TO THEIR ORIGINAL CONDITION AS
- WHEN CONSTRUCTION IS COMPLETE, REMOVE ALL CONSTRUCTION RELATED DEBRIS (i.e. CONCRETE, STEEL, WOOD), REGRADE AND RAKE SMOOTH EXISTING AREAS.

SITE PLAN KEYED NOTES

- (1) EXISTING STREETS/DRIVEWAYS AND CURBS TO REMAIN AND BE PROTECTED
- (2) EXISTING TREE TO REMAIN AND BE PROTECTED, KEEP HEAVY EQUIPMENT AWAY FROM THE DRIP LINE OF THE TREE INSTALL (2) 4" CAPPED PVC SLEEVES AS INDICATED, PROPERLY MARK AND DOCUMENT
- (4) SLOPE 5% MINIMUM COMPACTED TOPSOIL 3" THICK MINIMUM DOWN TO EXISTING GRADE 10' FROM BUILDING MINIMUM, RE: 3/A100.
- (5) INTERNATIONAL SYMBOL PARKING SIGN, 2' INTO GROUND WITH 16" DIAMETER CONCRETE
- FOOTING. RE: 2/A100. SIGN TO BE LOCATED 7'-0" A.F.G. (6) PROTECT EXISTING FIRE HYDRANT TO REMAIN.
- (7) EXISTING TAS ACCESSIBILITY PARKING AND SIDE ACCESS TO REMAIN.
- (8) EXISTING PARKING STALLS AND TIRE STOPS TO REMAIN AND BE PROTECTED.
- (9) EXISTING MECHANICAL EQUIPMENT AND FENCING TO REMAIN AND BE PROTECTED. SEE MEP FOR MECHANICAL EQUIPMENT DIRECTION.
- (10) EXISTING DOORS AND DOOR CANOPIES TO REMAIN AND BE PROTECTED.
- (11) EXISTING CONCRETE WALKS TO REMAIN AND BE PROTECTED. (12) EXISTING FENCE, SLIDING GATE AND HINGED GATE TO REMAIN AND BE PROTECTED
- (13) EXISTING POWER POLES TO REMAIN AND BE PROTECTED
- (14) EXISTING FLAG POLE TO REMAIN AND BE PROTECTED
- (15) PROTECT EXISTING SCHOOL BUILDINGS.
- (16) PROTECT EXISTING FABRIC CANOPY.
- (17) PROTECT EXISTING AREA GRATES, DRAINS, CULVERTS AND DITCHES.
- (18) SEE MEP FOR EXISTING ROOFTOP HVAC EQUIPMENT.
- (19) CONTRACTOR TO VERIFY EXACT LOCATIONS OF EXISTING ROOF LEAKS WITH ARCHITECT AND OWNER. REPAIR LEAKS AS RECOMMENDED BY MANUFACTURER OF EXISTING ROOF
- (20) EXISTING FIRE HOSE CONNECTION TO REMAIN AND BE PROTECTED.
- (21) ALUMINUM WINDOW CANOPY, RE: SPECIFICATIONS AND DETAILS.
- (22) CONCRETE SPLASH BLOCK, RE: 4/A200.
- (23) SIDEWALK DRAIN, RE: 5/A200.







KEYPLAN

SHEET NUMBER A100 SITE PLAN

SET NO.

ARCHITECTS American Bank Plaza 711 N. Carancahua, Suite 404 Corpus Christi, Texas 78401 Phone: 361.884.7442 www.lwarchitects.com

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- ADMINISTRATION E

PENDENT SCHOOL

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RENOV. SANTA I



A138

A128

1 DEMOLITION PLAN

1/8" = 1'-0"

A126

A125

A117

EXISTING H.S.

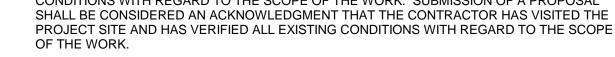
STRUCTURE/

ROOM NAMES - LEVEL 1 - AREA A ENTRANCE LOBBY RECEPTION BUSINESS OFFICE A104 STORAGE STORAGE A106 A107 CORRIDOR A107A CORRIDOR OFFICE A109 STORAGE SECRETARY ELECTRICAL CORRIDOR OFFICE A114 TEACHER'S LOUNGE WOMEN'S RESTROOM A116 MEN'S RESTROOM SHIPPING & RECEIVING A118 CORRIDOR OFFICE CORRIDOR BOY'S RESTROOM CUSTODIAN GIRL'S RESTROOM CORRIDOR CLASSROOM STORAGE CLASSROOM A128 CORRIDOR CORRIDOR SECRETARY SUPERINTENDENT STORAGE RESTROOM IDF ROOM A135 BOARDROOM A136 EXECUTIVE SESSION RECORDS CORRIDOR

DEMOLITION PLAN GENERAL NOTES

A. GENERAL CONTRACTOR SHALL COORDINATE THE WORK OF ALL TRADES AND INSURE ALL
DEMOLITION WORK IS COMPLETED IN A TIMELY MANNER AND ACCORDING TO THE PROJE
SCHEDULE. GENERAL CONTRACTOR SHALL INSURE THAT THERE IS NO DISRUPTION TO T
EXISTING FACILITIES WHICH ARE TO REMAIN IN PLACE AND OPERATIONAL.

B. GENERAL CONTRACTOR SHALL VISIT THE SITE PRIOR TO BIDDING TO INSPECT EXISTING CONDITIONS WITH REGARD TO THE SCOPE OF THE WORK. SUBMISSION OF A PROPOSAL



EXISTING BUILDINGS UTILITIES, SITE IMPROVEMENTS, PAVING, WALKS, CANOPIES, TREES. GRASS, ETC. INDICATED TO REMAIN SHALL BE PROTECTED AT ALL TIMES. DO NOT ALLOW

NON-RUBBER TIRED EQUIPMENT TO WORK IN THESE AREAS. . EXISTING BUILDINGS, STREETS UTILITIES, SITE IMPROVEMENTS, PAVING, CURBS, WALKS, CANOPIES, TREES, GRASS, ETC. WHICH ARE DAMAGED DURING DEMOLITION AND CONSTRUCTION SHALL BE REMOVED, REPAIRED AND/OR REPLACED TO A LIKE NEW CONDITION AS DIRECTED BY THE ARCHITECT AT NO COST TO THE OWNER. THE

ARCHITECT SHALL BE THE SOLE JUDGE AS TO THE EXTENTS, LIMITS, DETAILS AND

GENERAL CONTRACTOR SHALL LEGALLY DISPOSE OF ALL CONSTRUCTION DEBRIS, EXCESS SOIL, EXTRA MATERIALS AND ALL DEMOLISHED MATERIALS/ITEMS.

REQUIREMENTS OF ALL REPAIRS AND/OR REPLACEMENTS BY THE GENERAL

CONTRACTOR.

GENERAL CONTRACTOR SHALL COORDINATE DEMOLITION VEHICLE'S WEIGHT LIMITS AND TRAVEL PATH TO APPROVED DUMP SITE WITH THE OWNER AND THE CITY OF SANTA ROSA AND INSURE THAT VEHICLES DO NOT UTILIZE UNAPPROVED DUMP SITES OR PATHS OF TRAVEL. GENERAL CONTRACTOR WILL BE HELD FULLY RESPONSIBLE FOR ANY ILLEGAL DUMPING, CLEAN UP AND/OR DAMAGE CAUSED BY UNAPPROVED PATHS OF TRAVEL THROUGHOUT THE DEMOLITION PROCESS.

. FOR CIVIL AND SITE UTILITY DEMOLITION REQUIREMENTS AND INFORMATION, GENERAL CONTRACTOR SHALL COORDINATE ALL ACTIVITIES/WORK BOTH INDICATED AND REQUIRED TO COMPLETE THE NEW WORK.

. REFER TO MEP DOCUMENTS FOR ADDITIONAL INFORMATION AND REQUIREMENTS. GENERAL CONTRACTOR SHALL COORDINATE ALL ACTIVITIES/WORK BOTH INDICATED AND REQUIRED TO COMPLETE THE NEW WORK.

GENERAL UTILITY NOTES

- A. IT SHALL BE THE RESPONSIBILITY OF THE GENERAL CONTRACTOR TO COORDINATE AND NOTIFY ALL APPROPRIATE UTILITY COMPANIES PRIOR TO BEGINNING/PERFORMING ANY WORK AND SHALL COORDINATE ALL UTILITY DISCONNECTS AND ASSOCIATED SERVICE INTERRUPTIONS WITH THE ARCHITECT AND OWNER.
- B. SOME EXISTING UTILITY LINES ARE SHOWN FOR INFORMATION ONLY. THE GENERAL CONTRACTOR SHALL, PRIOR TO BIDDING, FIELD VERIFY ALL EXISTING UTILITY LINES, SERVICES, MAINS, ETC. WHICH SERVE THE SITE AND FACILITIES AS WELL AS ANY UTILITIES WHICH ARE TO REMAIN IN PLACE AND IN USE.

GENERAL ELECTRICAL NOTES

- N. GENERAL CONTRACTOR SHALL VERIFY ALL EXISTING CONDITIONS AT THE PROJECT PRIOR TO BIDDING AND PRIOR TO COMMENCING ANY PORTION OF THE WORK. ADJUSTMENTS FOR FIT AND COORDINATION SHALL BE MADE AT NO ADDITIONAL COST TO THE OWNER.
- B. PROVIDE ALL APPURTENANCES REQUIRED TO REROUTE, RELOCATE, REMOVE OR REINSTALL ALL ITEMS REQUIRED TO ACCOMPLISH AND COMPLETE THE REQUIRED DEMOLITION AND NEW WORK.
- COORDINATE REMOVAL OF SPECIFIC SYSTEMS COMPONENTS WITH THE ARCHITECT/ OWNER. VERIFY THAT ALL ITEMS BEING REMOVED ARE NO LONGER IN USE OR SERVICE. PROVIDE OWNER WITH 48 HOURS ADVANCE NOTICE FOR REMOVAL OR DISRUPTION OF EXISTING IN USE ITEMS OR SERVICES.

DEMOLITION KEYED NOTES

- (1) REMOVE EXISTING DOOR, DOOR HARDWARE, DOOR FRAME AND DISPOSE OF LEGALLY
- 2 REMOVE EXISTING UPPER SHEETROCK MATERIAL AND DISPOSE OF LEGALLY
- $\langle {f 3}
 angle$ REMOVE EXISTING DRYWALL AND WOOD FRAMING OVER EXISTING WINDOW AND DISPOSE OF
- 4 REMOVE EXISTING PLYWOOD AND WOOD FRAMING IN MIDDLE OF CONFERENCE ROOM AND DISPOSE OF LEGALLY
- 5 REMOVE PVC CONDUIT DRAIN IN MEN'S RESTROOM FROM SINK DRAIN TO URINAL AND
- DISPOSE OF LEGALLY. FIX SINK DRAIN, REFER TO PLUMBING
- $\langle \mathbf{6}
 angle$ REMOVE EXISTING EXTERIOR HOLLOW METAL DOORS, HARDWARE AND DISPOSE OF LEGALL' 7 SCHOOL DISTRICT TO REMOVE ALL VCT FLOORING AND DISPOSE OF LEGALLY
- $raket{8}$ SCHOOL DISTRICT TO REMOVE ALL CEILING TILE AND CEILING GRID AND DISPOSE OF LEGALL
- (9) SCHOOL DISTRICT TO REMOVE ALL EXISTING GYPSUM BOARD AND DISPOSE OF LEGALLY
- (10) SCHOOL DISTRICT TO REMOVE ALL WOOD DOORS, HARDWARE AND ALUMINUM FRAMES AND DISPOSE OF LEGALLY
- (11) REMOVE EXISTING ALUMINUM WINDOW AND DISPOSE OF LEGALLY
- (12) REMOVE EXISTING TOILET PARTITIONS AND DISPOSE OF LEGALLY
- (13) REMOVE EXISTING PLUMBING FIXTURES AND DISPOSE OF LEGALLY
- (14) REMOVE EXISTING ELECTRIC HAND DRYER AND DISPOSE OF LEGALLY
- (15) REMOVE EXISTING WALL STUDS, DRYWALL, DOORS, HARDWARE AND FRAMES AND DISPOSE
- (16) SAW-CUT AND REMOVE 4' OF EXISTING CABINET FOR NEW AND LOWER ACCESSIBLE
- COUNTER, LEGALLY DISPOSE OF DEMOLITION MATERIAL
- (17) REMOVE EXISTING INTERIOR ALUMINUM WINDOW SYSTEM AND DISPOSE OF LEGALLY (18) REMOVE EXISTING WINDOW AWNINGS AND DISPOSE OF LEGALLY
- (19) EXISTING DOOR AWNINGS TO REMAIN
- 20 REMOVE EXISTING SHEETROCK CEILING AND DISPOSE OF LEGALLY
- 21 REMOVE EXISTING UPPER CABINETS AND DISPOSE OF LEGALLY
- REMOVE EXISTING DOOR FRAME AND DISPOSE OF LEGALLY

ARCHITECTS

American Bank Plaza 711 N. Carancahua, Suite 404 Corpus Christi, Texas 78401 Phone: 361.884.7442 www.lwarchitects.com




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KEYPLAN

SHEET NUMBER A101 DEMOLITION PLAN


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ROOM FINISH SCHEDULE LEVEL 1, AREA A



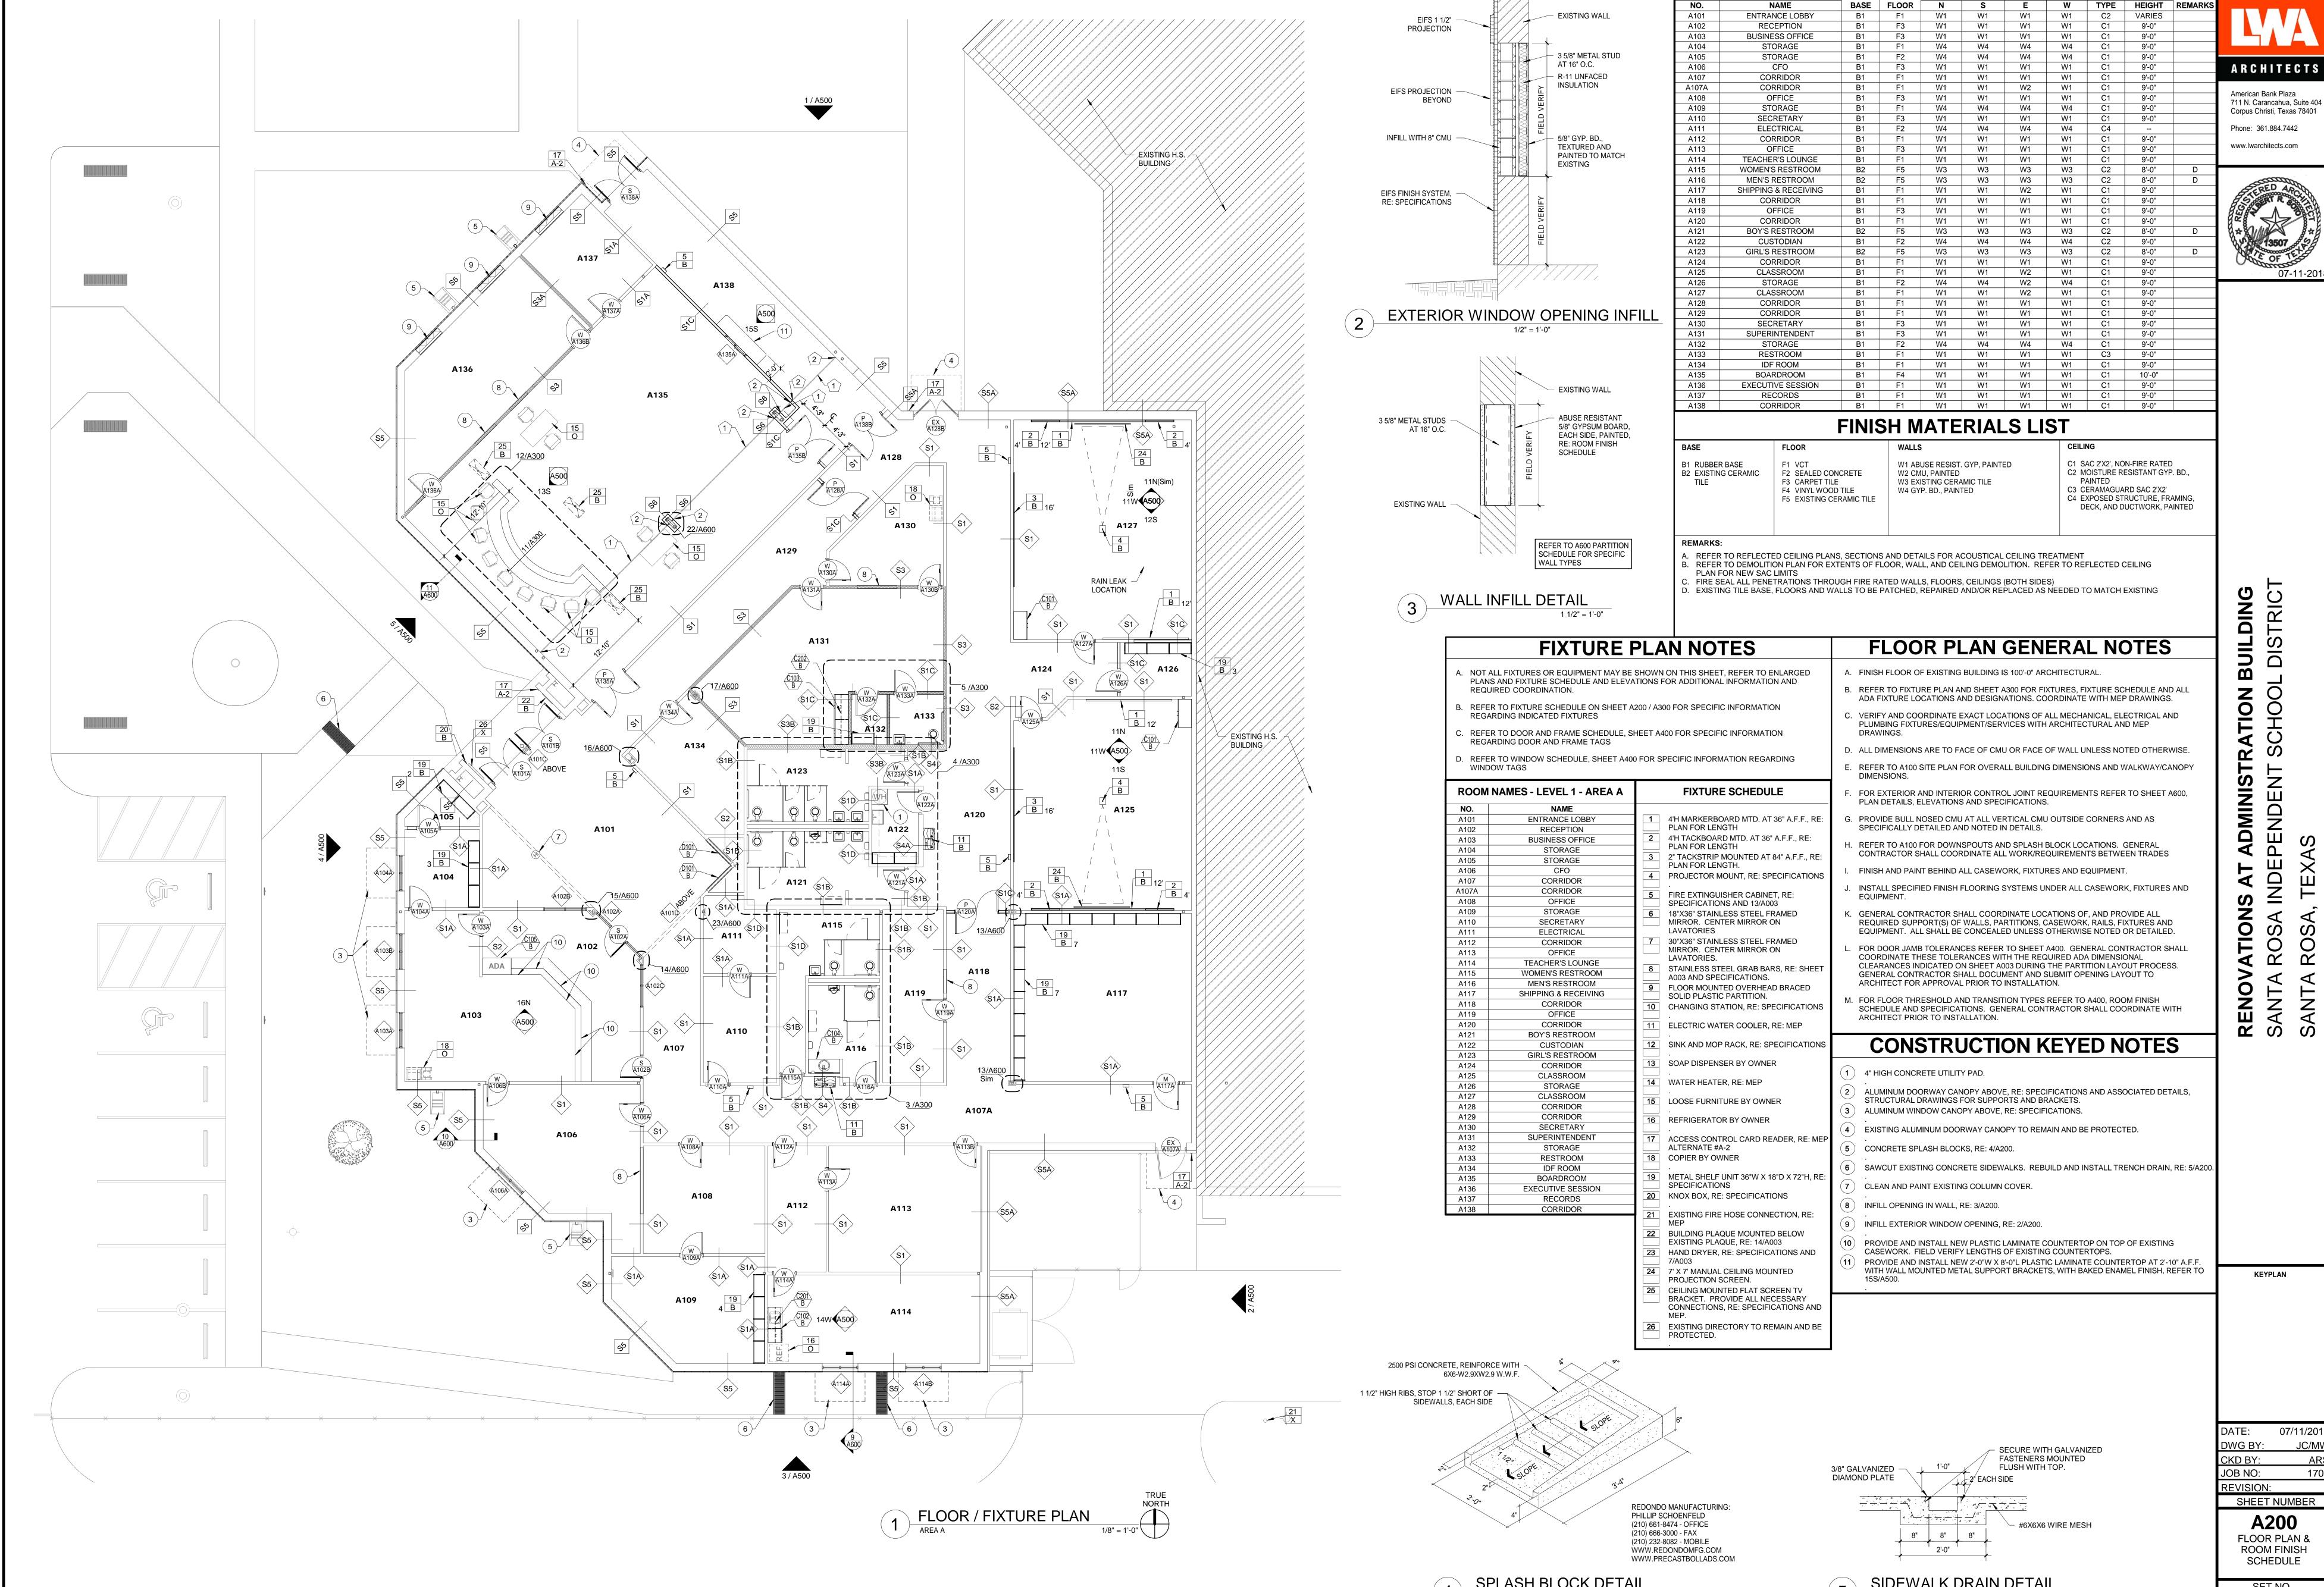SET NO.



GENERAL REFLECTED CEILING PLAN NOTES

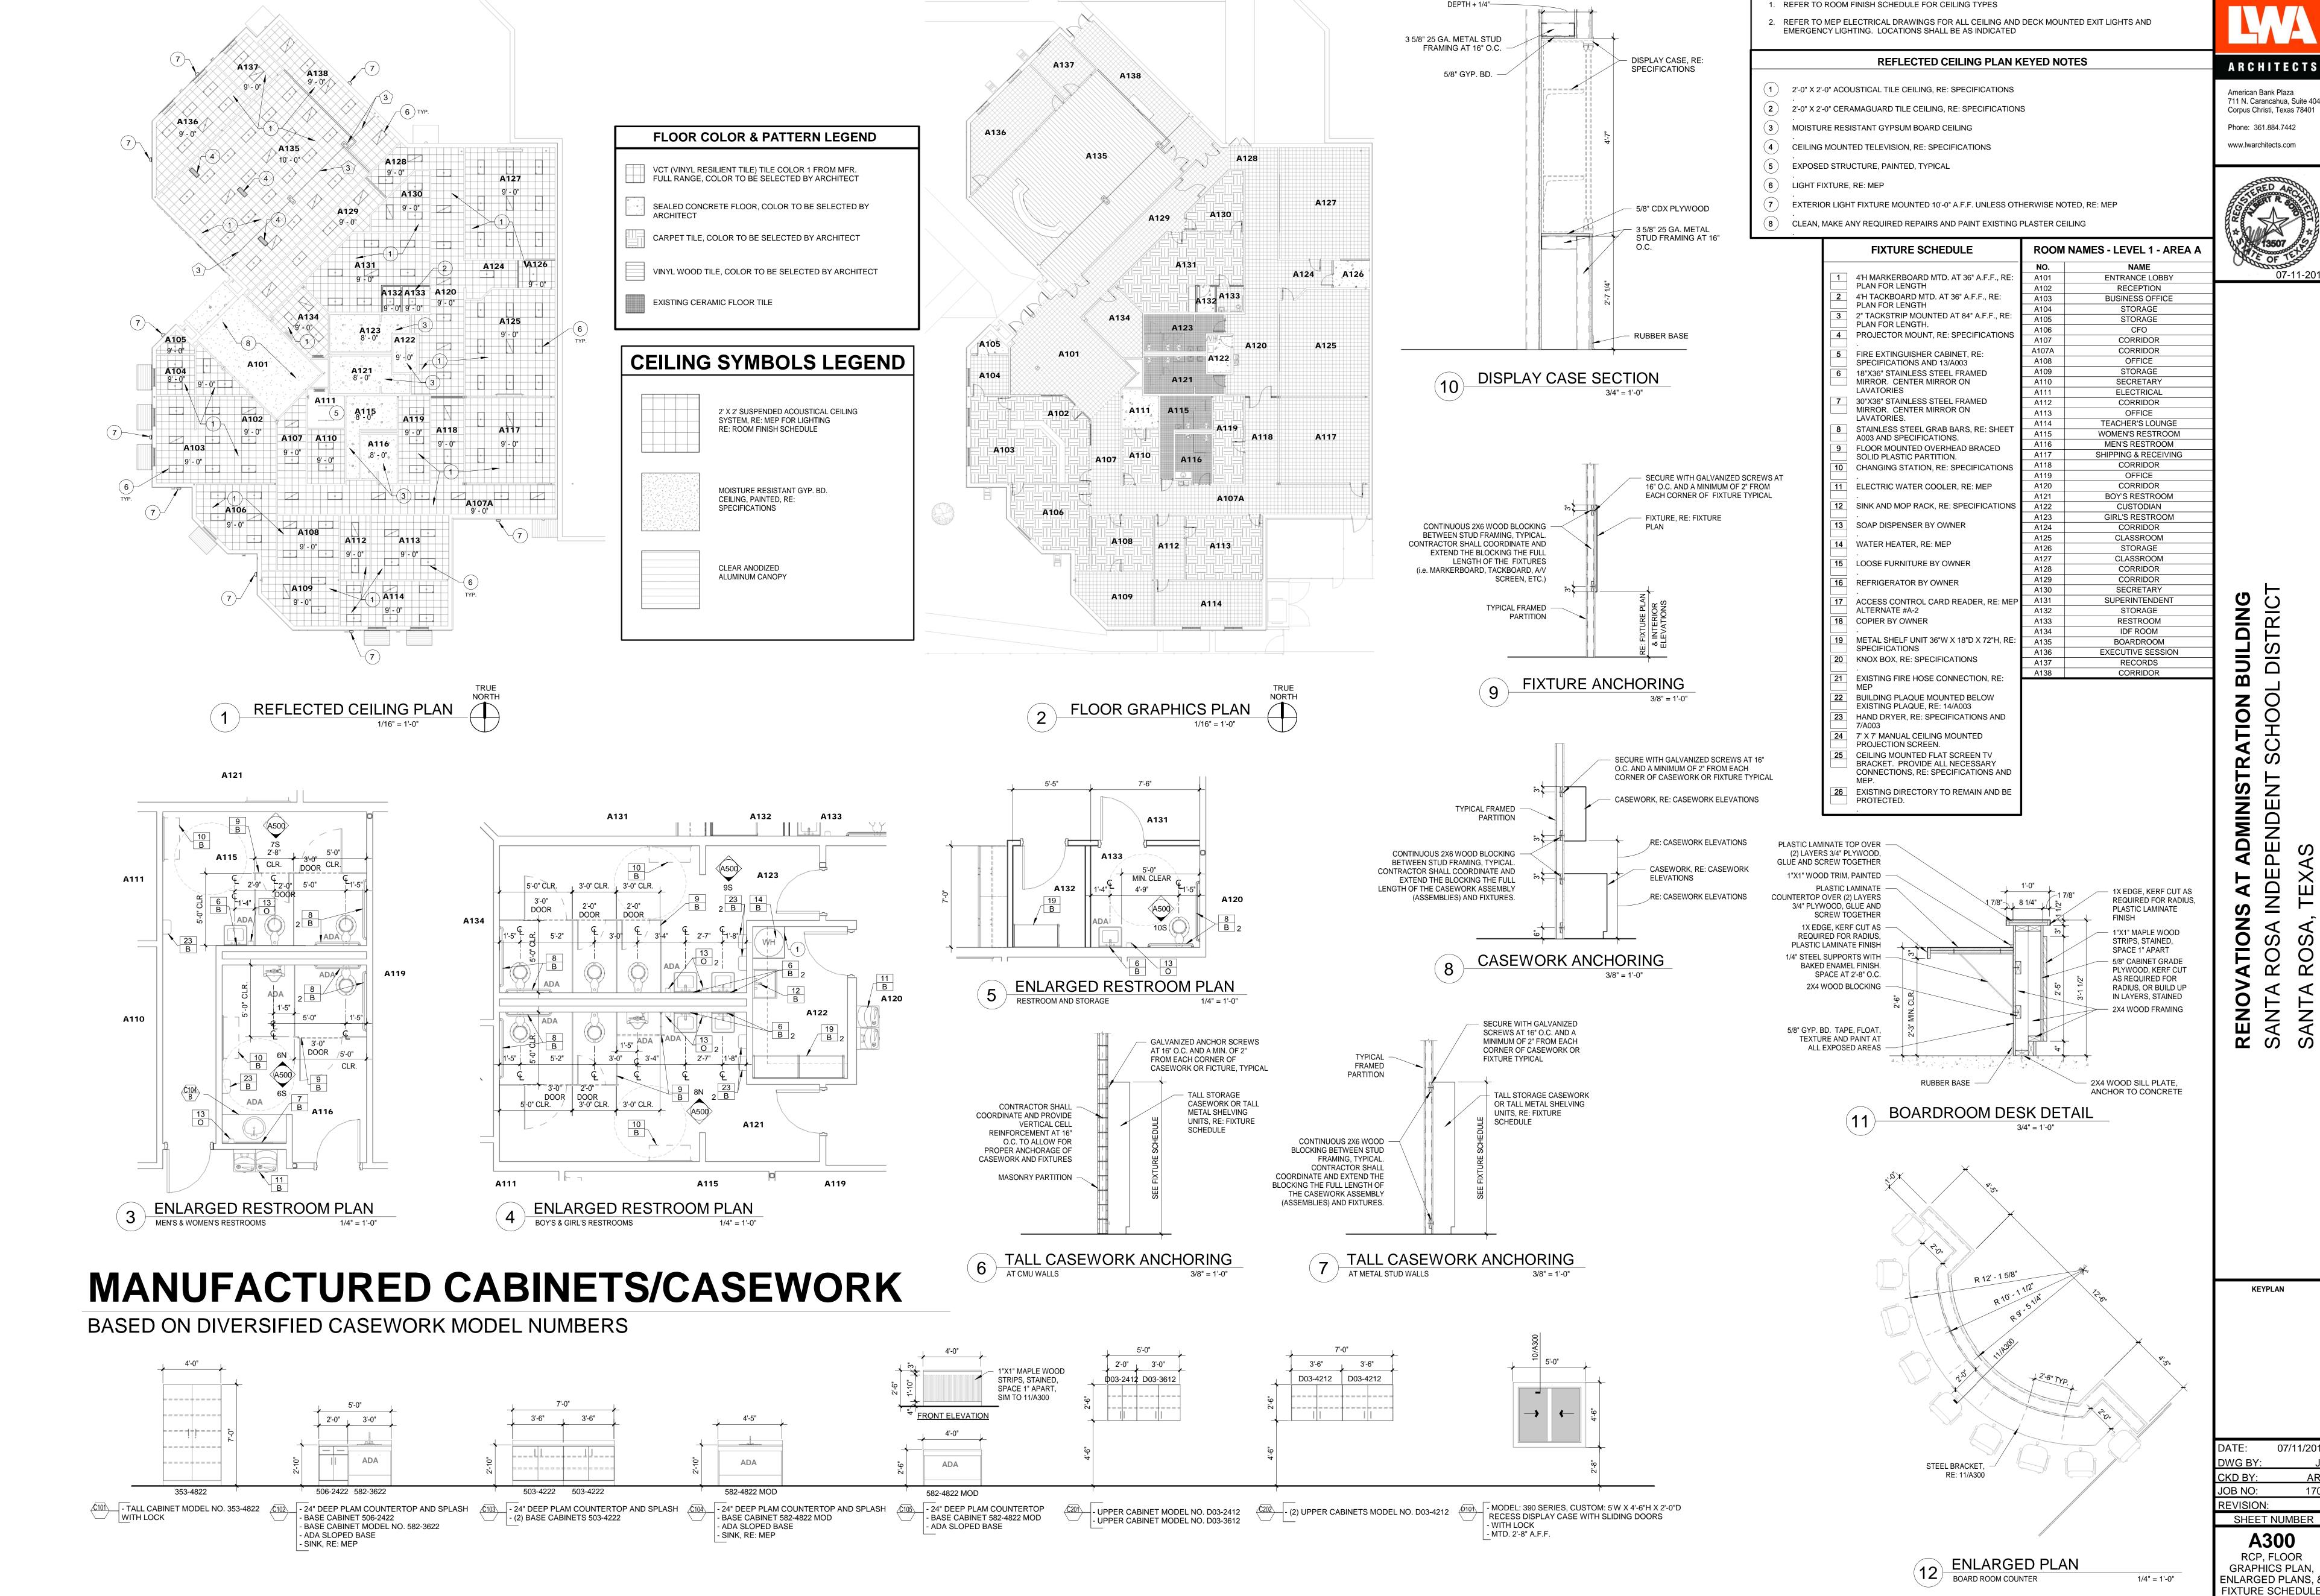711 N. Carancahua, Suite 404 Corpus Christi, Texas 78401



SHEET NUMBER

GRAPHICS PLAN, ENLARGED PLANS, 8 FIXTURE SCHEDULE SET NO.

1 1/2" = 1'-0"

DOOR AND FRAME SCHEDULE LEVEL 1, AREA A

ELEV. MATERIAL RATING RATING

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711 N. Carancahua, Suite 404 Corpus Christi, Texas 78401 Phone: 361.884.7442 www.lwarchitects.com



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AA,BB,EE

PAIR 6'-0" 7'-0" 0'-13/4" SF A A138B P Interior PAIR 6'-0" 7'-0" 0'-13/4" LNL B P.LAM. AA GALV. H.M. -- --

DOOR AND FRAME SCHEDULE NOTES **DOOR MARK PREFIX LEGEND:** M: METAL/STEEL P: PACKAGE S: STOREFRONT DOOR GLASS LEGEND

|SINGLE | 3' - 0" | 7' - 0" | 0' - 1 3/4" | FL

DOOR AND FRAME REMARKS:

- A. PROVIDE SMOKE SEALS AT HEAD, JAMBS AND BOTTOM 3. ACCESS CONTROLLED DOOR, RE: SPECIFICATIONS
- G. SAFETY / SECURITY WINDOW FILM, 8 MIL., FILM IS FROM BOTTOM FRAME SILL TO A HEIGHT OF HORIZONTAL MULLIONS AT 7'-0" H. CLEAN AND REPAINT EXISTING HOLLOW METAL FRAMES, BOTH SIDES I. INTERIOR FRAME TO BE DARK BRONZE ANODIZED FINISH
- E. FOR NEW DOOR AND FRAME SIZE, FIELD VERIFY TO FIT IN . GALVANIZED HOLLOW METAL FRAME BY DOOR MANUFACTURER
- J. EXTERIOR FRAME TO BE CLEAR ANODIZED FINISH
- ALL DOOR FRAMES AND GLASS IN FIRE RATED PARTITIONS AND BARRIER WALLS TO BE FIRE RATED
- FOR MAGNETIC DOOR LOCKS TIED INTO THE FIRE ALARM SYSTEM, VERIFY WITH LOCAL A.H.J. FOR COMPLIANCE DIMENSIONS FOR DOOR FRAMES ARE TO THE ROUGH IN OPENING, REFER TO DOOR ELEVATIONS FOR FRAME DIMENSIONS ALL GLASS IN EXTERIOR DOORS AND WINDOWS TO BE INSULATED
- 5. FOR DOORS WITH ACCESS CONTROL/AUTO-OPERATOR AND ELECTRONIC HARDWARE DEVICES, CONTRACTOR IS TO SCHEDULE A COORDINATION MEETING PER THE FINISH HARDWARE SPECIFICATIONS 6. ALL WINDSTORM OPENINGS SHALL BE SUPPLIED AS (CERTIFIED) TESTED/APPROVED PACKAGED SYSTEMS TO INCLUDE THE DOOR AND FRAME

MATERIAL | GLASS | FIRE RATING RATING REMARKS PLACEMENT **EXISTING** Exterior EXISTING Exterior BB,DD A102A A102B BB,DD BB.DD A102C ALUM. --A103A ALUM. AA,BB,EE

WINDOW SCHEDULE LEVEL 1

AA,BB,EE AA,BB,E AA,BB,EE AA,BB,EE

WINDOW SCHEDULE NOTES

WINDOW FRAMES 1. REFER TO DOOR AND WINDOW ELEVATIONS SHEET FOR FRAME DIMENSIONS 2. DIMENSIONS ARE TO ROUGH OPENING, REFER TO DOOR AND WINDOW ELEVATIONS SHEET FOR FRAME DIMENSIONS

WINDOW GLASS LEGEND

FOLD END UP AND FULLY WELD

AT EACH END, TYPICAL

FULLY WELDED .050 ANODIZED

WINDOW FINISH

ALUMINUM SUB-SILL DETAIL

ALUMINUM SUB-SILL COLOR TO MATCH

HEMMED LIP, REFER TO SPECIFIC DETAILS

FULLY HELI-ARCHED JOINT

A. 1" INSULATED FULLY TEMPERED GLASS. B. 1/4" FULLY TEMPERED GLASS, CLEAR TINT AS SPECIFIED C. EXISTING GLASS NOTES:

A103B

A104A

A106A A114A

A114B

ALL WINDOW FRAMES AND GLASS IN FIRE RATED PARTITIONS AND WALLS TO BE FIRE RATED 2. ALL GLASS IN EXTERIOR DOORS AND WINDOWS TO BE INSULATED **REMARKS:**

AA. SAFETY / SECURITY WINDOW FILM 8 MIL. BB. FOR NEW WINDOW AND FRAME SIZE, FIELD VERIFY TO FIT IN EXISTING OPENING CC. CLEAN AND REPAINT EXISTING HOLLOW METAL FRAMES, BOTH SIDES DD. INTERIOR FRAME TO BE DARK BRONZE ANODIZED FINISH

EE. EXTERIOR FRAME TO BE CLEAR ANODIZED FINISH

07/11/201 JOB NO:

REVISION: SHEET NUMBER **A400 DOOR & WINDOW** SCHEDULES / **ELEVATIONS &** DETAILS

SET NO.

KEYPLAN

EXTERIOR ELEVATIONS KEYED NOTES

- REPAIR BROKEN/MISSING STUCCO FULL THICKNESS WITH PORTLAND CEMENT PLASTER PRIOR TO NEW EIFS.
- (2) CLEAR ANODIZED ALUMINUM WINDOW CANOPY, RE: SPECIFICATIONS AND 18/A600 FOR MOUNTING BRACKET
- (3) EXISTING STUCCO FINISH TO REMAIN AND BE PROTECTED.
- FIELD COLOR EIFS SYSTEM, COLOR TO BE SELECTED BY ARCHITECT. REPAIR ALL LOCATIONS OF BROKEN/MISSING STUCCO FULL THICKNESS WITH PORTLAND CEMENT PLASTER PRIOR TO NEW EIFS. FIELD
- 1 1/2" THICK EIFS DECORATIVE BAND AND PROJECTION, COLOR TO BE SELECTED BY ARCHITECT, STOP BAND A DOWNSPOUTS TO ALLOW STRAIGHT RUN OF DOWNSPOUT
- (6) EXISTING HIGH SCHOOL BUILDING TO REMAIN AND BE PROTECTED.
- 7 CLEAR ANODIZED ALUMINUM STOREFRONT WINDOWS AS SCHEDULED AND SPECIFIED.
- (8) EXISTING BUILDING PLAQUE TO REMAIN AND BE PROTECTED. INSTALL MISSING ANCHORS.
- (9) EXISTING CANOPY TO REMAIN AND BE PROTECTED.
- (10) REFER TO LIGHTING PLAN FOR LIGHT FIXTURE.
- (11) EXISTING BRICK FACADE TO REMAIN AND BE PROTECTED.
- (12) NEW CLEAR ANODIZED ALUMINUM STOREFRONT DOOR AS SCHEDULED AND SPECIFIED.
- (13) EXISTING MECHANICAL EQUIPMENT TO REMAIN AND BE PROTECTED.
- (14) 12" HIGH EXTERIOR LETTERS PER SIGNAGE ALLOWANCE.
- (15) NEW BUILDING PLAQUE, RE: 14 AND 15/A003 AND SPECIFICATIONS.
- (16) EXISTING DOWNSPOUT TO REMAIN AND BE PROTECTED. PATCH AND/OR REPAIR AS NEEDED. REPAINT.
- (17) NEW DOWNSPOUT, PREFINISHED GALVANIZED AS SPECIFIED. TO MATCH EXISTING DOWNSPOUTS WITH COLLECTOR HEAD. PATCH AND REPAIR WALL AROUND SCUPPER WITH SIMILAR CONSTRUCTION. REPAIR /
- REPLACE SCUPPER AS NEEDED. (18) REINSTALL DETACHED EXISTING DOWNSPOUT TO ORIGINAL LOCATION. PATCH AND REPAIR WALL AROUND
- SCUPPER WITH SIMILAR CONSTRUCTION. REPAIR OR REPLACE SCUPPER AS NEEDED. (19) EXTEND DOWNSPOUTS TO BELOW EXISTING WALK FOR TRENCH DRAINS.
- (20) NEW SPLASH BLOCKS, RE: 4/A200.
- (21) ACCESS CONTROL CARD READER, RE: MEP.
- (22) 2'-0" X 2'-0" EIFS ACCENT PANEL, RE: 12/A600.
- (23) EXTERIOR LIGHT FIXTURE MOUNTED 10'-0" A.F.F. UNLESS OTHERWISE NOTED, RE: MEP
- (24) 3/4" CONTROL JOINT CENTERED OVER EXISTING STUCCO CONTROL JOINT, RE: 4/A600
- (25) EXISTING DOOR TO REMAIN AND BE PROTECTED
- PROPER FIT TO COLLECTOR HEAD (27) EXISTING ARCHED WINDOW FROM EXISTING HORIZONTAL TRANSOM TO REMAIN AND BE PROTECTED.

(26) FIELD VERIFY CONDITION OF SCUPPER FLASHING, EXTEND AS REQUIRED TO ACCOMODATE EIFS THICKNESS AND

- (28) EXISTING TRANSOM TO REMAIN AND BE PROTECTED.
- (29) EXISTING HORIZONTAL WINDOW TO REMAIN AND BE PROTECTED.

INTERIOR ELEVATION GENERAL NOTES

- A. NOT ALL KEYED NOTES LISTED BELOW ARE USED ON THIS SHEET.
- B. REFER TO SHEET A300 FOR FIXTURE SCHEDULE, FIXTURE ELEVATIONS AND ASSOCIATED DETAILS

- E. ELECTRICAL AND COMMUNICATION OUTLETS NOT SHOWN. RE: MEP FOR LOCATION, COORDINATE WITH ARCHITECTURAL PLANS

INTERIOR ELEVATION KEYED NOTES

- 1 CEILING SYSTEM, REFER TO ROOM FINISH SCHEDULE AND REFLECTED CEILING PLAN
- 2 BASE, REFER TO ROOM FINISH SCHEDULE AND SPECIFICATIONS
- 3 WRAP RUBBER BASE WITHIN AND AROUND FINISHED CASEWORK OR WALLS, TYPICAL
- EXISTING WALL TILE, REFER TO PLAN AND ROOM FINISH SCHEDULE. REPAIR AS NECESSARY
- 5 FLOOR FINISH, REFER TO PLAN AND ROOM FINISH SCHEDULE
- 6 DOOR AS SCHEDULED
- (7) WALL FINISH PAINTED, REFER TO PLAN AND ROOM FINISH SCHEDULE
- 8 CONTROL JOINT, RE: 3 AND 5/A600
- 9 EXPANSION JOINT COVER, RE: A600
- PROVIDE AND INSTALL NEW 2'-0"W X 8'-0"L PLASTIC LAMINATE COUNTERTOP AT 2'-10" A.F.F. WITH WALL MOUNTE METAL SUPPORT BRACKETS (BAKED ENAMEL FINISH), SPACE BRACKETS AS INDICATED FOR PROPER ADA
- 11 BOARDROOM DESK WITH 1X1 STAINED WOOD STRIPS ON PLYWOOD FACE, RE: 11/A300

ARCHITECTS

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ILDING BU **ADMINISTRATION** PENDENT

RENOVATIONS

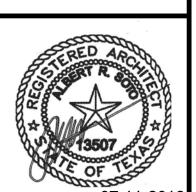
KEYPLAN

SHEET NUMBER **A500**

EXTERIOR & INTERIOR **ELEVATIONS**

SET NO.

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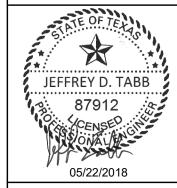
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KEYPLAN

REVISION: SHEET NUMBER

A600 WALL SECTIONS, PARTITION SCHEDULE, DETAILS & EXP. JOINTS

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WHICH MUST BE REROUTED, RELOCATED, OR REMOVED EITHER TEMPORARILY OR

.DING

MEP ROOF DEMO KEYED NOTES

HARDCOPY AND MUST BE FIELD VERIFIED.

WEEK NOTICE PRIOR TO DEMOLITION.

MECHANICAL GENERAL DEMO NOTES

1. COORDINATE DEMOLITION WORK WITH ELECTRICAL AND OTHER DISCIPLINES AS

2. IT IS THE CONTRACTOR'S RESPONSIBILITY TO HAVE VERIFIED EXISTING JOBSITE

PERMANENTLY, OR WHICH MUST BE PROVIDED TO ACCOMMODATE THE INDICATED REMODELING. NOT ALL EXISTING CONDITIONS ARE NECESSARILY INDICATED ON THE DRAWINGS. ALL HVAC SHOWN ARE TAKEN FROM AS-BUILT

CONDITIONS DURING THE BIDDING PERIOD, SO THEY WILL HAVE DISCOVERED THE FULL SCOPE OF WORK INVOLVED WITH THE MODIFICATION OF THIS EXISTING SPACE. THE SCOPE OF THE WORK SHALL INCLUDE ALL MATERIALS FOR A COMPLETE INSTALLATION INCLUDING DEVICES, EQUIPMENT, OR APPARATUS

WHEN AN EQUIPMENT IS IDENTIFIED TO BE REMOVED, THE OWNER HAS FIRST RIGHT OF REFUSAL BEFORE DISPOSING OF THAT EQUIPMENT. PROVIDE DISTRICT ONE

PROVIDE ALL NECESSARY CLEAR PATH TO MOVE DEMOLISHED EQUIPMENT OUT OF THE FACILITY AS WELL TO BRING NEW EQUIPMENT INTO THE BUILDING. MODIFY

EXISTING PIPING, DUCTWORK CONDUITS, AS REQUIRED TO COMPLETE THE

- EXISTING ROOF EXHAUST FAN AND ASSOCIATED DUCTWORK SHALL BE REMOVED. CONTRACTOR TO FIELD VERIFY EXACT LOCATION. TEMPORARILY CAP AND SEAL ROOF OPENING. REFER TO M201 FOR NEW WORK.
- 2 EXISTING ROOF TOP UNIT SHALL REMAIN.
- 3 DEMOLISH EXISTING ROOF TOP UNIT.
- 4 DEMOLISH CONDENSING UNIT.

DEMOLITION

5 CONTRACTOR TO DEMOLISH ALL EXISTING GAS LINE UP TO ROOF PENETRATION. REFER TO MEP201 FOR NEW GAS PIPE ROUTING.

2 RTU-X (E) EF(E) 1

ROOF LEVEL MEP DEMO PLAN


1/8" = 1'-0"

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JT MG JB TL --

DWG BY: CKD BY: JOB NO: REVISION: SHEET NUMBER **MEP101** ROOF LEVEL MEP DEMO PLAN

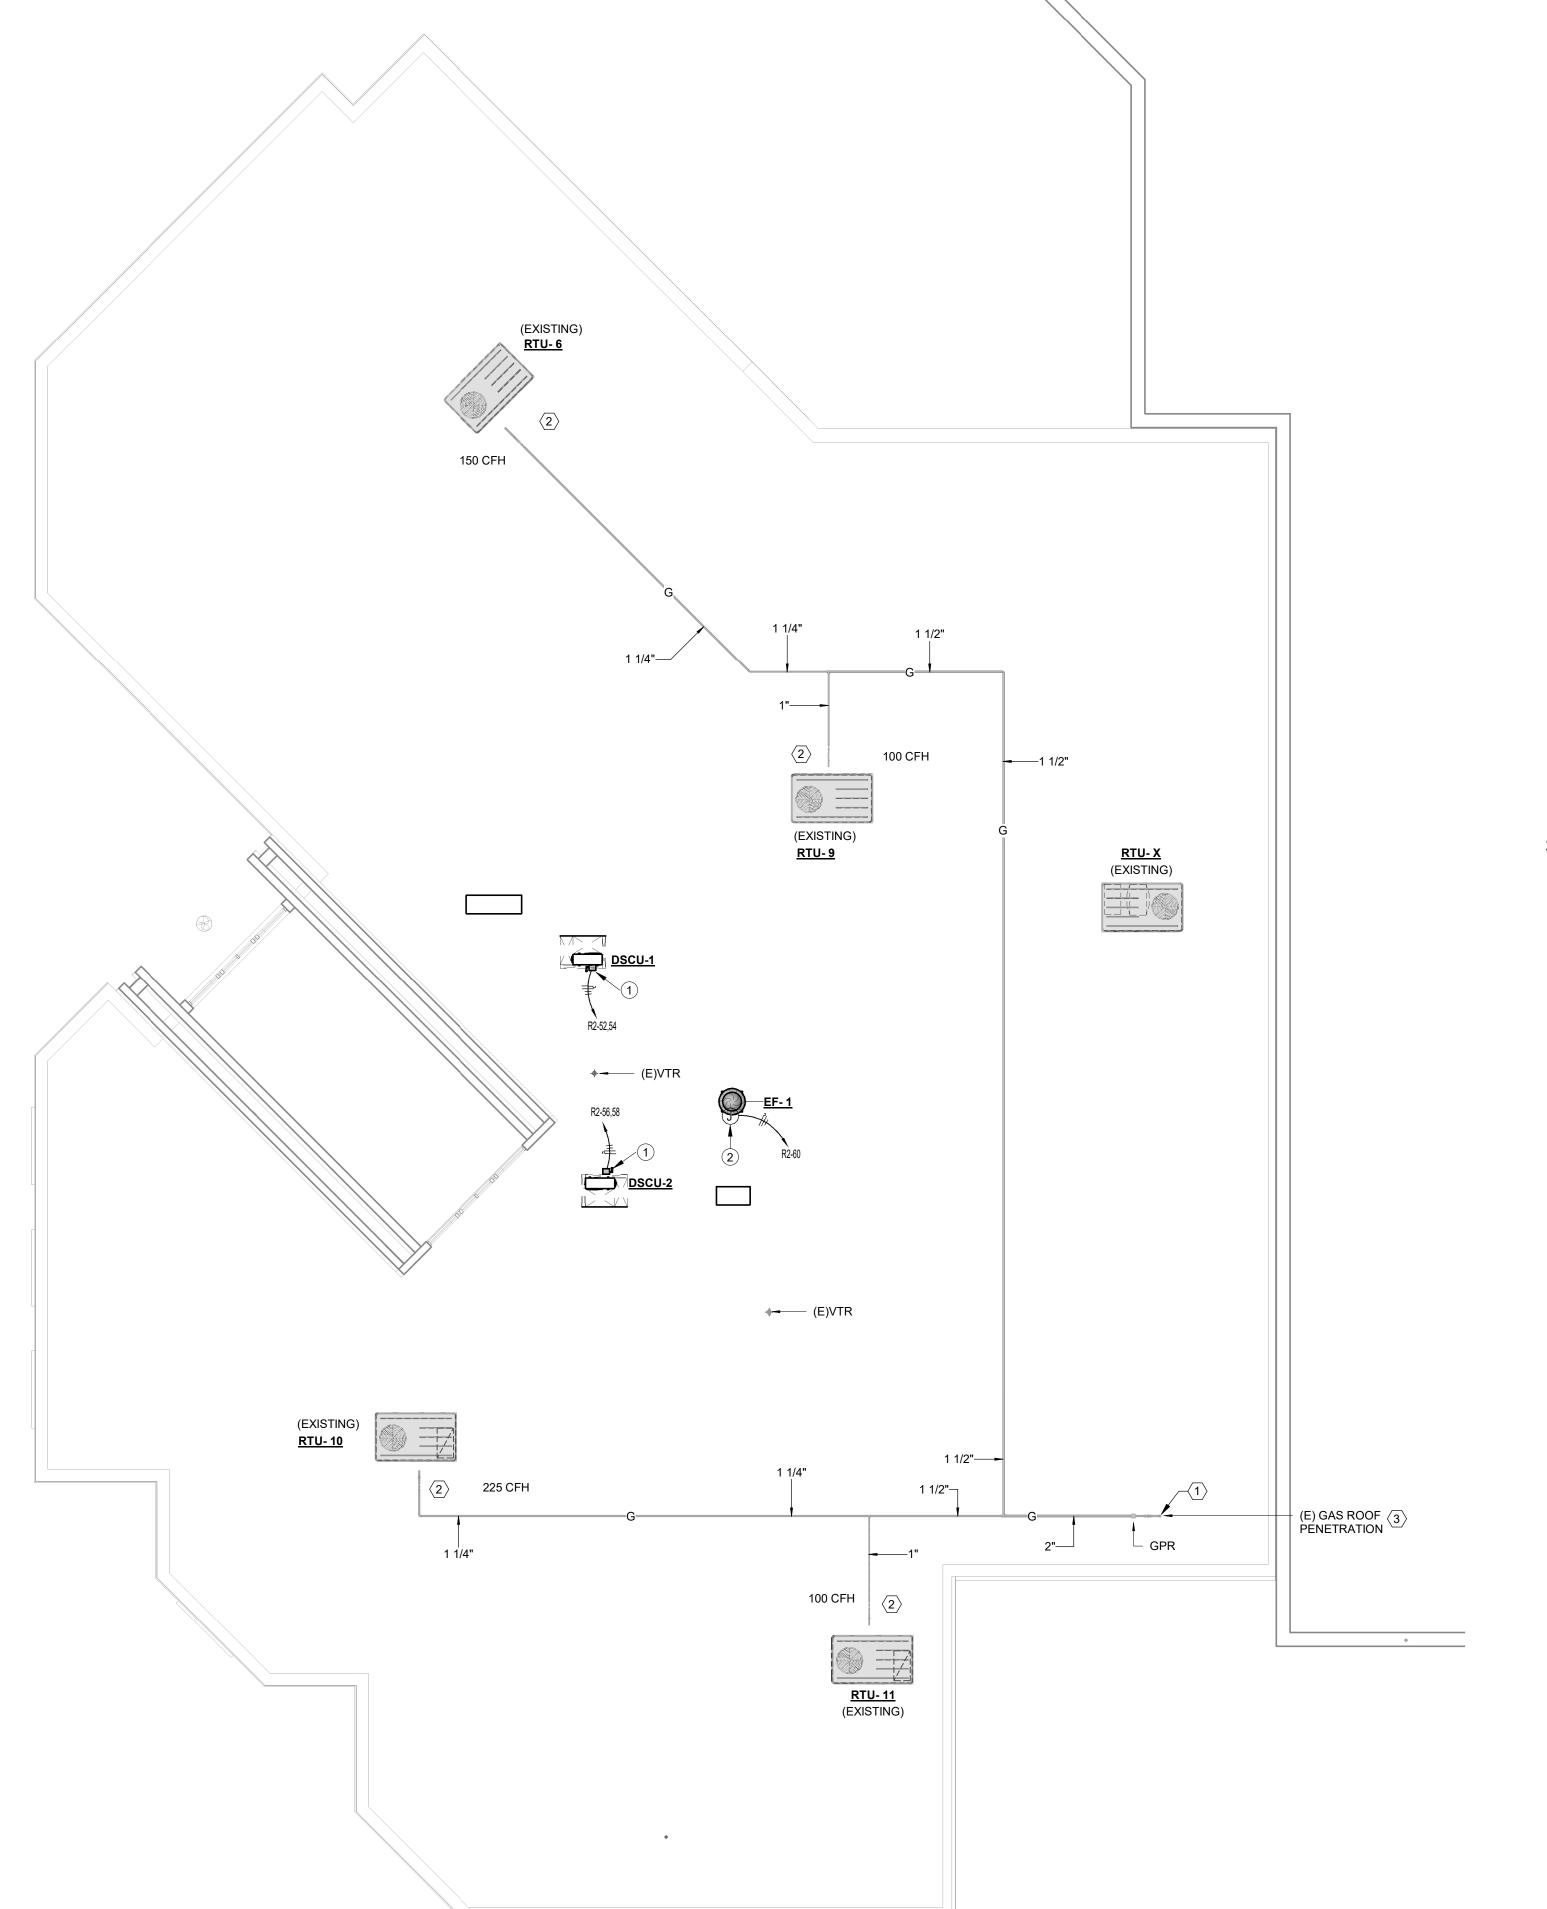SET NO.



ELECTRICAL KEYNOTE LEGEND

208V, 30A/2P, NEMA 3R DISCONNECT SWITCH FUSED PER NAMEPLATE DATA OF FURNISHED EQUIPMENT. COORDINATE EXACT LOCATION AND REQUIREMENTS WITH MECHANICAL. PROVIDE CODE REQUIRED MOUNTING AND CLEARANCE.

PROVIDE 120V CONNECTION TO EXHAUST FAN. DISCONNECT SHALL BE PROVIDED WITH EQUIPMENT. EXHAUST FAN SHALL BE CONTROLLED WITH THE LIGHTS IN THE RESPECTIVE ROOM PROVIDE RELAY AND ALL CONDUIT AND WIRING AS REQUIRED. COORDINATE EXACT REQUIREMENTS WITH MECHANICAL.

GENERAL NOTES:

- SIZES AND LOCATION OF EXISTING PIPINGS SHOWN WERE TAKEN FROM ENGINEERING PLANS FROM WHICH EXISTING SYSTEMS WERE INSTALLED. CONTRACTOR NEED TO FIELD VERIFY EXACT SIZES, CONDITIONS AND LOCATIONS OF INDICATED EXISTING UTILITIES.
- (B) ALL FIXTURES, EQUIPMENT AND PLUMBING LINES SHOWN WITH (E) ARE EXISTING TO REMAIN. UNLESS NOTED OTHERWISE.
- THE CONTRACTOR IS FULLY RESPONSIBLE FOR PERFORMING ALL WORK UNDER THIS SECTION OF THE PROJECT IN FULL COMPLIANCE WITH ALL APPLICABLE LOCAL, STATE AND FEDERAL CODES INCLUDING THOSE PUBLISHED BY OSHA AND EPA.

PLUMBING KEYED NOTES:

- PROVIDE PRESSURE REGULATOR SET AT 4 TO 8 OZ PRESSURE. TOTAL LOAD OF 575 CFH AND DEVELOPED LENGTH OF 160 FEET.
- (2) COORDINATE ROUTING AND CONNECTIONS WITH MECHANICAL CONTRACTOR. RE: 9/P401.
- (3) EXISTING GAS LINE FROM GAS METER, FIELD VERIFY EXACT LOCATION.

KEYPLAN

ARCHITECTS

American Bank Plaza 711 N. Carancahua, Suite 404 Corpus Christi, Texas 78401

Phone: 361.884.7442 Fax: 361.883.1612

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JEFFREY D. TABB

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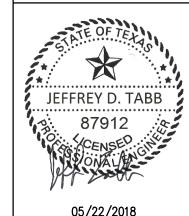
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CKD BY:
JOB NO:
REVISION:
SHEET NUMBER

MEP201 ROOF LEVEL MEP PLAN

SET NO. JT MG JB TL --

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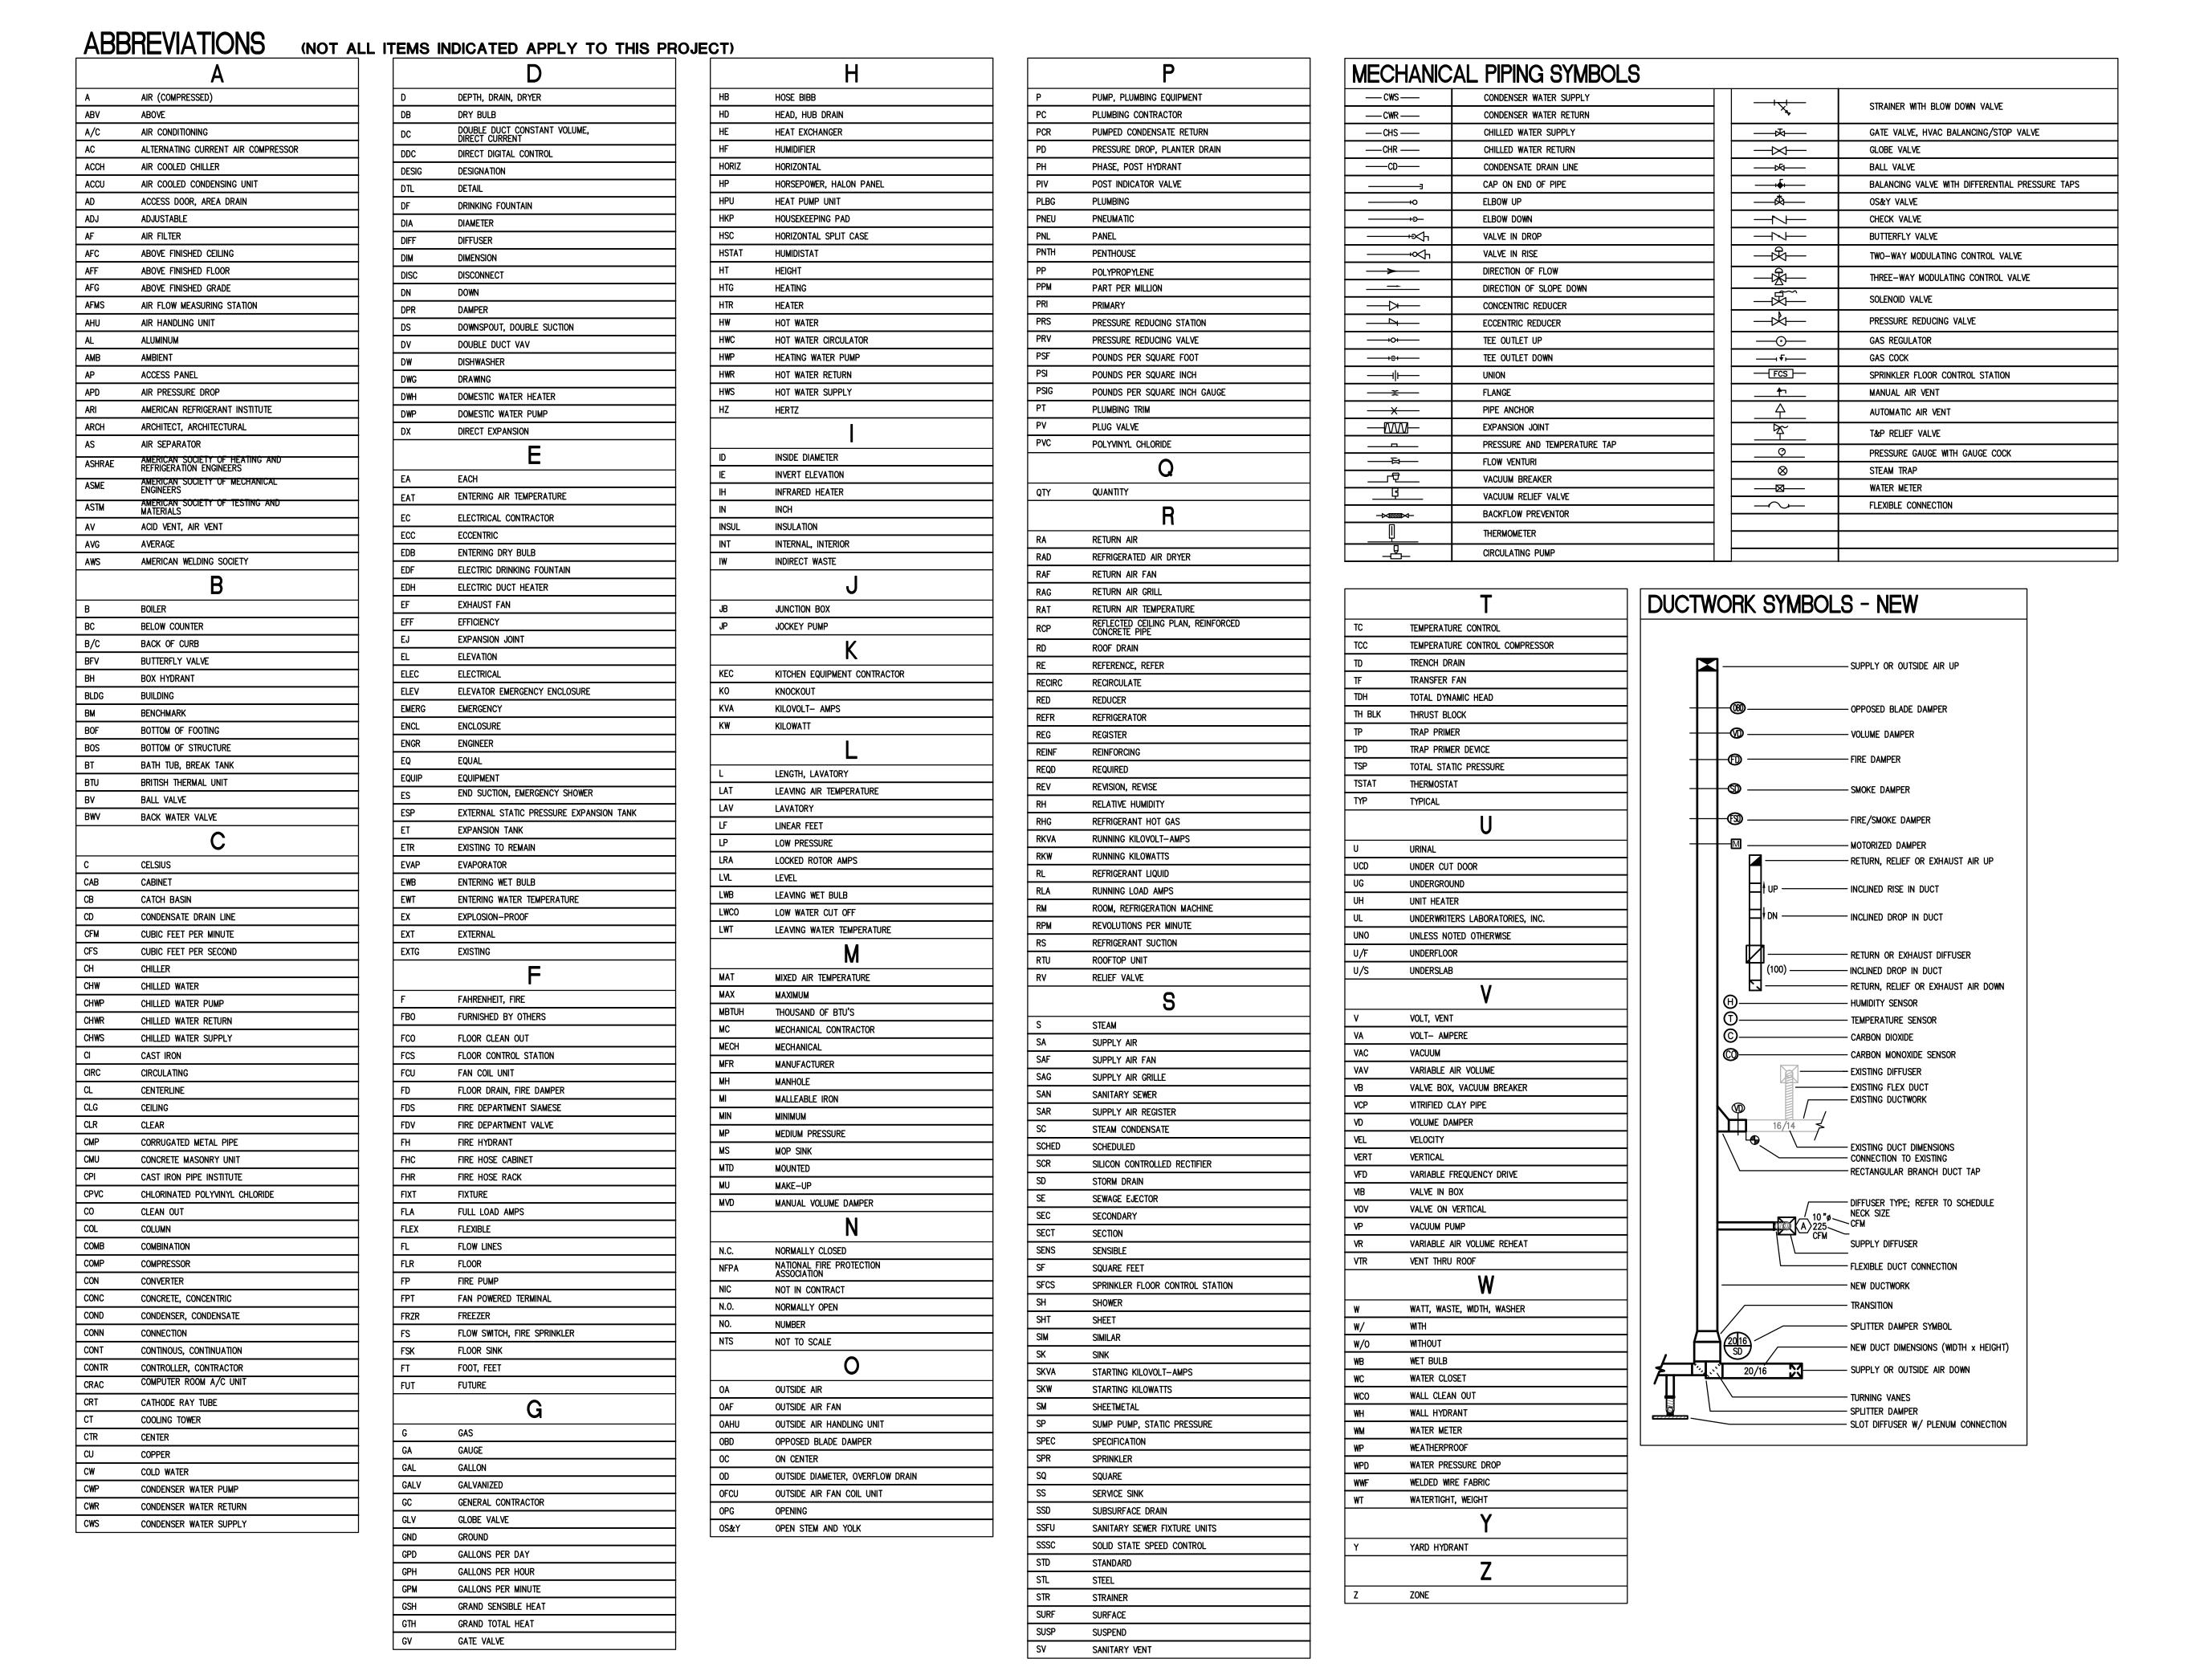



05/22/2018

JOB NO: **REVISION:** SHEET NUMBER MECHANICAL SYMBOLS AND

SET NO.

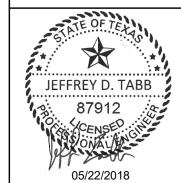400 Mann Street Suite. 602 Corpus Christi, Texas 78401 361.888.5797 p 361.888.9568 f TBPE Firm Registration No. 2234 ABBREVIATIONS DBR Project Number JT MG JB TL --





MECHANICAL GENERAL DEMO NOTES

- COORDINATE DEMOLITION WORK WITH ELECTRICAL AND OTHER DISCIPLINES AS REQUIRED.
- 2. IT IS THE CONTRACTOR'S RESPONSIBILITY TO HAVE VERIFIED EXISTING JOBSITE CONDITIONS DURING THE BIDDING PERIOD, SO THEY WILL HAVE DISCOVERED THE FULL SCOPE OF WORK INVOLVED WITH THE MODIFICATION OF THIS EXISTING SPACE. THE SCOPE OF THE WORK SHALL INCLUDE ALL MATERIALS FOR A COMPLETE INSTALLATION INCLUDING DEVICES, EQUIPMENT, OR APPARATUS WHICH MUST BE REROUTED, RELOCATED, OR REMOVED EITHER TEMPORARILY OR PERMANENTLY, OR WHICH MUST BE PROVIDED TO ACCOMMODATE THE INDICATED REMODELING. NOT ALL EXISTING CONDITIONS ARE NECESSARILY INDICATED ON THE DRAWINGS. ALL HVAC SHOWN ARE TAKEN FROM AS-BUILT HARDCOPY AND MUST BE FIELD VERIFIED.
- WHEN AN EQUIPMENT IS IDENTIFIED TO BE REMOVED, THE OWNER HAS FIRST RIGHT OF REFUSAL BEFORE DISPOSING OF THAT EQUIPMENT. PROVIDE DISTRICT ONE WEEK NOTICE PRIOR TO DEMOLITION.
- PROVIDE ALL NECESSARY CLEAR PATH TO MOVE DEMOLISHED EQUIPMENT OUT OF THE FACILITY AS WELL TO BRING NEW EQUIPMENT INTO THE BUILDING. MODIFY EXISTING PIPING, DUCTWORK CONDUITS, AS REQUIRED TO COMPLETE THE DEMOLITION

MECHANICAL DEMO KEYED NOTES

- 1 EXISTING SUPPLY DUCT, RETURN DUCT, AND AIR DEVICES IN THIS AREA SHALL REMAIN. REMOVE HVAC CONTROLS. CONTRACTOR IS RESPONSIBLE FOR SITE VISIT TO DETERMINE THE FULL SCOPE OF WORK. REFER TO M201 FOR NEW
- 2 DEMOLISH EXISTING DUCTLESS SPLIT, ASSOCIATED OUTDOOR CONDENSING UNIT ON ROOF, AND CONDENSATE PIPING.

NS AT ADMINISTRATION BAINDEPENDENT SCHOOL

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KEYPLAN

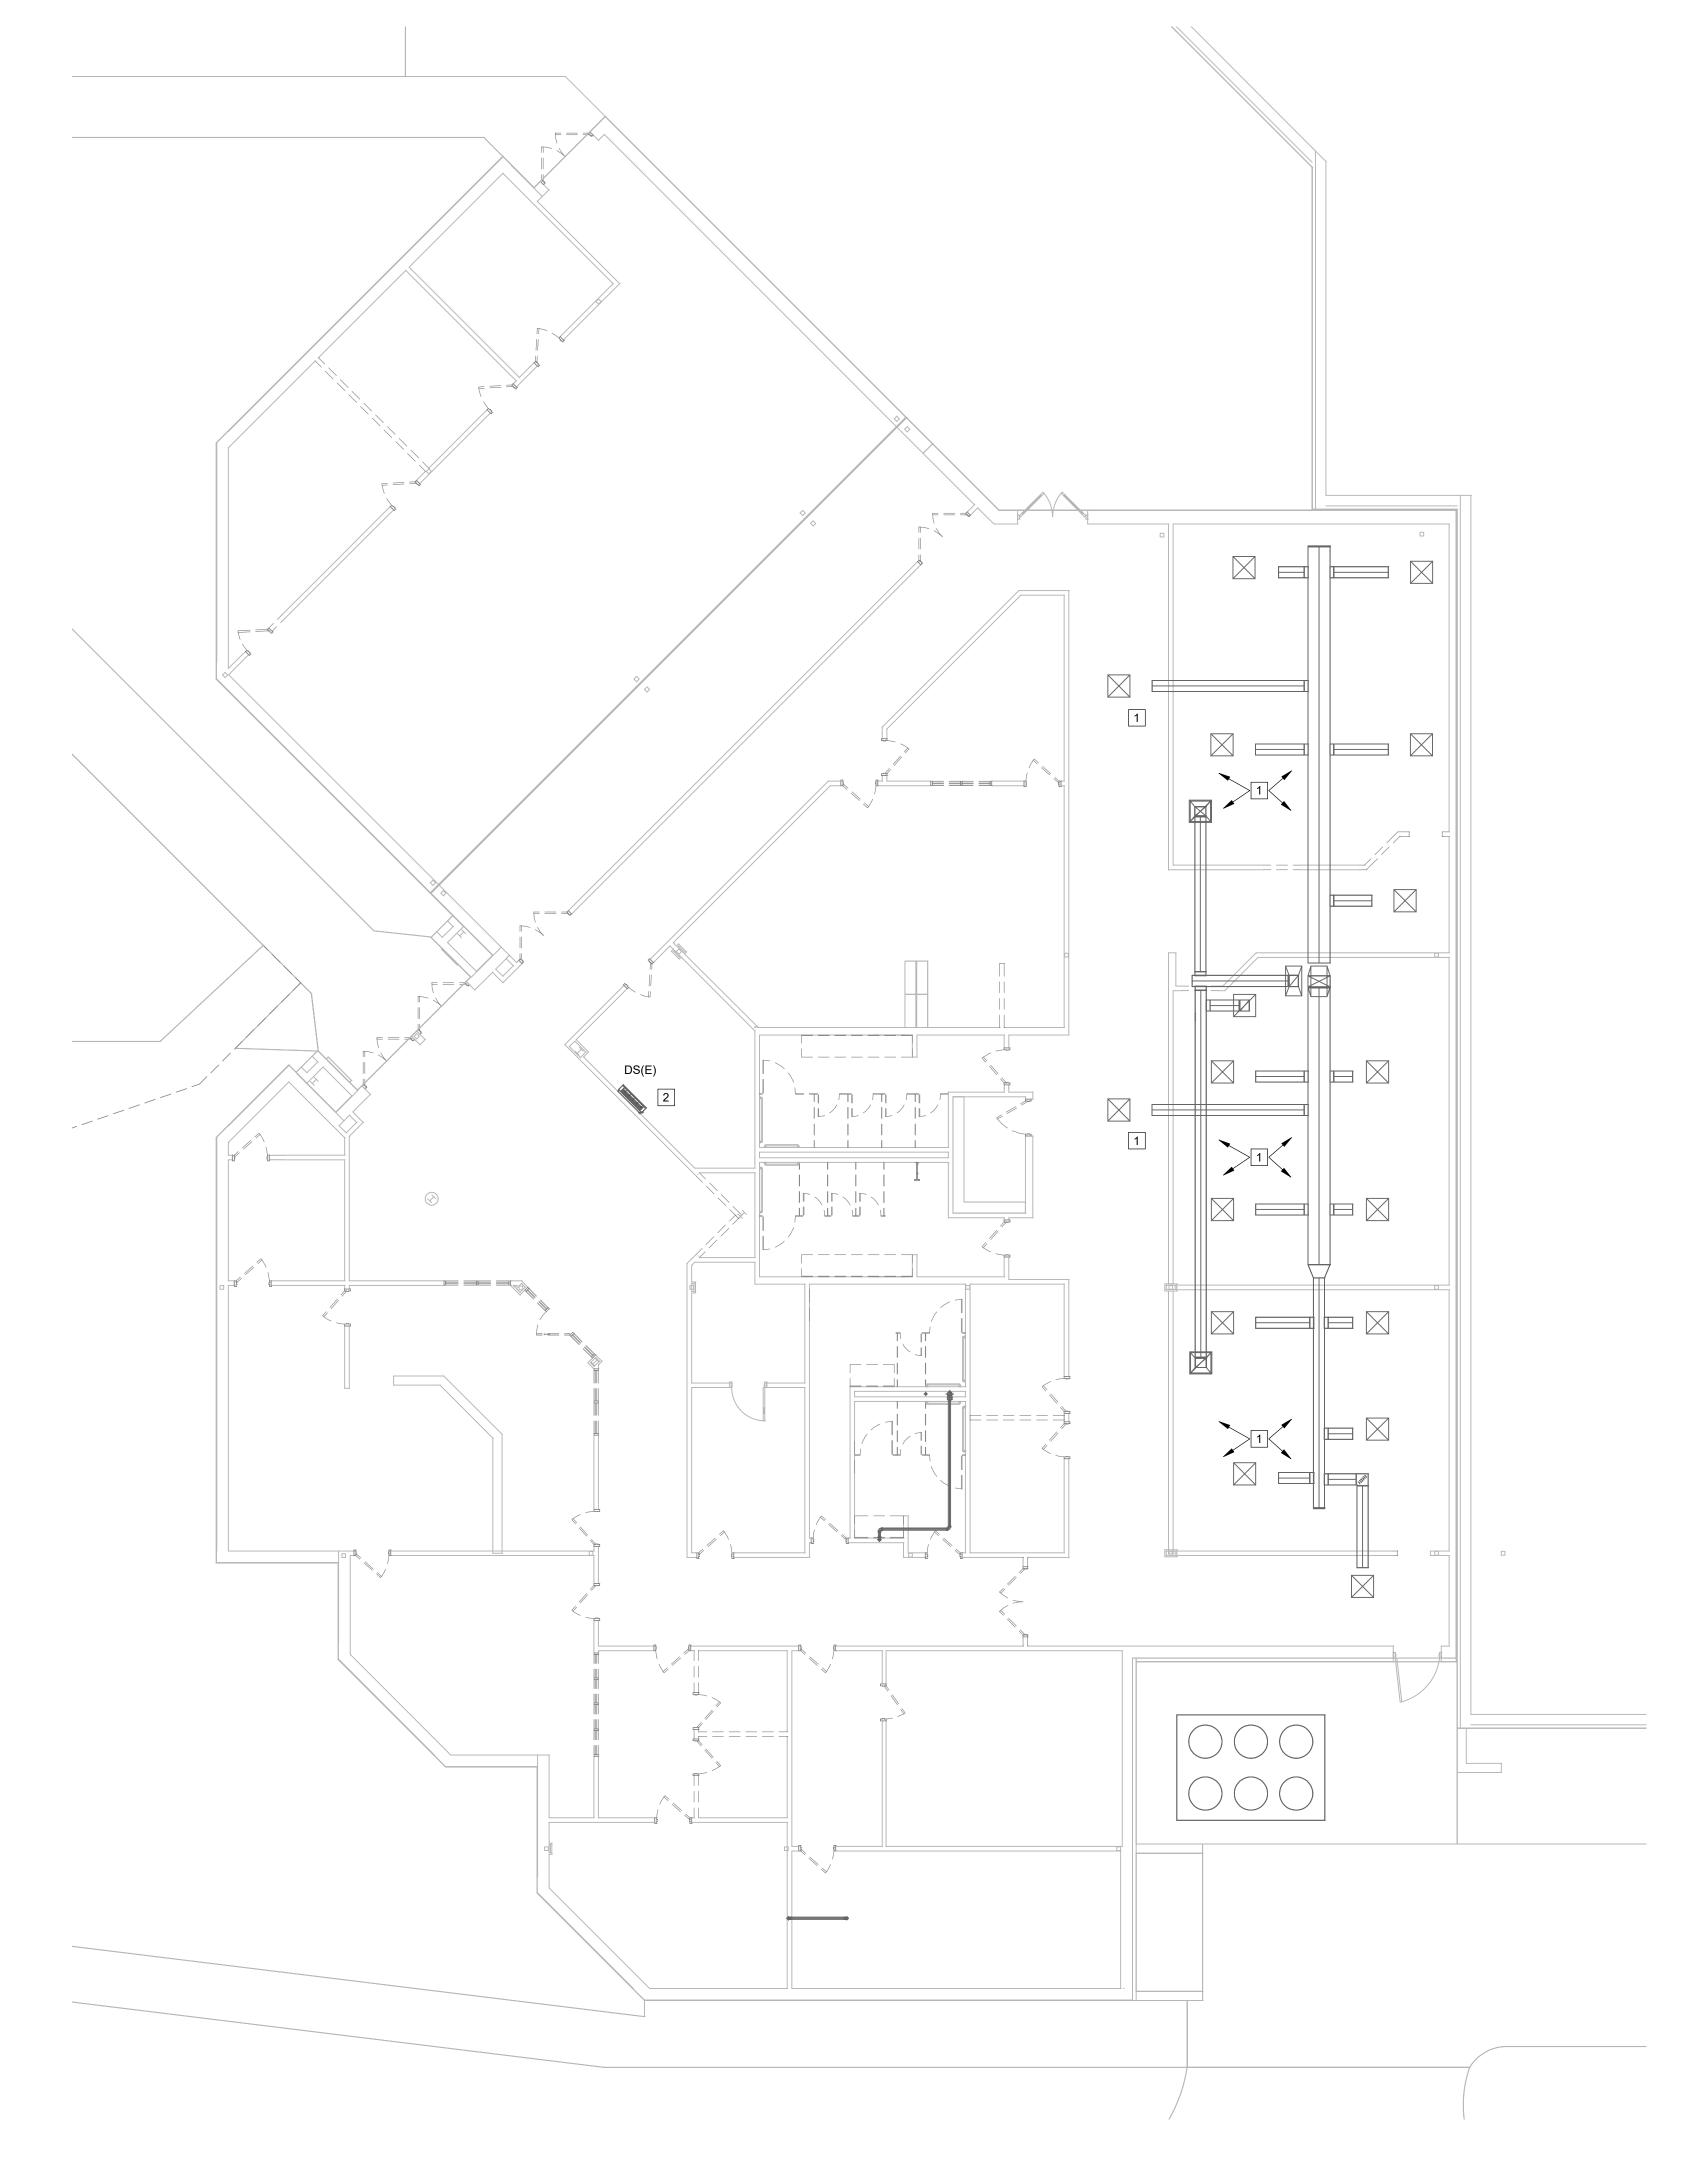
DWG BY: CKD BY: JOB NO: REVISION: SHEET NUMBER

M101 LEVEL 1 MECHANICAL DEMO

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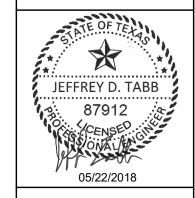
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American Bank Plaza
711 N. Carancahua, Suite 404
Corpus Christi, Texas 78401
Phone: 361.884.7442
Fax: 361.883.1612
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GENERAL MECHANICAL NOTES

- A. THE DRAWINGS ARE DIAGRAMMATIC AND INDICATE THE GENERAL LOCATION OF EQUIPMENT, DUCTS, AND GRILLES ETC. IT IS THE INTENT OF THESE DRAWINGS AND SPECIFICATIONS THAT COMPLETE MECHANICAL SYSTEMS BE FURNISHED, INSTALLED, TESTED AND READY FOR OPERATION WHETHER OR NOT EVERY ITEM OF EQUIPMENT, ACCESSORY, DEVICE, ETC. IS SHOWN. REFERENCE SHALL BE MADE TO THE FULL DRAWING PACKAGE INCLUDING ARCHITECTURAL, STRUCTURAL, ELECTRICAL, AND PLUMBING DRAWINGS FOR COORDINATION AND POTENTIAL CONFLICTS. THE MECHANICAL SUBCONTRACTOR SHALL, WITHOUT EXTRA CHARGE, MAKE REASONABLE MODIFICATIONS IN THE LAYOUT AS NEEDED TO PREVENT CONFLICTS WITH OTHER TRADES, OR FOR PROPER EXECUTION OF THE WORK. FIELD VERIFY ALL DIMENSIONS BEFORE FABRICATING DUCTWORK.
- B. DUCT DIMENSIONS INDICATED ON DRAWINGS ARE CLEAR INSIDE AIR STREAM DIMENSIONS.
- C. ALL NEW A/C EQUIPMENT SHALL BE CLEANED AFTER THE FINISHING OF DRYWALL AND PRIOR TO THE RELEASE OF BUILDING TO OWNER. MECHANICAL CONTRACTOR TO PROVIDE DOCUMENTATION WITH DATE AND TIME OF UNIT CLEANING.
- D. PROVIDE DUCT-MOUNTED SMOKE DETECTOR IN SUPPLY AND RETURN DUCT FOR AIR HANDLING UNITS SUPPLYING 2000 CFM AND GREATER.

MECHANICAL KEYED NOTES

- PROVIDE 7-DAY PROGRAMMABLE THERMOSTAT. MOUNT THERMOSTAT AT 48" A.F.F. COORDINATE WITH ARCHITECT AND ELECTRICAL CONTRACTOR. PROVIDE PROTECTIVE COVERING OVER THERMOSTAT. TYPICAL.
- 2 ROUTE EXHAUST UP TO ROOF EXHAUST FAN ON ROOF. PROVIDE ROOF EXHAUST FAN AS SCHEDULED. REFER TO MEP101.
- 3 PROVIDE RETURN AIR BOOT AT GRILLE. RE: DETAIL 2/M401.
- 4 CONNECT NEW FLEX DUCT FROM EXISTING DIFFUSER TO EXISTING DUCT. FIELD VERIFY EXACT LOCATION. BALANCE TO AIRFLOW NOTED ON PLAN
- PROVIDE DUCTLESS SPLIT SYSTEM AS SCHEDULED. MOUNT INDOOR UNIT AS HIGH AS POSSIBLE ON WALL. MOUNT ASSOCIATED CONDENSING UNIT ON ROOF WITH WIND RATED SUPPORTS. ROUTE REFRIGERANT LINES FROM CONDENSING UNIT AND PENETRATE ROOF AND CONNECT LINES TO ASSOCIATED INDOOR UNIT. ROUTE CONDENSATE TO FLOOR DRAIN IN IDF ROOM A134.
- ROUTE SUPPLY AND RETURN AIR DUCTWORK UP TO EXISTING ROOF TOP. CONTRACTOR SHALL FIELD VERIFY EXACT LOCATION OF EXISTING ROOF TOP UNIT AND PROVIDE THE NECESSARY DUCT TRANSITIONS. BALANCE TO SUPPLY AND OUTSIDE AIR AIRFLOWS (CFM) AS NOTED ON PLAN.
- 7 PROVDE OPEN-ENDED RETURN AIR DUCT AND COVER WITH MECHANICAL MESH.
- 8 PROVIDE RETURN AIR TRANSFER BOOT. RE: DETAIL 8/M401.

KEYPLAN

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CKD BY: Checker
JOB NO: 1706
REVISION:
SHEET NUMBER

M201
LEVEL 1
MECHANICAL PLAN

189005.000 SET NO.

WALL CONSTRUCTION RE: ARCHITECTURAL

10 RETURN AIR BOOT THRU WALL

	DUCTLESS S	SPLIT SYSTEM SCHEDULE	
LIZ	MARK	DS-1	DS-2
INDOOR UNIT	SERVES	IDF	ELECTRICAL
000	TYPE	HIGH WALL	HIGH WALL
<u>N</u>	AIRFLOW (CFM)	350	350
	TOTAL COOLING (MBH)	18	18
	VOLTS/PHASE/HERTZ	208/1/60	208/1/60
	MCA	1	1
	МОСР	15	15
	MANUFACTURER	MITSUBISHI	MITSUBISHI
	MODEL NUMBER	PKA-A18	PKA-A18
F	MARK	DSCU-1	DSCU-2
2 2	VOLTS/PHASE/HERTZ	208/1/60	208/1/60
OUTDOOR UNIT	MCA	13	13
UTD	МОСР	20	20
0	MANUFACTURER	MITSUBISHI	MITSUBISHI
	MODEL NUMBER	PUY-A18	PUY-A18
NOTE	S:	1, 2, 3	1, 2, 3
NOTE	S:		

. PROVIDE REFRIGERANT PIPING IN ACCORDANCE WITH MANUFACTURER'S RECOMMENDATIONS.

${\bf 2.\ \ PROVIDE\ WALL\ MOUNTED\ THERMOSTAT.}$
3. PROVIDE CONDENSATE PUMP.

12" DIA: 385-600 CFM

FAN SCHEDUL	_E
MARK	EF-1
SERVES	RESTROOMS
CFM	1,230
E.S.P. (IN W.G.)	0.375
TYPE	ROOF
DIRECT/BELT DRIVE	DIRECT
FAN RPM	1,036
MOTOR HORSEPOWER	1/6
VOLTS/PHASE/HERTZ	115/1/60
SONES	7.2
MANUFACTURER	соок
MODEL NO.	135C10D
NOTES	1, 2, 3
NOTES:	

1. PROVIDE WITH PRE-FABRICATED ROOF CURB (MINIMUM OF 12"), WEATHERPROOF DISCONNECT SWITCH, BACKDRAFT DAMPER. 2. PROVIDE SPEED CONTROLLER.

3. INTERLOCK WITH LIGH

		AIR DEVICE SCHEDU	JLE	
MARK	MANUFACTURER/MODEL	TYPE	NC	REMARKS
А	TITUS/TMS-AA	24"X24" SUPPLY	25	ALUMINUM CONSTRUCTION. NECK SIZES AS INDICATED BELOW UNLESS NOTED ON PLAN.
В	TITUS/50F	24"X24" EGGCRATE RETURN	20	ALUMINUM CONSTRUCTION. PROVIDE DAMPER FOR EXHAUST.
С	TITUS/300FL	SIDEWALL SUPPLY	25	ALUMINUM CONSTRUCTION. SEE MECHANICAL PLAN FOR SIZE.
D	TITUS/50F	12"X12" EGGCRATE RETURN	20	ALUMINUM CONSTRUCTION. PROVIDE DAMPER FOR EXHAUST.
NOTES:				
I. PROVIDE	STANDARD WHITE FINISH FOR AL	AIR DEVICES UNLESS NOTED OTHER	WISE ON PLA	AN.
2. PAINT AL	L SURFACES VISIBLE THROUGH FA	ACE OF RETURN AIR GRILLES FLAT BL	ACK. THIS SH	HALL INCLUDE PIPING, CONDUIT,
DUCTWC	ORK, AND STRUCTURAL MEMBERS.			
3. PROVIDE	FRAME FOR MOUNTING AIR DEVI	CE IN LAY-IN GRID CEILING UNLESS RE	FLECTED CE	ILING PLAN INDICATES HARD CEILING.
IN AREAS	S WITH HARD CEILINGS, PROVIDE F	FRAMES FOR SURFACE MOUNTING.		
4. UNLESS	OTHERWISE NOTED, BRANCH DUC	TS SERVING AIR DEVICES SHALL BE S	AME SIZE AS	NECK OF AIR DEVICE.
FOR ROU	IND NECK DIFFUSERS:			
6" DIA: 0-1	120 CFM			
8" DIA: 12	5-220 CFM			
	25-380 CFM			

MECHANICAL DETAILS AND SCHEDULES

NOT TO SCALE



American Bank Plaza 711 N. Carancahua, Suite 404 Corpus Christi, Texas 78401

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KEYPLAN

05/22/2018 JOB NO: 1706 **REVISION:**

SET NO.

SHEET NUMBER **MECHANICAL** Corpus Christi, Texas 78401 **DETAILS AND** 361.888.5797 p 361.888.9568 f TBPE Firm Registration No. 2234 **SCHEDULES**

DBR Project Number 189005.000

JT MG JB TL --

SECONDARY DAYLIGHT ZONE


ELECTRICAL METER

SURGE PROTECTION DEVICE

ARCHITECTS

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KEYPLAN

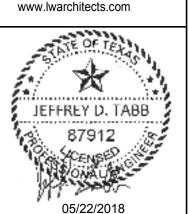05/22/2018 DWG BY CKD BY: Checke

JOB NO: REVISION: SHEET NUMBER

ELECTRICAL SYMBOL LEGEND

DBR Project Number 189005.000 JT | MG | JB | TL | --

TBPE Firm Registration No. 2234

Corpus Christi, Tx 78401

A. NOT ALL SYMBOLS SHOWN ON THIS SYMBOL LIST ARE USED IN THE

CONTRACT DOCUMENTS.

361.888.5797 p SET NO.

LEVEL 1 LIGHTING DEMO PLAN

1/8" = 1'-0"

A. IT IS THE CONTRACTOR'S RESPONSIBILITY TO HAVE FIELD VERIFIED EXISTING JOB-SITE CONDITIONS DURING THE BIDDING PERIOD TO OBTAIN SCOPE OF ELECTRICAL WORK INVOLVED AS A RESULT OF ARCHITECTURAL MODIFICATIONS TO THE EXISTING STRUCTURE. THE SCOPE OF WORK SHALL INCLUDE ALL LABOR AND MATERIAL CONSISTING OF FIXTURES, DEVICES, EQUIPMENT OR APPARATUS, CONDUIT AND WIRING WHICH MUST BE REROUTED, RELOCATED OR REMOVED EITHER TEMPORARILY OR PERMANENTLY, OR WHICH MUST BE PROVIDED, SO THAT THE INDICATED REMODELING MAY BE ACCOMPLISHED.

B. DISCONNECT AND REMOVE ALL EXISTING LIGHT FIXTURES IN AREA OF WORK UNLESS NOTED OTHERWISE. DISCONNECT AND REMOVE ALL CONDUIT AND WIRE BACK TO PANEL.

C. CONTRACTOR SHALL REMOVE ALL EXISTING LIGHTING CONTROL DEVICES SUCH AS SWITCHES, DIMMER, ETC. DISCONNECT AND REMOVE EXISTING CONDUIT AND WIRE.

D. OWNER SHALL RESERVE THE RIGHT TO CLAIM ALL EQUIPMENT AND CABLING REMOVED DURING DEMOLITION.

E. CONTRACTOR SHALL REMOVE ALL ELECTRICAL DEVICES WITHIN DEMOLISHED WALLS INCLUDING RECEPTACLES, SWITCHES, DATA/TELEPHONE DROPS, FIRE ALARM DEVICES, P/A DEVICES, CONDUIT, AND WIRING. REMOVE CONDUIT AND WIRING BACK TO PANEL. REFER TO ARCHITECTURAL DEMO PLAN.

F. CONTRACTOR SHALL REMOVE AND SALVAGE ALL EXISTING FIRE ALARM DEVICES. PROVIDE ADDITIONAL DEVICES AS REQUIRED PER NEW FIRE ALARM DESIGN. EXISTING FIRE ALARM CONTROL PANEL SHALL BE SALVAGED AND REINSTALLED. PROVIDE 120V POWER.

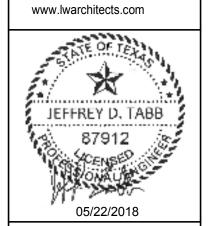
G. ANY EXISTING CONDUIT NOT BEING REUSED ROUTED BELOW GRADE SHALL BE ABANDONED.

H. ALL NEW LIGHT FIXTURES SHALL BE LOCATED PER NEW LIGHTING PLANS.

I. CONTRACTOR SHALL REPORT ANY DAMAGED DEVICES THAT ARE SHOWN AS EXISTING TO REMAIN TO THE OWNER BEFORE STARTING WORK. ALL DEVICES FOUND TO BE DAMAGED AT THE TIME OF SUBSTANTIAL COMPLETION THAT ARE NOT REPORTED PRIOR TO STARTING WORK SHALL BE REPLACED BY THE CONTRACTOR AT HIS COST.

ARCHITECTS

American Bank Plaza 711 N. Carancahua, Suite 404 Corpus Christi, Texas 78401 Phone: 361.884.7442 Fax: 361.883.1612



RENOVATIONS AT ADMINISTRATION BUIL SANTA ROSA INDEPENDENT SCHOOL DIS SANTA ROSA, TEXAS

KETT LAN

DATE: 05/22/2018
DWG BY: Author
CKD BY: Checker
JOB NO: 1706

REVISION:
SHEET NUMBER

EL101
LEVEL 1 LIGHTING

797 p DEMO PLAN
ation No. 2234

189005.000 SET NO.

 DBR Project Number
 189005.000

 JT | MG | JB | TL | -- |

400 Mann Street, Suite 602
Corpus Christi, Tx 78401
361.888.5797 p
TBPE Firm Registration No. 2234


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Phone: 361.884.7442 Fax: 361.883.1612 www.lwarchitects.com

GENERAL LIGHTING NOTES

ELECTRICAL KEYNOTE LEGEND

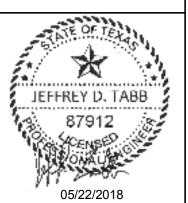TYPE 'G' FIXTURES SHALLL BE MOUNTED ON TOP OF ARCHITECTURAL COVE FACING UP. COORDINATE EXACT LOCATION WITH ARCHITECT IN



S AT ADMINISTRATION E INDEPENDENT SCHOOL RENOVATIONS A SANTA ROSA INI SANTA ROSA, TE

KEYPLAN

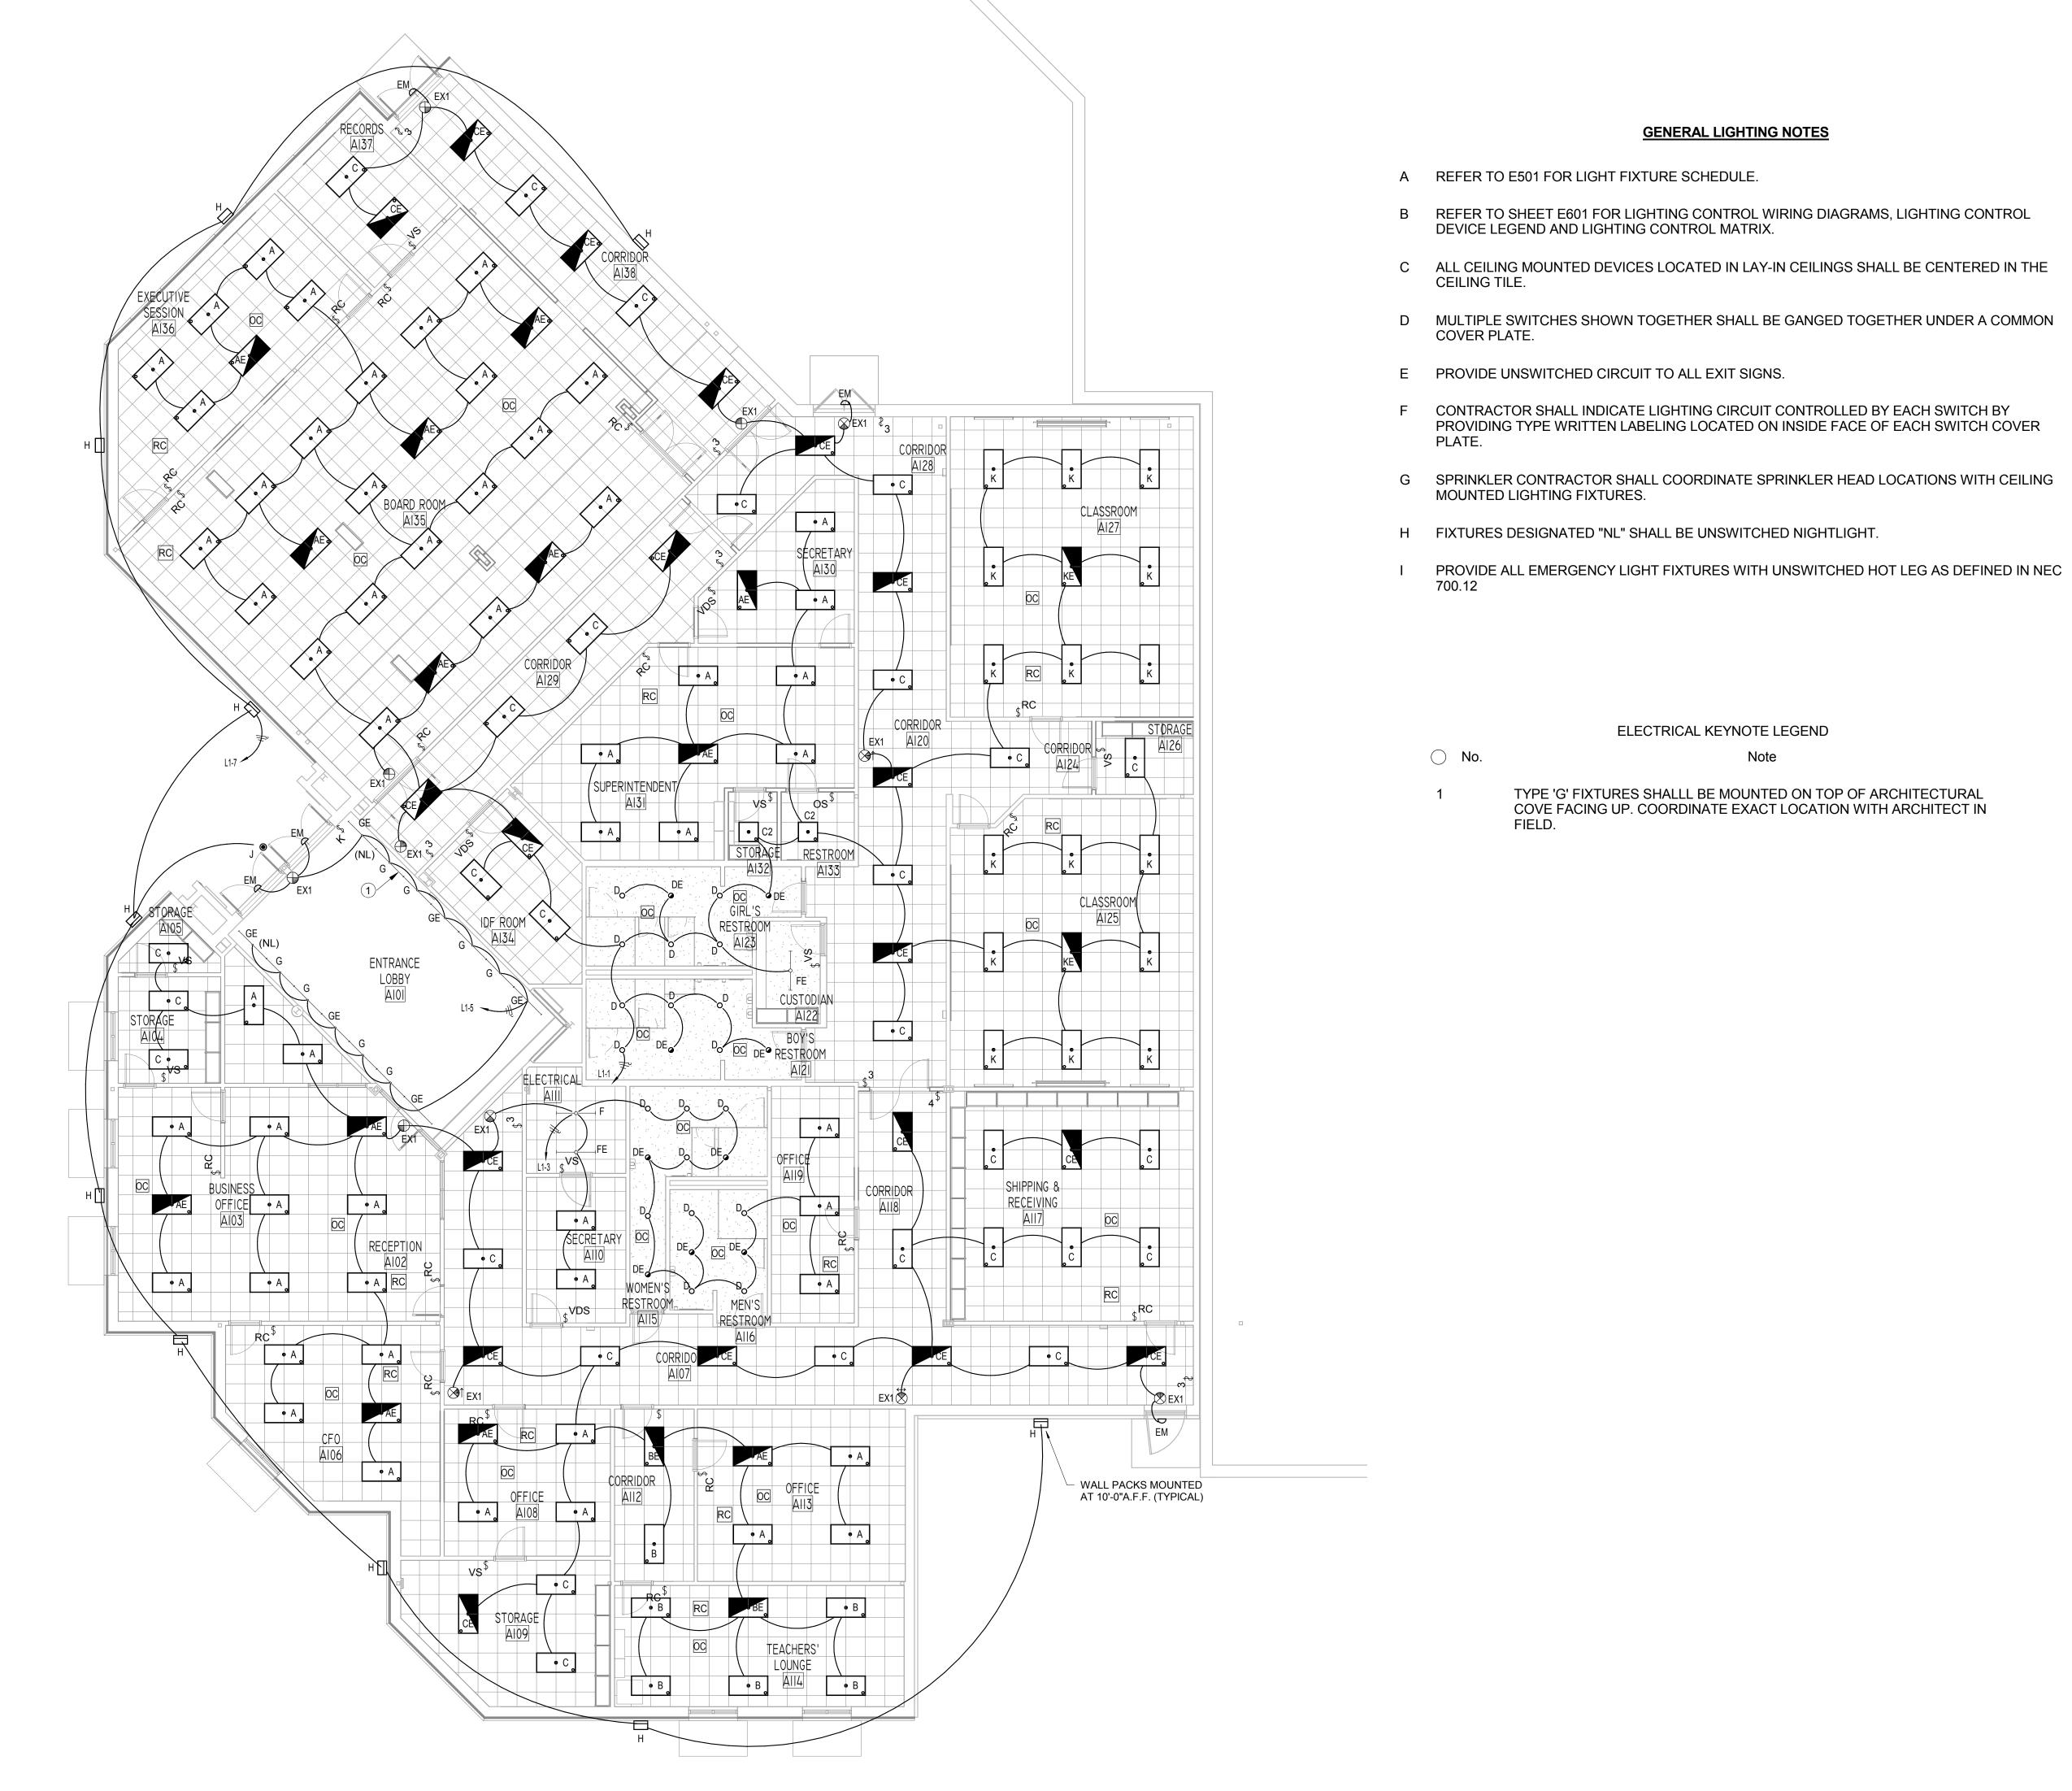
05/22/2018

SHEET NUMBER **EL201**

LEVEL 1 LIGHTING PLAN SET NO.

400 Mann Street, Suite 602 Corpus Christi, Tx 78401 361.888.5797 p TBPE Firm Registration No. 2234

JT MG JB TL --



1 LEVEL 1 LIGHTING PLAN
1/8" = 1'-0"

711 N. Carancahua, Suite 404 Corpus Christi, Texas 78401

American Bank Plaza

Phone: 361.884.7442

Fax: 361.883.1612

www.lwarchitects.com

JEFFREY D. TABB

LEVEL 1 POWER DEMO PLAN

1/8" = 1'-0"

ELECTRICAL KEYNOTE LEGEND

No.

Note

ELECTRICAL PANELS, TRANSFORMER AND LIGHTING CONTROL PANEL ARE EXISTING TO REMAIN, UNLESS NOTED OTHERWISE. EXISTING FEEDERS SHALL REMAIN. EXISTING PANEL 'R2' SHALL BE REPLACED WITH NEW PANEL. SEE ONE-LINE DIAGRAM. EXISTING FEEDER IS TO REMAIN. DISCONNECT AND REMOVE ALL EXISTING BRANCH CIRCUITS.

ELECTRICAL DEMOLITION GENERAL NOTES:

A. IT IS THE CONTRACTOR'S RESPONSIBILITY TO HAVE FIELD VERIFIED EXISTING JOB-SITE CONDITIONS DURING THE BIDDING PERIOD TO OBTAIN SCOPE OF ELECTRICAL WORK INVOLVED AS A RESULT OF ARCHITECTURAL MODIFICATIONS TO THE EXISTING STRUCTURE. THE SCOPE OF WORK SHALL INCLUDE ALL LABOR AND MATERIAL CONSISTING OF FIXTURES, DEVICES, EQUIPMENT OR APPARATUS, CONDUIT AND WIRING WHICH MUST BE REROUTED, RELOCATED OR REMOVED EITHER TEMPORARILY OR PERMANENTLY, OR WHICH MUST BE PROVIDED, SO THAT THE INDICATED REMODELING MAY BE ACCOMPLISHED.

B. DISCONNECT AND REMOVE ALL EXISTING ELECTRICAL DEVICES IN AREA OF WORK UNLESS NOTED OTHERWISE. DISCONNECT AND REMOVE ALL CONDUIT AND WIRE BACK TO PANEL.

C. CONTRACTOR SHALL REMOVE ALL ELECTRICAL CONNECTIONS TO EXISTING PREWIRED FURNITURE. REMOVE CONDUIT AND WIRING BACK TO LAST ACTIVE JUNCTION. ALL DATA CABLING SHALL BE REMOVED BACK TO LAST ACTIVE JUNCTION AND SALVAGED FOR REINSTALLATION.

D. OWNER SHALL RESERVE THE RIGHT TO CLAIM ALL EQUIPMENT AND CABLING REMOVED DURING DEMOLITION.

E. CONTRACTOR SHALL REMOVE ALL ELECTRICAL DEVICES WITHIN DEMOLISHED WALLS INCLUDING RECEPTACLES, SWITCHES, DATA/TELEPHONE DROPS, FIRE ALARM DEVICES, P/A DEVICES, CONDUIT, AND WIRING. REMOVE CONDUIT AND WIRING BACK TO PANEL. REFER TO ARCHITECTURAL DEMO PLAN.

F. CONTRACTOR SHALL REMOVE AND SALVAGE ALL EXISTING FIRE ALARM DEVICES. PROVIDE ADDITIONAL DEVICES AS REQUIRED PER NEW FIRE ALARM DESIGN. EXISTING FIRE ALARM CONTROL PANEL SHALL BE SALVAGED AND REINSTALLED. PROVIDE 120V POWER.

G. ANY EXISTING CONDUIT NOT BEING REUSED ROUTED BELOW GRADE SHALL BE ABANDONED.

H. ALL EQUIPMENT SHALL BE LOCATED PER NEW POWER PLANS. EXTEND ALL EXISTING FEEDERS AS REQUIRED FOR RELOCATION.

I. CONTRACTOR SHALL REPORT ANY DAMAGED DEVICES THAT ARE SHOWN AS EXISTING TO REMAIN TO THE OWNER BEFORE STARTING WORK. ALL DEVICES FOUND TO BE DAMAGED AT THE TIME OF SUBSTANTIAL COMPLETION THAT ARE NOT REPORTED PRIOR TO STARTING WORK SHALL BE REPLACED BY THE CONTRACTOR AT HIS COST.

Corpus Christi, Tx 78401

361.888.5797 p TBPE Firm Registration No. 2234

KEYPLAN

05/22/2018

DWG BY: CKD BY: JOB NO:

REVISION:
SHEET NUMBER

EP101

LEVEL 1 POWER DEMO PLAN

SET NO.

JT MG JB TL --

KEYPLAN

07/09/2018 DWG BY: CKD BY: Checker


JOB NO: REVISION: SHEET NUMBER

EP201 LEVEL 1 POWER

189005.000 SET NO.

TBPE Firm Registration No. 2234 DBR Project Number

Corpus Christi, Tx 78401 361.888.5797 p ______ JT | MG | JB | TL | --_

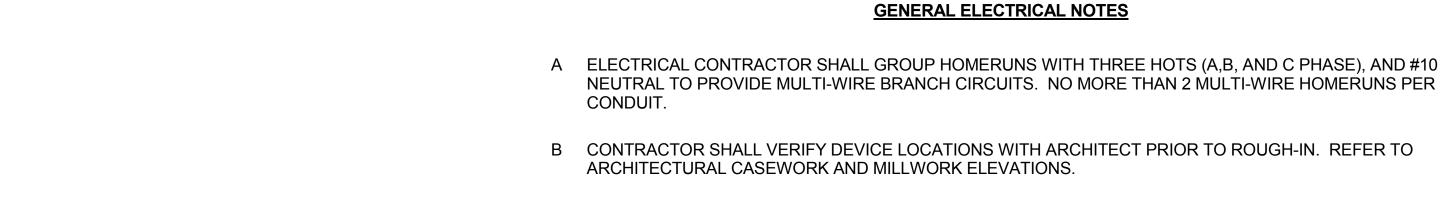

C ELECTRICAL CONTRACTOR SHALL PROVIDE CONDUIT, OUTLET BOXES, JUNCTION BOXES FOR ALL TELEPHONE, DATA, CATV, SECURITY, AND CAMERA OUTLETS. REFER TO DIVISION 26 SPECIFICATIONS AND TECHNOLOGY DRAWINGS FOR ALL WORK REQUIRED.

D ELECTRICAL CONTRACTOR SHALL COORDINATE WITH MECHANICAL CONTRACTOR FOR ALL EXHAUST FAN CONTROLS. PROVIDE A FAN SWITCH IF INDICATED BY MECHANICAL. ALL EXHAUST FANS SHALL BE PROVIDED WITH BUILT-IN DISCONNECT SWITCH.

E HVAC AND PLUMBING EQUIPMENT MAY DIFFER FROM LOCATIONS AS SHOWN ON ELECTRICAL DRAWINGS. COORDINATE EXACT LOCATIONS WITH MECHANICAL AND PLUMBING CONTRACTOR.

F ALL RECEPTACLES MOUNTED ABOVE COUNTERS AND WITHIN 6 FEET OF SINKS OR LAVATORIES SHALL BE GFCI TYPE.

G PROVIDE A DEDICATED HOT, NEUTRAL, AND GROUND FOR ALL COPY MACHINES.

H CONTRACTOR SHALL PROVIDE HANDLE TIES MANUFACTURED BY THE SWITCH GEAR SUPPLIER ON ALL MULTI-WIRE CIRCUITS TO MEET THE REQUIREMENTS OF ARTICLE 210.4(B) OF THE 2011 NEC. AT THE CONTRACTOR'S OPTION, TWO AND THREE POLE BREAKERS MAY BE USED.

CONTRACTOR SHALL INDICATE CIRCUIT SERVING EACH RECEPTACLE BY PROVIDING TYPE WRITTEN LABELING LOCATED ON INSIDE FACE OF EACH RECEPTACLE COVER PLATE.

ELECTRICAL CONTRACTOR SHALL ROUTE ELECTRICAL CONDUIT AND WIRING TO ALL ROOF HVAC EQUIPMENT THROUGH ROOF CURBS. ELECTRICAL CONTRACTOR SHALL COORDINATE WITH MECHANICAL CONTRACTOR PRIOR TO ROUGH-IN.

K CONTRACTOR SHALL ARRANGE PANELBOARDS IN ELECTRICAL ROOM TO PROVIDE CLEARANCE PER NEC 110.26.

L MECHANICAL CONTRACTOR SHALL FURNISH INTEGRAL DISCONNECT SWITCH FOR ALL MECHANICAL EQUIPMENT. ELECTRICAL CONNECTIONS SHALL BE PROVIDED BY DIVISION 26.

M VAVS WITH DAMPER ONLY SHALL BE CONNECTED BY MECHANICAL CONTRACTOR.

N REFER TO RESPECTIVE SIDE OF THE BOUNDARY MATCHLINE FOR THE APPROPRIATE FLOOR PLAN KEYED NOTES.

O PROVIDE JUNCTION BOX AND POWER FOR ALL HARD WIRED PLUMBING FLUSH VALVES AND SENSOR EQUIPMENT TRANSFORMERS FROM NEAREST 120V/20A CIRCUIT. COORDINATE WITH PLUMBER PRIOR TO ROUGH-IN FOR EXACT LOCATION.

P ALL MOTORIZED DAMPERS SHALL BE CONNECTED TO CIRCUIT XX-XX

Q ALL RECEPTACLES LOCATED IN RESTROOMS, JANITOR CLOSETS, MECHANICAL ROOMS, ELEVATOR PITS OR SHAFTS, ELEVATOR EQUIPMENT ROOMS, SERVING ELECTRIC DRINKING FOUNTAINS OR VENDING MACHINES, LOCATED WITHIN 6' OF A SINK, LOCATED ABOVE A WET COUNTERTOP OR IN A KITCHEN OR COFFEE BAR SHALL BE GFCI. EACH GFCI PROTECTED RECEPTACLE SHARING THE SAME CIRCUIT SHALL HAVE ITS OWN RE-SET AND TEST BUTTON.

R ALL EXPOSED CONDUIT SHALL BE ROUTED PERPENDICULAR, PARALLEL, AND TIGHT TO COLUMNS AND BEAMS. ALL EXPOSED CONDUIT ROUTING SHALL BE COORDINATED WITH ENGINEER AND ARCHITECT PRIOR TO INSTALLATION. NO ADDITIONAL COST TO OWNER WILL BE ALLOWED FOR RELOCATING CONDUIT DUE TO THE LACK OF COORDINATION WITH ARCHITECT.

ELECTRICAL KEYNOTE LEGEND

208V, 30A/2P, NEMA 1, N.F. DISCONNECT SWITCH FOR WATER HEATER. COORDINATE EXACT LOCATION AND REQUIREMENTS WITH PLUMBING.

PROVIDE 120V, MOTOR RATED TOGGLE SWITCH AND CIRCUIT FOR CIRC PUMP. EXTEND CIRCUIT TO TIME SWITCH AND CONNECT AS REQUIRED. COORDINATE EXACT LOCATION OF EQUIPMENT AND REQUIRMENTS WITH PLUMBING.

MOUNT RECEPTACLES IN CAVITY OF WATER COOLER, PROVIDE REMOTE GFI RESET BUTTON, SEE

DETAIL 8/E401. PROVIDE GROUND BUS BAR. SEE DETAIL 5/E401.

DEVICES MOUNTED IN RECESSED CEILING BOX. PROVIDE CHIEF #CMS491 RECESSED BOX (OR

EQUAL). COORDINATE EXACT LOCATION WITH OWNER IN FIELD.

PROVIDE FLUSH MOUNTED FLOOR BOX. WIREMOLD EVOLUTION SERIES EFB6 (OR EQUAL). PROVIDE TWO DUPLEX RECEPTACLES AND PROVISIONS FOR DATA OUTLETS. PROVIDE 3/4"C UNDER SLAB TO NEAREST WALL, UP WALL TO PANEL AND CIRCUIT INDICATED. PROVIDE ONE 2" CONDUIT UNDER SLAB TO NEAREST WALL, UP WALL TO ACCESSIBLE LOCATION ABOVE CEILING FOR DATA CABLING. TRENCH AND REPAIR EXISTING CONCRETE FLOOR AS REQUIRED AND PER ARCHITECT'S SPECIFICATIONS.

DEVICES MOUNTED IN MILLWORK DESK. COORDINATE EXACT LOCATION AND MOUNTING WITH ARCHITECT IN FIELD. COORDINATE CONDUIT ROUTING WITH ARCHITECT IN FIELD.

PROVIDE 4'x4'x3/4" PLYWOOD TELEPHONE BOARD. INDOOR UNIT SHALL RECEIVE POWER FROM OUTDOOR UNIT. PROVIDE 3/4"C BETWEEN UNITS FOR

CONTROL CONDUCTORS. SEE ROOF PLAN FOR OUTDOOR UNIT. FLUSH MOUNTED J-BOX FOR CARD READER. PROVIDE 3/4"C TO ACCESSIBLE LOCATION ABOVE CEILING. COORDINATE EXACT LOCATION AND MOUNTING HEIGHT WITH ARCHITECT PRIOR TO

PROVIDE 120V POWER TO DOOR HARDWARE AS REQUIRED. COORDINATE EXACT LOCATION AND REQUIREMENTS WITH FURNISHED EQUIPMENT.

FLUSH MOUNTED J-BOX IN WALL BELOW COUNTER. PROVIDE ONE EMPTY 1" CONDUIT WITH PULLSTRING FROM J-BOX TO CEILING MOUNTED TV IN BOARD ROOM.

LEVEL 1 POWER PLAN

1/8" = 1'-0"

BOY'S RESTROOM R2-67

CORRIDOR AI07

φ**Δ**

STORAGE A109

(TYP. FOR 2)

AP AP

TEACHERS' LOUNGE

RECORDS AI37

 \bigoplus_{AP}

SECRETARY AI30

CLASSROOM AI27

CLASSROOM

SHIPPING & RECEIVING

BOARD ROOM

ENTRANCE LOBBY

ΦΔ.

BUSINESS OFFICE

EXECUTIVE SESSION
AI36

KEYPLAN

05/22/2018

CKD BY: JOB NO:


REVISION:

SHEET NUMBER

EF201

LEVEL 1 FIRE ALARM

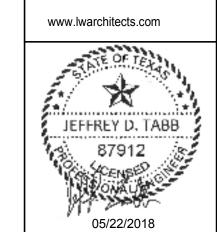SET NO.



Phone: 361.884.7442 Fax: 361.883.1612

GENERAL FIRE ALARM NOTES

- A ALL CEILING MOUNTED DEVICES SHALL BE CENTERED IN THE CEILING TILE.
- ALL FIRE ALARM VISUAL AND AUDIO/VISUAL DEVICES SHALL BE CONFIGURED TO PROVIDE CANDELA RATINGS IN ACCORDANCE WITH ADA & NFPA COVERAGES.
- C ALL VISUAL FIRE ALARM DEVICES SHALL BE 15 CD UNLESS NOTED OTHERWISE
- D ALL WIRING FOR DEVICES IN EXPOSED STRUCTURE AREAS SHALL BE ROUTED WITHIN CONDUIT. NO WIRING SHALL BE ROUTED EXPOSED.
- ALL NEW FIRE ALARM DEVICES SHALL TIE INTO EXISTING FIRE ALARM SYSTEM. FIELD VERIFY LOCATION OF EXISTING FIRE ALARM CONTROL PANEL BEFORE BID. PROVIDE ALL NEW CONDUIT AND WIRING AS REQUIRED.
- ALL NEW FIRE ALARM DEVICES SHALL BE U.L. LISTED TO OPERATE WITH EXISTING FIRE ALARM SYSTEM. FIELD VERIFY EXISTING FIRE ALARM SYSTEM MANUFACTURER BEFORE BID.
- G PROVIDE NEW FIRE ALARM ZONE POWER SUPPLIES AS REQUIRED.

GENERAL FIRE ALARM REMODEL NOTES:

1. REFER TO THE FIRE ALARM PLAN FOR FIRE ALARM DEVICES, NEW OR EXISTING. BEING ADDED, RE-USED OR REMOVED BY THIS REMODEL.

2. THE INTENT OF THIS PLAN IS TO INCORPORATE NEW AND RELOCATED DEVICES WITH THE EXISTING BASE BUILDING FIRE ALARM SYSTEM. WHEN A PULL STATION OR SMOKE DETECTOR IS ACTIVATED THE STROBES WILL FLASH AND SPEAKERS WILL SOUND ON THE FLOOR ABOVE AND THE FLOOR BELOW THE FLOOR OF INCIDENCE.

3. IT IS ASSUMED WITH THIS REMODEL THAT THE EXISTING SYSTEM MEETS REQUIRED CODES FOR THE ORIGINAL DATE OF INSTALLATION, AND BUILDING MANAGEMENT HAS MAINTAINED SYSTEM IN COMPLIANCE WITH LIFE SAFETY 101. FOR SEQUENCE OF OPERATIONS AND SPECIFICATIONS, REFER TO ORIGINAL SYSTEM DOCUMENT. COORDINATE WITH BUILDING MANAGEMENT.

4. THE EQUIPMENT SUPPLIER AND INSTALLING CONTRACTOR SHALL BE LICENSED BY THE STATE FIRE MARSHALL TO SELL, INSTALL, AND SERVICE FIRE ALARM SYSTEMS AS REQUIRED BY ARTICLE 5.49-2 OF THE TEXAS INSURANCE CODE.

5. ALL NEW EQUIPMENT REQUIRED FOR THIS REMODEL SHALL BE COMPATIBLE WITH THE EXISTING BUILDING SYSTEM AND SHALL BE PART OF THE SUBMITTAL PROCESS AS NOTED IN THE ELECTRICAL SPECIFICATIONS FOR THIS PROJECT. PROVIDE ADDITION SYSTEM POWER BOOSTER WHERE REQUIRED.

6. APPROVED FIRE ALARM CONTRACTOR TO FIELD VERIFY THAT THE EXISTING SYSTEM IS ADEQUATE FOR ADDITIONS AND MODIFICATIONS AND DETERMINE EXACT LOCATIONS OF NEW, RELOCATED AND EXISTING DEVICES. VERIFY QUANTITIES OF NEW DEVICES TO INTERFACE WITH THE EXISTING BUILDING SYSTEM. THE CONTRACTOR SHALL COORDINATE WITH BUILDING MANAGEMENT AND SHALL NOTIFY THE ENGINEER IF ANY CONFLICT EXISTS PREVENTING MODIFICATIONS REQUIRED IN THESE PLANS.

7. THE SYSTEM WHEN MODIFIED, SHALL BE A COMPLETE AND WORKING SYSTEM, AND COMPLY WITH THE MOST RECENT RULES, REGULATIONS, AND ORDINANCES THAT PRESENTLY APPLY TO THIS REMODEL.

8. ALL FIRE ALARM WORK SHALL BE APPROVED BY THE OWNER PRIOR TO START OF CONSTRUCTION.



JT MG JB TL --

TEACHERS' S LOUNGE AII4 LEVEL 1 FIRE ALARM PLAN

1/8" = 1'-0"

SESSION

,`-GIRL'S

RESTROOM

ELECTRICAL

BOY'S

-RESTROOM.

MEN'S

RESTROOM

RECEIVING

WOMEN'S

RESTROOM

ENTRANCE LOBBY AIOI

OFFICE AI03

* JEFFREY D. TABB

KVA

1.0

20.7

15.9

0.0

0.0

0.0

123.0

0.0

0.0

0.0

0.0

0.0

2.0

1.0

172.4

207.4

400.0

220-10(b)

220-10(b)

220-13

220-21

TOTAL AMPS:

SERVICE SIZE:

SPARE AMPACITY: 192.6

ELECTRICAL LOAD ANALYSIS

480 / 277, 3 -PHASE, 4 -WIRE

KEYPLAN

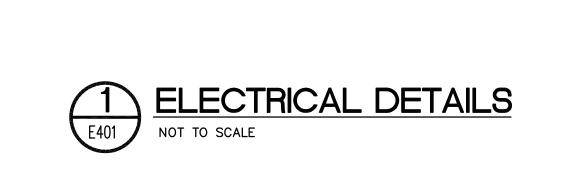
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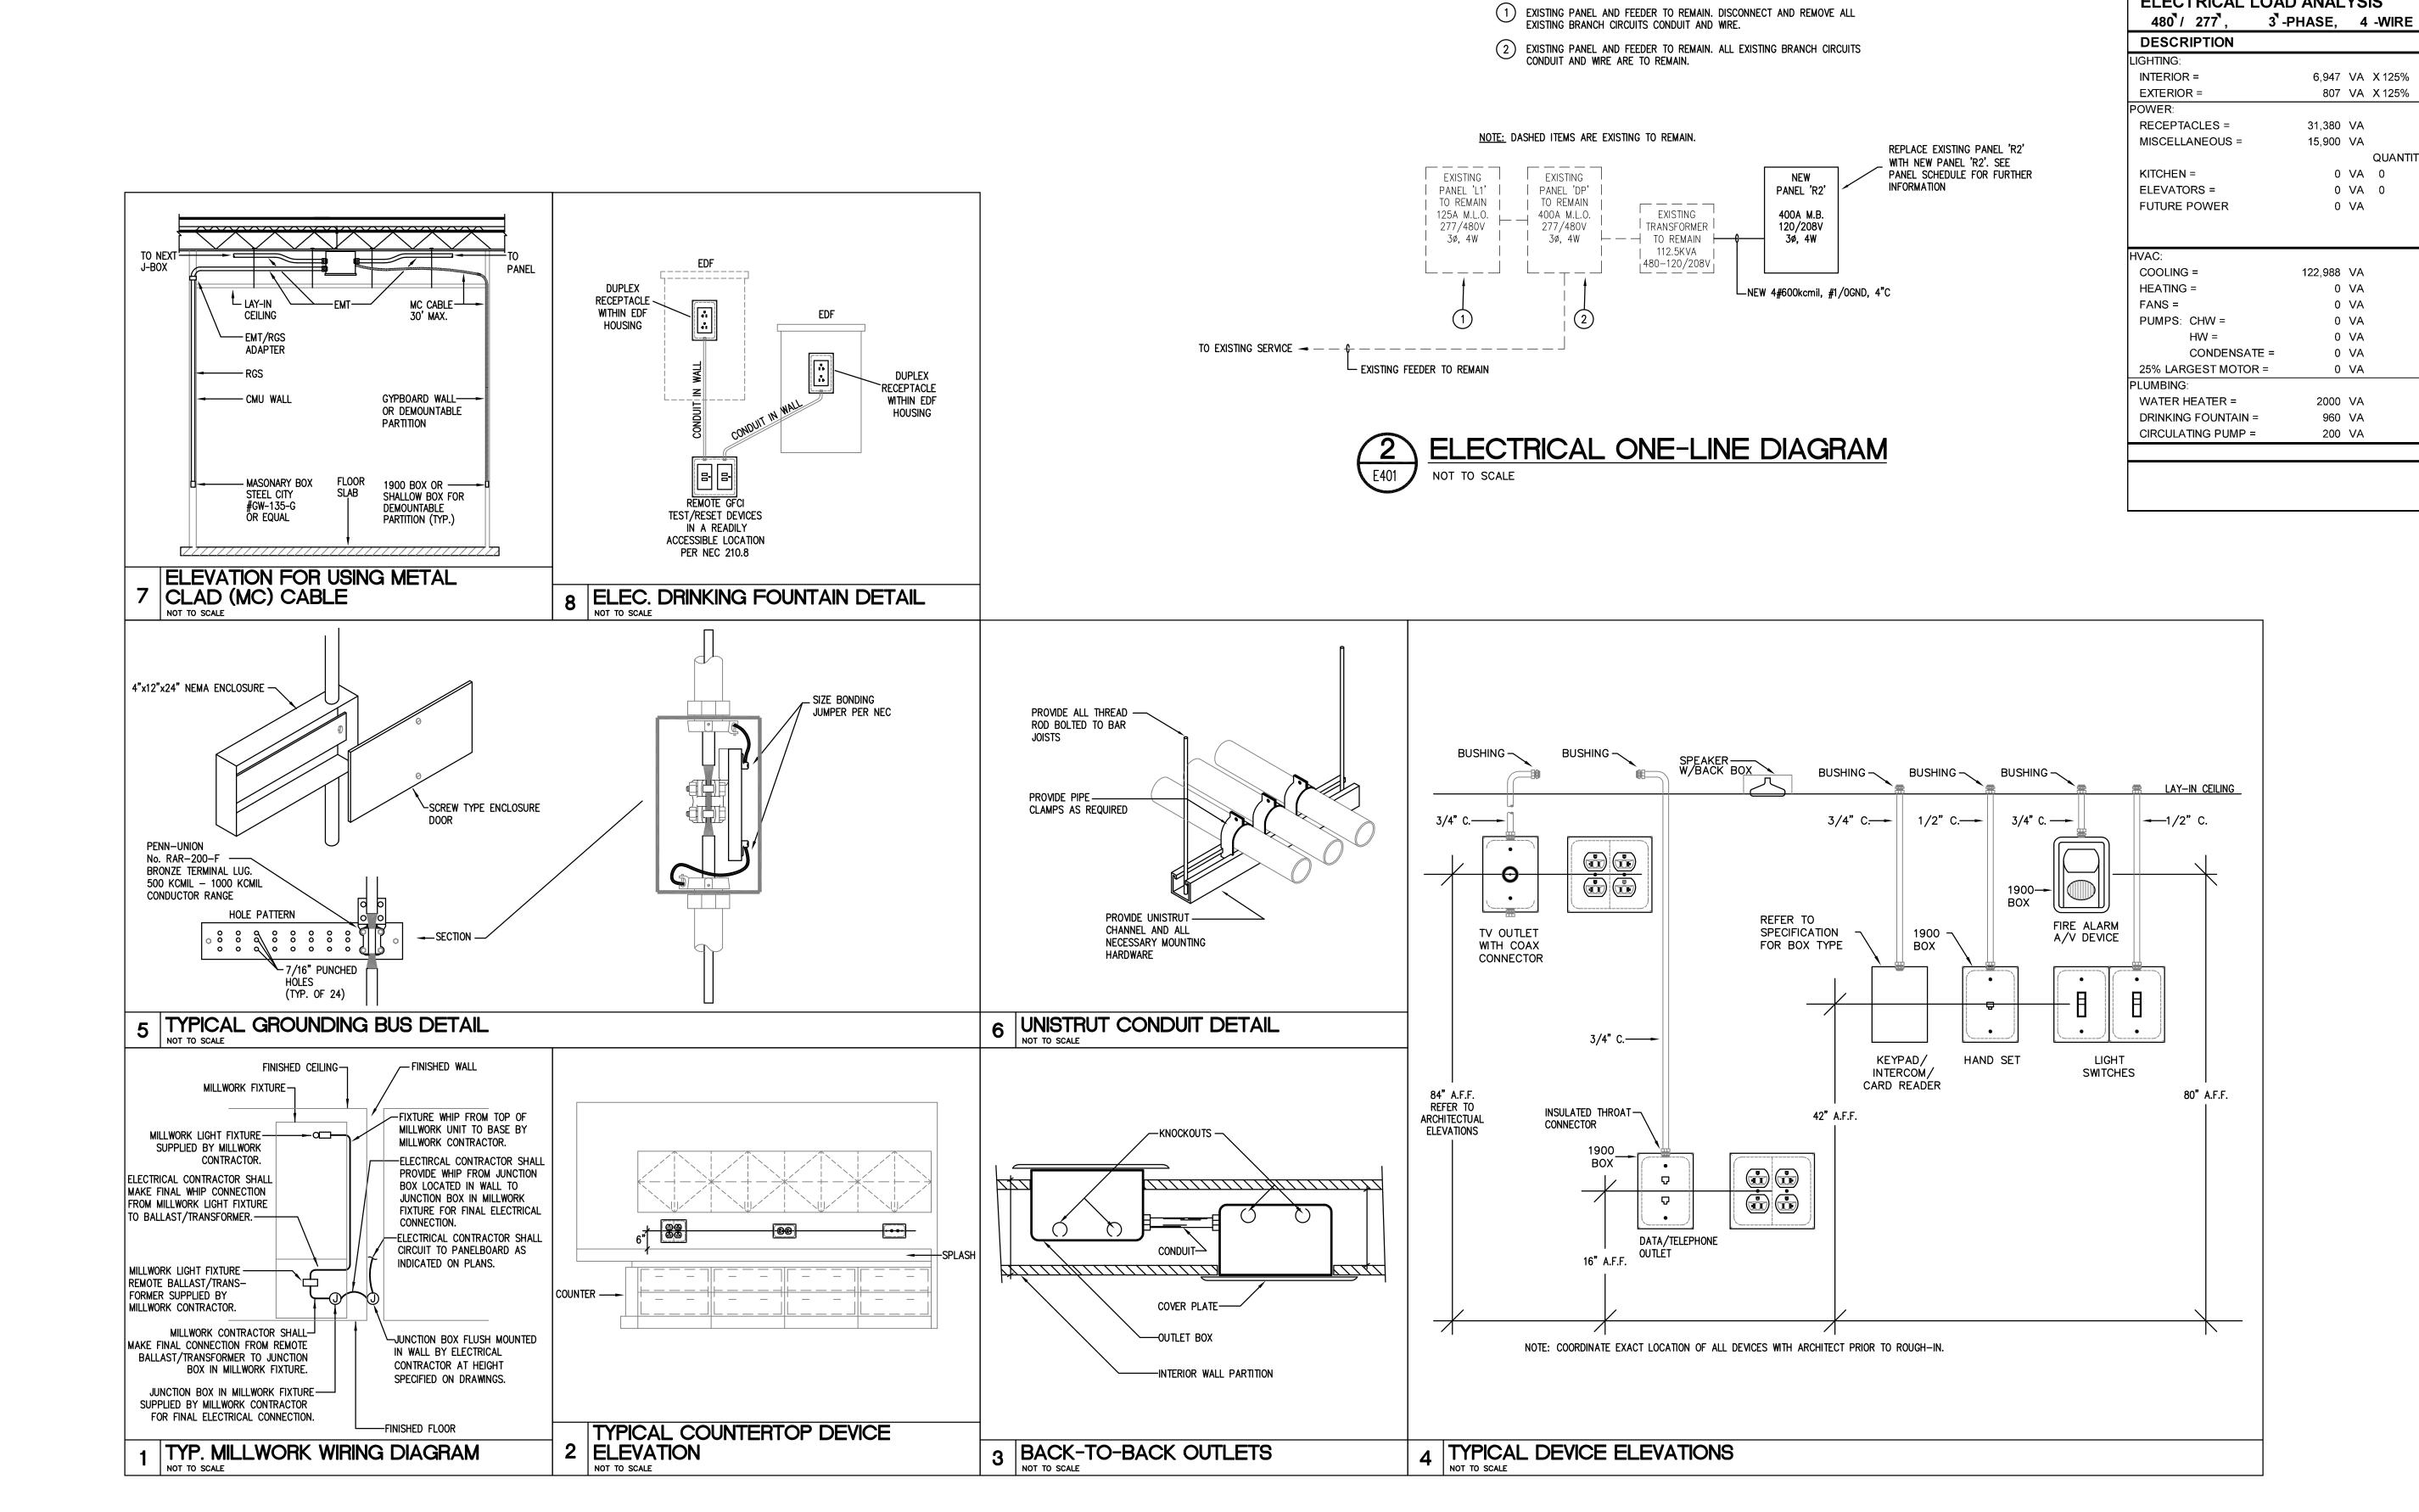
JOB NO: REVISION: E401 ELECTRICAL

SHEET NUMBER **DETAILS AND** SCHEDULES SET NO.



JT MG JB TL --





ONE-LINE DIAGRAM KEYED NOTES:

					Pan	elbo	oard [ЭP)					,		00 AIC New X Exis	,	
480	0/277 Wye	Volt, 3	Phase, 4	Wire Ma	ains Type:		0 A N	1CB						X Single			Mountin	g
	1	Section	n		MLO		400 A B	US	(Co	pper)				Double			X Surface	
			Rating		IVILO					ND. BUS	3			Feed - Thre	u		Flush	
Note	Load	Type		Description		Wire	CB		KT	CB	V	Vire		Description		Туре	Load	N
1	39888 VA	Existi ng Load	EX	ISTING LO	AD	6	60 A	1 3 5	2 4 6	25 A	,	10	E)	XISTING LOAD)	Existi ng Load	16620 VA	1
1	19944 VA	Existi ng Load	EX	ISTING LO	AD	10	30 A	7 9 11	8 10 12	20 A		12	EX	KISTING LOAD)	Existi ng Load	13296 VA	. 1
1	19944 VA	Existi ng Load	EX	ISTING LO	AD	10	30 A		14 16 18	20 A		12	EX	KISTING LOAD)	Existi ng Load	13296 VA	. 1
								19	20					Space				
1	7754 VA	L	EXIST	TING PANE	L 'L1'	3	100 A	21						Space		-		
								23	24					Space		-	-	
				Space				25						Space				
				Space				27	28					Space				
				Space				29						Space				
				Space				31	32					Space				
				Space					34					Space				<u> </u>
				Space										Space				<u> </u>
		R;	FXIS	TING 112.5	KVA			37	38					Space				
1	52104 VA	WH;		ISFORMER		2/0	175 A							Space				
		SP;					<u> </u>		42					Space				<u> </u>
	E.C. (2014)		d Type	Conn.	Fct.		Diversity		_	E.C.(20			ad Type	Conn.	Fct		Diversit	
	220.44		•	31380 VA	65.93%	6	20690 V	A	2	210.20(a	1)		ghting	7754 VA	125.0	0%	9693 V	Α
	220.56	(K)Kit	chen									1, ,	Ext. Ltg.					
	220.60	(C)Co	oling	5824 VA	100.009	%	5824 VA	١		620.14		(E)E	levators					
	220.60	(Н)Не	ating				0 VA					(WH)Wat. Htr.	2000 VA	100.0	0%	2000 V	Α
	220.60	(F)Far	ns							220.5		(MT)	Lrg. Motor					
		(M)Mi		12900 VA	100.00	%	12900 V	Α				1 '	Sub Pnl.	0 VA	Not Con	nputed	0 VA	
	Total Co	` '	ed Load:	182846 VA	VA =	2	20 A					, ,	I			•		
			ersified):	204842 VA			46 A				Lo	catior	n of Panel:	ELECTRICAL	A111			

				Pan	elbo	oard L	_1							6500	00 AIC New X Exis	· ·	
480)/277 Wye	Volt, 3	Phase, 4 Wire	Mains Type:		0 A N	ΛСВ	}				>	Single			Mountii	ng
	1	Section	า	MLO		125 A B	BUS	(Co	pper)				Double			K Surface	е
	Type 1	-Nema	Rating	IVILO			SO.	GRI	ND. BUS	S			Feed - Thru		.	Flush	
lote	Load	Type	Descrip	tion	Wire	СВ	С	ΚT	CB	W	/ire		Description		Туре	Load	N.
2	3564 VA	L	INTERIOR L	IGHTING	12	20 A	1	2	20 A				Spare				
2	2598 VA	L	INTERIOR L	IGHTING	12	20 A	3	4	20 A				Spare				
2	785 VA	L	LOBBY LIG	HTING	12	20 A	5	6	20 A				Spare				
2	807 VA	L	EXTERIOR L	IGHTING	12	20 A	7	8	20 A				Spare				
			Spar	е		20 A	9	10	20 A				Spare				
			Spar	е		20 A	11	12	-				Space				
			Spac	e			13	14					Space				
			Spac	е				16					Space				
			Spac	е			17	_	-				Space				
			Spac	е				20					Space				
			Spac	е				22	-				Space				
			Spac	е				24	-				Space				
			Spac	е				26	-				Space				
			Spac	е			27		-				Space				
							29						Space				
N.E	.C. (2014)	Loa	d Type Conn.	. Fct.		Diversity	y	N.	E.C.(20	14)	Load Typ	ре	Conn.	Fct	t.	Divers	ity
	220.44	(R)Re	ceptacle					2	210.20(a	a)	(L)Lighting		7754 VA	125.0	00%	9693 \	VΑ
	220.56	(K)Kito	chen								(EL)Ext. Lt	g.					
	220.60	(C)Co	oling			0 VA			620.14		(E)Elevato	rs					
	220.60	(H)He	ating			0 VA					(WH)Wat.	Htr.					
	220.60	(F)Far				•			220.5		(MT)Lrg. N						
	0.00	(M)Mis							220.0		(SP)Sub P						
	Total C	· ,		4 VA VA =	: 9,	Λ					(OF JOUD F	111.					
					_	· -				Lo	cation of Pa	nel: E	LECTRICAL A	4111			
	Total Loa	ad (DIV	ersitied): 9693	3 VA VA =	12	2 A											

PANEL SCHEDULE NOTES:

EXISTING CIRCUIT, BREAKER, CONDUIT AND WIRE TO REMAIN.
 REUSE EXISTING BREAKER FOR NEW CIRCUIT. PROVIDE NEW CONDUIT AND WIRE.


					nelbo	oard I							4200	00 AIC X New Exis	1	
20	208 Wye	Volt, 3	Phase, 4 Wire	Mains Type:		400 A N	ИСВ					X Single			Mountin	g
	1	Section	n	МСВ		400 A E	BUS	(Co	pper)			Double			X Surface	
	Type 1	-Nema	Rating	IVICE		I:	SO.	GR	ND. BU	S		Feed - Thru	ı		Flush	
te	Load	Туре	Descr	iption	Wire	СВ	CI	KT	СВ	Wire	e	Description		Туре	Load	N
T	360 VA	R	I.T. ROO	M QUAD	12	20 A	1	2								
1	360 VA	R	I.T. ROO	M QUAD	12	20 A	3	4	30 A	10	SURGE P	ROTECTION I	DEVICE	SP	0 VA	
7	360 VA	R	I.T. ROO	M QUAD	12	20 A	5	6								
7	360 VA	R	I.T. ROO	M QUAD	12	20 A	7	8	00.4	40		E14/11.4			0000 \ / 4	
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4	360 VA	R	STORAGE A1		12	20 A	_	46	20 A	12		OPIER A130		M	1500 VA	├
4	720 VA	R	CLASSRO		12	20 A	_	48	20 A	12		OPIER A103	NA/A DE	M	1500 VA	├
4	720 VA	R	CLASSRO		12	20 A		50	20 A	12	DOOR A	CCESS HARD	WARE	M	400 VA	┝
4	360 VA	R	SECRETA		12	20 A	51		20 A	12		DSCU-1		С	2912 VA	
+	720 VA	R	SUPERINTE		12	20 A	53				_					┢
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+	540 VA	R	RECEPTION STORAGE 104		12	20 A	_	60	20 A			Chara				┝
+	1500 VA	M	HAND DR		12	20 A	_	62	20 A			Spare Spare				┢
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American Bank Plaza
711 N. Carancahua, Suite 404
Corpus Christi, Texas 78401

Phone: 361.884.7442
Fax: 361.883.1612

www.lwarchitects.com



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KEYPLAN

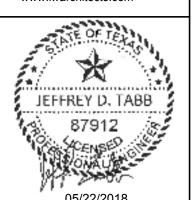DATE: 05/22/2018
DWG BY: Autho
CKD BY: Checke
JOB NO: 1706
REVISION:

E501
ELECTRICAL
SCHEDULES

SET NO.

361.888.5797 p
TBPE Firm Registration No. 2234

Project Number 189005.000

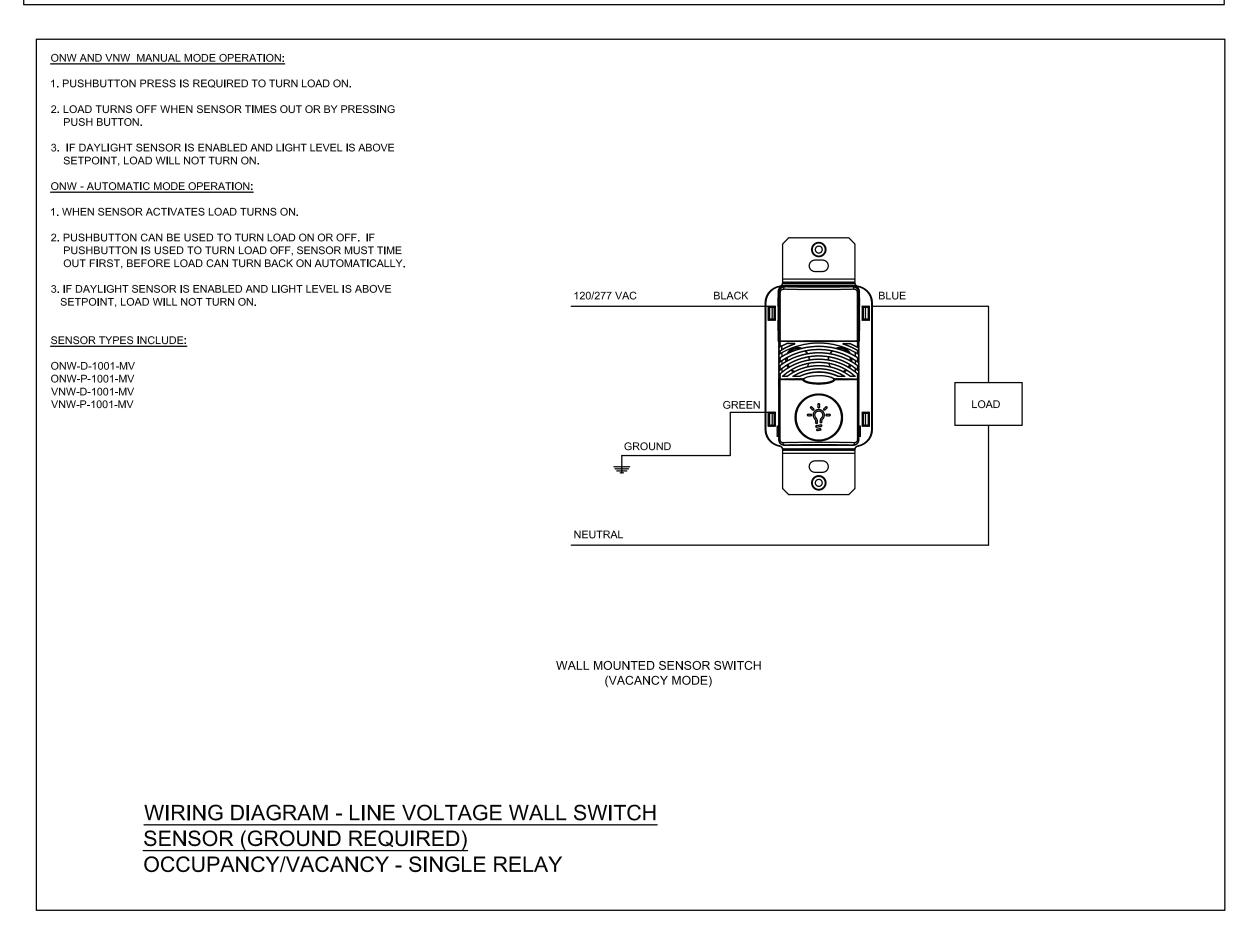
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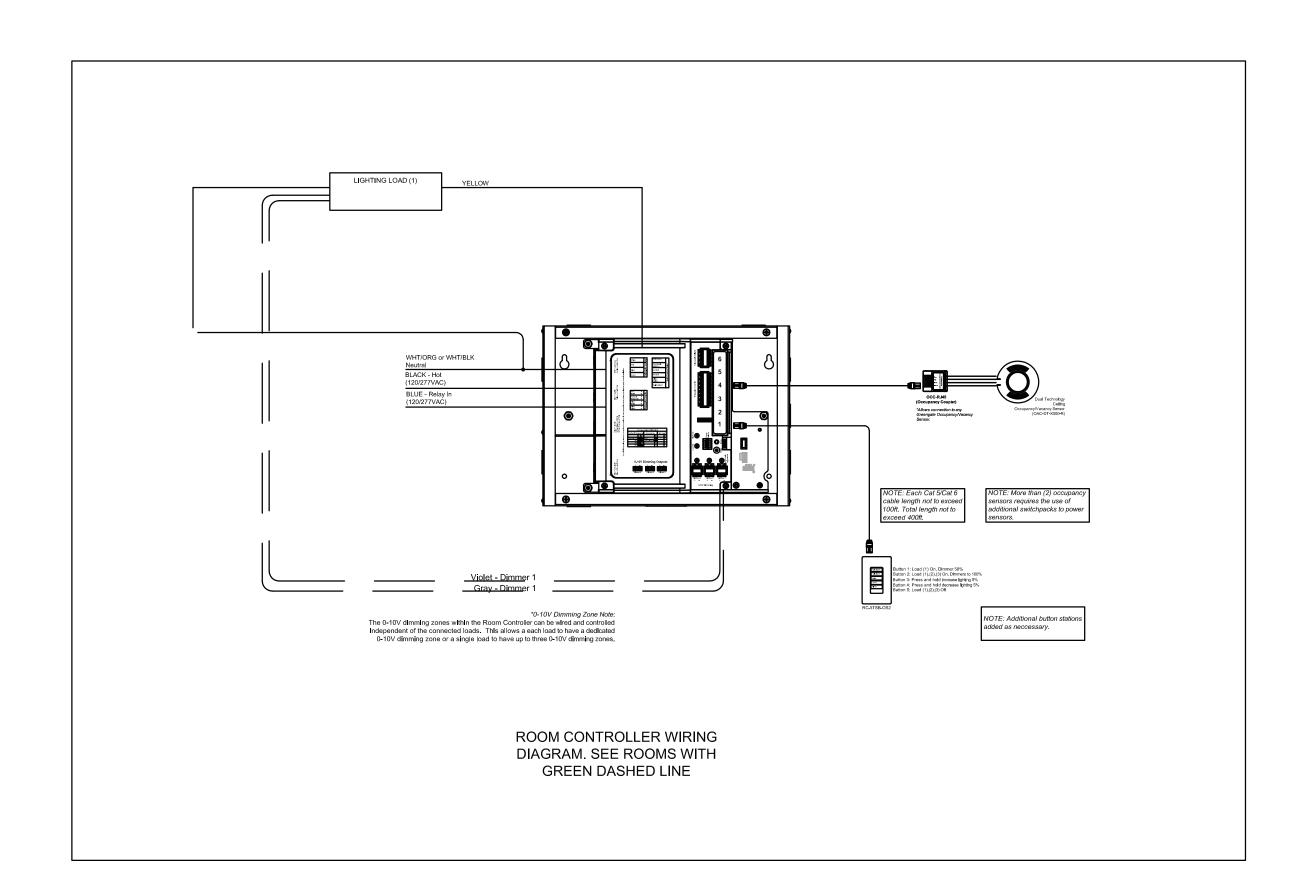
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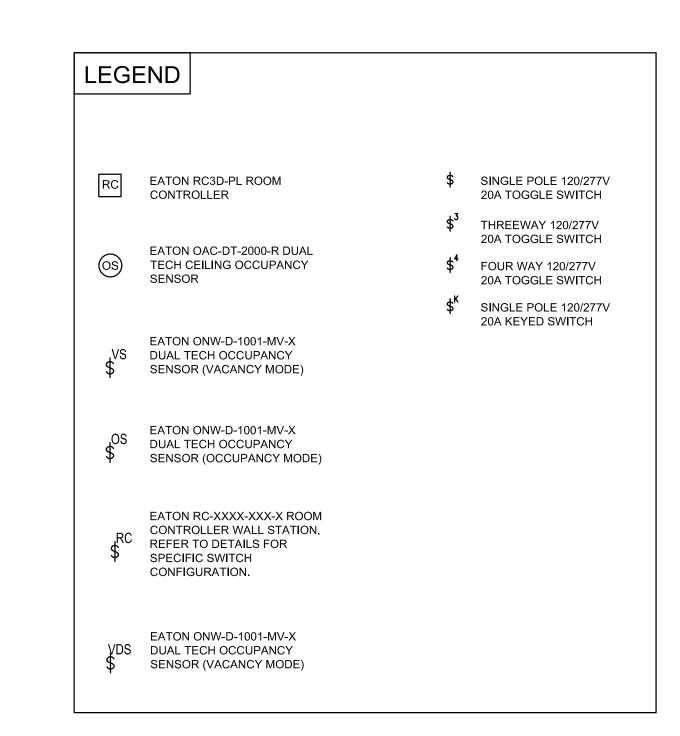
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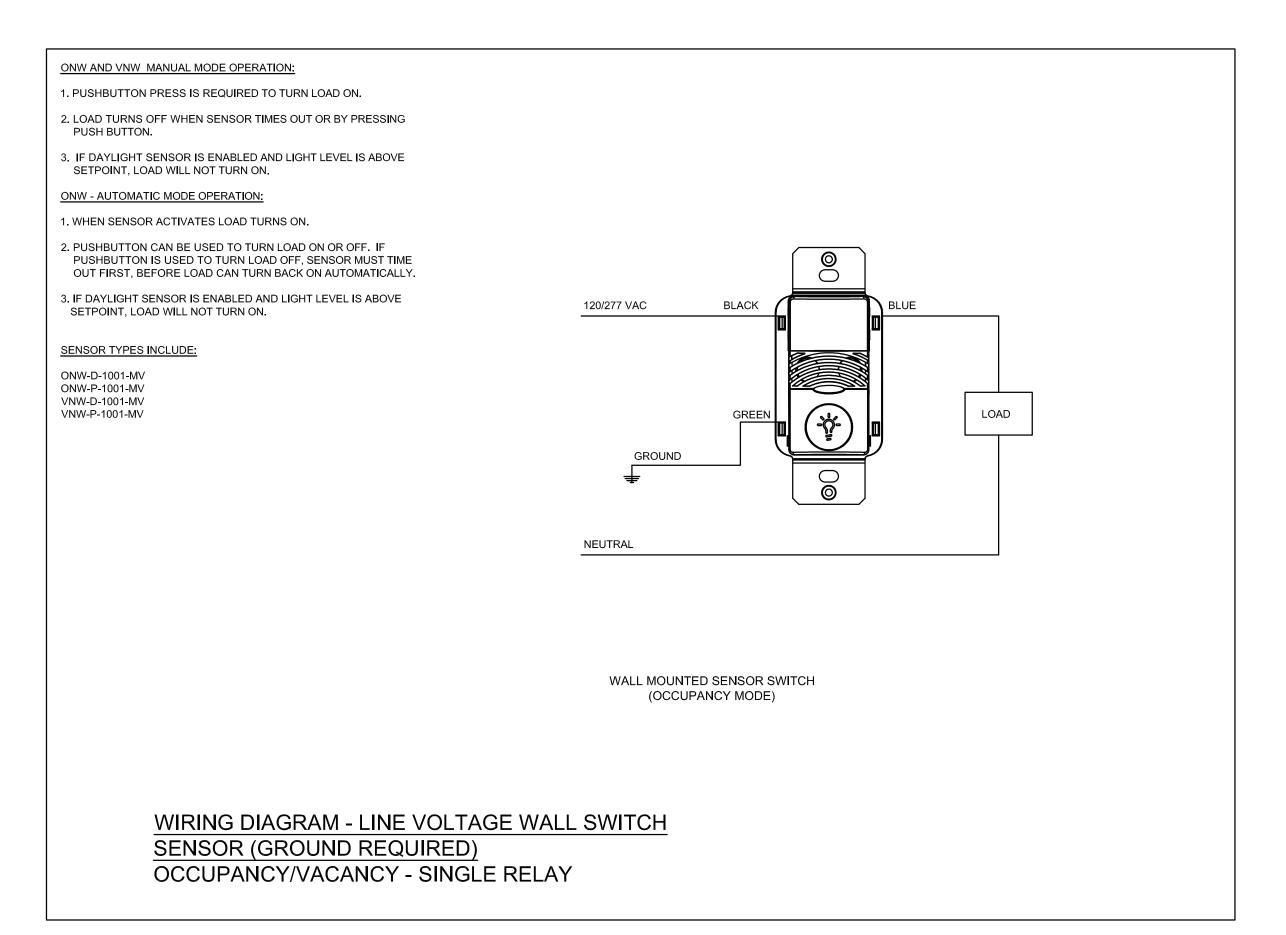
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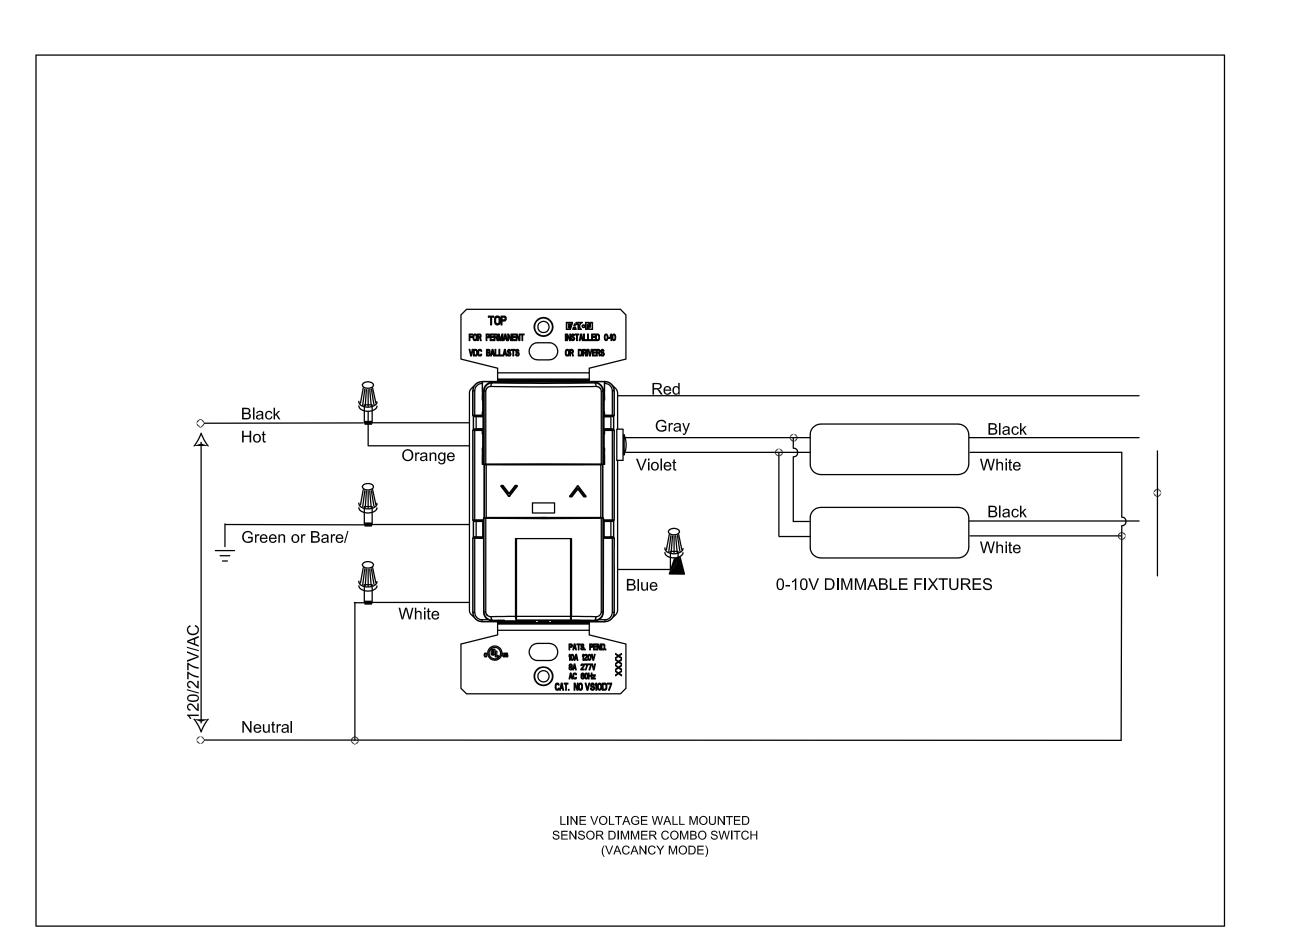














American Bank Plaza 711 N. Carancahua, Suite 404 Corpus Christi, Texas 78401 Phone: 361.884.7442 Fax: 361.883.1612

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KEYPLAN

DATE: 05/22/2018 DBR JOB NO: 1706 REVISION:

SHEET NUMBER

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ELECTRICAL

DETAILS AND SCHEDULES

SET NO.

400 Mann Street Suite. 602 Corpus Christi, Texas 78401 361.888.5797 p 361.888.9568 f TBPE Firm Registration No. 2234

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_	-	TECHNOLOGY LEGEND
SY SY	MBOL	DESCRIPTION
	∇	INDICATES THE LOCATION OF A NEW TECHNOLOGY OUTLET. CONTRACTOR TO PROVIDE FACEPLATE WITH A MINIMUM OF 4-PORTS AT EACH LOCATION UNLESS OTHERWISE NOTED. ELECTRICAL CONTRACTOR TO PROVIDE A DOUBLE GANG BACK BOX WITH A SINGLE GANG REDUCER RING AND A 1" EMT CONDUIT FROM THE BOX TO THE NEAREST ACCESSIBLE CEILING. SOME EXISTING BUILDINGS MAY REQUIRE SURFACE MOUNTED RACEWAY. ELECTRICAL CONTRACTOR TO PROVIDE AND INSTALL RACEWAY AS SPECIFIED AND DESIGNATE IN THE ELECTRICAL CONTRACT DOCUMENTS. SYSTEM INSTALLER TO PROVIDE AND INSTALL A PLASTIC PROTECTIVE BUSHING, ON EACH CONDUIT STUB-OUT, TO PREVENT CABLE DAMAGE.
		INDICATES THE LOCATION OF A FLOOR MOUNTED TECHNOLOGY OUTLET. ELECTRICAL CONTRACTOR TO PROVIDE AND INSTALL A FLOOR BOX WITH (1) 1" CONDUIT PER EVERY (4) CABLES INSTALLED. ALL CONDUITS SHALL ROUT FROM THE FLOOR BOX, DIRECTLY TO THE IDF SERVING THIS AREA AND STUB-UP IN THE SAME LOCATION AS THE BUILDING SERVICE CONDUITS.
	+	INDICATES THE LOCATION OF A CEILING MOUNTED OUTLET. CONTRACTOR SHALL MOUNT THIS OUTLET AT +12" ABOVE THE CEILING AND COORDINATE ALL FINAL LOCATIONS WITH OTHER TRADES ON THE PROJECT TO VERIFY THAT THE LOCATION OF THE OUTLET MAINTAINS 12" OF CLEARANCE FROM THE FRONT OF THE FACEPLATE FOR OWNER ACCESS. ELECTRICAL CONTRACTOR SHALL ROUTE (1) 1" CONDUIT FROM THE BUILDING STRUCTURE TO A SINGLE GANG BACK BOX MOUNTED AT 5' OR LESS ABOVE THE FINISHED CEILING. SECURE CONDUIT AND BACK BOX TO INSURE MINIMAL SWAY MOVEMENT.
	'D#'	DESIGNATES THAT THE ASSOCIATED TECHNOLOGY OUTLET IS INTENDED FOR THE USE OF A NETWORK CONNECTION. THE '#' SHALL BE REPLACED WITH NUMERIC TEXT THAT IDENTIFIES THE TOTAL NUMBER OF CATEGORY 6, NETWORK CABLES THAT ARE TO BE INSTALLED AT THE TECHNOLOGY OUTLET LOCATION. CONTRACTOR TO PROVIDE AND INSTALL CATEGORY 6, NETWORK CABLES, CATEGORY 6, CONNECTORS, STAINLESS STEEL FACEPLATES WITH IDENTIFICATION WINDOWS, LABELS, BLANK INSERTS, AND ANY OTHER MATERIALS REQUIRED TO FURNISH COMPLETELY FUNCTIONAL AND TESTED OUTLET LOCATION. ALL FACEPLATES PROVIDED SHALL CONTAIN A MINIMUM 4-PORTS AND SHALL BE APPROPRIATELY SIZED TO ACCOMMODATE THE NUMBER OF CIRCUITS BEING INSTALLED AT THIS TECHNOLOGY OUTLET LOCATION.
	'W'	DESIGNATES THAT THE ASSOCIATED TECHNOLOGY OUTLET IS INTENDED FOR THE USE OF A WALL MOUNTED TELEPHONE CONNECTION. CONTRACTOR TO PROVIDE AND INSTALL (1) CATEGORY 6, NETWORK CABLE, (1) CATEGORY 6, CONNECTOR, STAINLESS STEEL WALL TELEPHONE FACEPLATE, LABELS, AND ANY OTHER MATERIALS REQUIRED TO FURNISH A COMPLETELY FUNCTIONAL AND TESTED CIRCUIT AT EACH LOCATION SHOWN. CONTRACTOR SHALL MOUNT THIS OUTLET AT +42" AFF AND COORDINATE ALL FINAL LOCATIONS WITH OTHER TRADES ON THE PROJECT TO VERIFY THAT THE LOCATION OF THE OUTLET MAINTAINS 8" OF CLEARANCE ON ALL FOUR SIDES OF THE BACK BOX. OUTLETS SHALL REMAIN CLEAR OF ROOM DOORS, CABINET DOORS, APPLIANCE DOORS, AND SLIDING DRAWERS.
	'AP'	DESIGNATES THAT THE ASSOCIATED TECHNOLOGY OUTLET IS INTENDED FOR THE USE OF A WIRELESS ACCESS POINT CONNECTION. CONTRACTOR TO PROVIDE AND INSTALL (2) CATEGORY 6A NETWORK CABLES, CONNECTORS, STAINLESS STEEL FACEPLATE WITH IDENTIFICATION WINDOWS, LABELS, AND ANY OTHER MATERIALS REQUIRED TO FURNISH A COMPLETELY FUNCTIONAL AND TESTED CIRCUIT AT EACH LOCATION SHOWN.

PROVIDE (2) 10' PLENUM PATCH CABLE FOR EACH LOCATION

INSTALLED. PATCH CABLE TO BE INSTALLED AND ROUTED BY

JUP		AUDIO/VIDEO LEGEND					
GROUP	SYMBOL	DESCRIPTION					
	'#MP'	INDICATES THE LOCATION OF A VIDEO PROJECTOR # TO BE REPLACED WITH "C" OR "W". "C" INDICATES THAT THE DEVICE IS A CEILING MOUNTED DEVICE AND "W" INDICATES IT IS TO BE WALL MOUNTED. CONTRACTOR TO PROVIDE AND INSTALL ONE (1) CATEGORY 6 DATA CABLE, ALL AUDIO/VIDEO CABLING, AUDIO/VIDEO COMPONENTS AND EQUIPMENT.					
DEVICES	'AV-#'	INDICATES THAT THE DESIGNATED TECHNOLOGY OUTLET IS INTENDED FOR AN AUDIO/VIDEO (A/V) INPUT. CONTRACTOR TO PROVIDE AND INSTALL ONE (1) 1900 BOX WITH TWO (2) 1" CONDUITS ROUTING INTO THE NEAREST, PLENUM ACCESSIBLE CEILING WITHIN THE SAME ROOM. # TO BE REPLACED WITH A ALPHEBETICAL OR NUMERICAL TEXT, IDENTIFYING SPECIFIC INFORMATION ABOUT EACH OUTLET. REFERENCE SPECIFICATION AND SYSTEM DETAILS FOR ADDITIONAL INFORMATION. AV-I - STANDALONE INSTRUCTIONAL SPACE TYPE A/V INPUT					
DEV		PLATE AV-*# - * TO BE REPLACED WITH AN ALPHABETICAL CHARACTER DEPICTING THE AREA IN WHICH THE DEVICE RESIDES. A/V INPUT PLATE # TO BE REPLACED WITH A NUMERIC VALUE DEPICTING THE SPECIFIC PLATE LOCATION ON THE FLOOR PLAN AND THE SYSTEM SCHEMATIC DETAIL.					
	'LED#'	INDICATES THE LOCATION OF A LED VIDEO DISPLAY CONTRACTOR TO PROVIDE AND INSTALL ONE (1) CATEGORY 6, UTP NETWORK CABLE, ONE (1) RG6 QS CABLE, A/V CABLING, AND ALL REQUIRED TERMINATION HARDWARE AS PER THE PROJECT SPECIFICATIONS. # SHALL BE REPLACE WITH NUMERIC VALUE THAT DESIGNATES A SPECIFIC TYPE OF DEVICE. REFERENCE A/V SCHEMATIC AND SPECIFICATION FOR ADDITIONAL INFORMATION.					
	'DS#'	INDICATES THE LOCATION OF A DIGITAL SIGNAGE DISPLAY. CONTRACTOR TO PROVIDE AND INSTALL ONE (1) CATEGORY 6, UTP NETWORK CABLE, AND ALL REQUIRED TERMINATION HARDWARE AS PER THE PROJECT SPECIFICATIONS. # SHALL BE REPLACE WITH NUMERIC VALUE THAT DESIGNATES A SPECIFIC TYPE OF DEVICE. REFERENCE SPECIFICATION FOR ADDITIONAL INFORMATION.					
	'AVC'	INDICATES THE LOCATION OF A TOUCH PANEL A/V CONTROL SURFACE. CONTRACTOR TO PROVIDE AND INSTALL ONE (1) CATEGORY 6, STP NETWORK CABLE, AND ALL REQUIRED TERMINATION HARDWARE TO THE DESIGNATED A/V CABINET AS PER THE PROJECT SPECIFICATIONS. REFERENCE SPECIFICATION FOR ADDITIONAL INFORMATION.					
	'TC'	INDICATES THE LOCATION OF HYDRAPORT 6 MODULE TABLE CONNECTIVITY BOX TO BE INSTALLED IN CONFERENCE TABLE AND CONNECTED TO FLOOR OUTLET VIA PATCH CABLES. CONTRACTOR TO COORDINATE WITH FURNITURE CONTRACTOR AND ARCHITECT PRIOR TO INSTALLATION.					

TECHNOLOGY GENERAL NOTES CONTRACTOR SHALL COORDINATING WITH DBR ENGINEERING PRIOR TO THE INSTALLATION OF RACKS AND RACK EQUIPMENT. NO RACKS SHALL BE PERMANENTLY INSTALLED WITHOUT WRITTEN APPROVAL OF THE PROPOSED LOCATIONS. THE SELECTED, INSTALLING CONTRACTOR MUST BE A CERTIFIED INTEGRATOR/INSTALLER

- AUTHORIZED BY THE SPECIFIED SYSTEM MANUFACTURER TO INSTALL THE CABLE PLANT AND CONNECTIVITY PRODUCTS. REFER TO SPECIFICATIONS FOR PRODUCT TYPE AND 3. SYSTEM WIRING AND EQUIPMENT INSTALLATION SHALL BE IN ACCORDANCE WITH GOOD
- ENGINEERING PRACTICES AS ESTABLISHED BY ANSI/EIA/TIA, BICSI, AND THE NEC.
- 4. ALL WIRING SHALL MEET ALL STATE AND LOCAL ELECTRICAL CODES. 5. ALL TELECOMMUNICATIONS SYSTEMS EQUIPMENT AND MOUNTING LOCATIONS SHALL BE IN
- 6. ALL INDUSTRY STANDARD CATEGORY 6 CABLING PRACTICES MUST BE FOLLOWED FOR ALL DATA CABLING.
- 7. ALL DATA CABLES ARE TO BE INSTALLED WITH A MINIMUM OF 12 INCHES OF SEPARATION FROM AC POWER CABLES, INTERCOM, FIRE ALARM, SECURITY CABLES IN ANY PARALLEL OPEN WIRE RUN.
- 8. ALWAYS CROSS OTHER SYSTEM CABLES AT A 90 DEGREE ANGLE.

COMPLIANCE WITH ADA ACCESSIBILITY STANDARDS.

- 9. ALL CABLES AND TERMINATION COMPONENTS SHALL BE MACHINE LABELED AT BOTH ENDS. LABEL ALL CABLES PER TS DRAWINGS AND/OR SPECIFICATIONS. FINAL CABLE/OUTLET IDENTIFICATION LABELS SHALL BE COORDINATED WITH THE OWNER AND
- 10. CONTRACTOR TO PROVIDE LIGHTNING PROTECTION ON ALL COMMUNICATION CABLE BETWEEN BUILDINGS.
- 11. ALL EXPOSED CABLING ROUTED IN PLENUM SHALL BE PLENUM-RATED. ALL NON PLENUM-RATED CABLING INSTALLED IN PLENUM SPACES SHALL BE INSTALLED IN
- 12. NO TERMINATION OR SPLICES SHALL BE INSTALLED IN OR ABOVE CEILINGS UNLESS NOTED NOTED OTHERWISE.
- 13. CONTRACTOR SHALL MAINTAIN WALL RATING WITH PROPER FIRE BLOCKING METHODS.
- 14. ALL CABLE INSTALLED SHALL ROUTE TO THE CENTER OF THE ROOM IN WHICH IT SERVES AND THEN TO THE OUTLET LOCATION IT IS INTENDED FOR. EACH CABLE SHALL HAVE A 10' SERVICE LOOP AT THE CENTER OF EACH ROOM AND A 3' SERVICE LOOP ABOVE EACH OUTLET LOCATION.
- 15. THE SYSTEM INSTALLER SHALL PROPERLY SUPPORT ALL INSTALLED SYSTEM CABLING FROM A PANDUIT J-MOD CABLE SUPPORT SYSTEMS AS DETAILED IN SPECIFICATIONS. NO CABLING SHALL BE ROUTED AND TIED DIRECTLY TO BUILDING STEEL, CEILING GRID SUPPORT, CONDUIT, PIPING, OR DUCTWORK. PANDUIT J-MOD SUPPORT SYSTEM SHALL BE DIRECTLY CONNECTED TO THE BUILDING'S STEEL JOIST. IN LOCATION WHERE THE BOTTOM OF THE JOIST IS MORE THAN 5' ABOVE THE CEILING. THE SYSTEM INSTALLER SHALL PROVIDE AND INSTALL THREADED ROD AND ALL REQUIRED MATERIALS TO CONNECT THE THREADED ROD TO THE BUILDING STEEL AND THE CABLE SUPPORT SYSTEM TO THE THREADED ROD. CABLE PATHWAY SHALL NOT BE HIGHER THAN 5' ABOVE THE CEILING AT ANY LOCATIONS.
- 16. STRUCTURED CABLING SYSTEM CONTRACTOR SHALL PROVIDE ONE (1) CATEGORY 6 CABLE TO EACH VIDEO SURVEILLANCE CAMERA ON THE ENTIRE PROJÉCT. PROVIDE AN ABOVE CEILING BOX AT EACH AND TERMINATE THE CIRCUIT WITH AN RJ45 INSERT. PROVIDE ONE (1) 20' PLENUM PATCH CABLE AT THE DEVICE END OF EACH LOCATION.
- 17. CONTRACTOR TO PROVIDE AND INSTALL ALL REQUIRED CABLING AND COMPONENTS TO FURNISH TWO (2) ANALOG TELEPHONE CABLES TO THE FIRE ALARM SYSTEM. CONTRACTOR TO COORDINATE WITH THE SYSTEM INSTALLER FOR EXACT LOCATIONS AND TERMINATION INSTRUCTIONS PRIOR TO INSTALLATION.
- 18. CONTRACTOR TO PROVIDE AND INSTALL ALL REQUIRED CABLING AND COMPONENTS TO FURNISH ONE (1) ANALOG TELEPHONE CABLES TO EACH ELEVATOR MACHINE ROOM ON THE PROJECT. CONTRACTOR TO COORDINATE WITH SYSTEM INSTALLERS FOR EXACT LOCATIONS AND TERMINATION INSTRUCTIONS PRIOR TO INSTALLATION.
- 19. CONTRACTOR TO PROVIDE AND INSTALL ALL REQUIRED CABLING AND COMPONENTS TO FURNISH TWO (2) CATEGORY 6 CABLES TO BUILDING AUTOMATION SYSTEM. (1) CABLE SHALL BE INSTALLED AT +18" AFF FOR TECHNICIAN NETWORK CONNECTIVITY AND THE OTHER SHALL PROVIDE CONNECTIVITY TO THE SYSTEM. CONTRACTOR TO COORDINATE WITH SYSTEM INSTALLERS FOR EXACT LOCATIONS AND TERMINATION INSTRUCTIONS PRIOR TO INSTALLATION.
- 20. CONTRACTOR TO PROVIDE AND INSTALL (1) CATEGORY 6 CABLE TO THE BUILDING'S ACCESS CONTROL HEAD END PANEL. TERMINATION OF THIS CABLE SHALL BE COORDINATED WITH THE SYSTEM INSTALLER.
- 21. CONTRACTOR TO PROVIDE AND INSTALL (1) CATEGORY 6 CABLE TO THE BUILDING'S INTRUSION DETECTION CONTROL PANEL. TERMINATION OF THIS CABLE SHALL BE COORDINATED WITH THE SYSTEM INSTALLER.

NOTES TO CONTRACTOR

- EVERY SYMBOL SHOWN ON LEGENDS MAY NOT APPEAR ON DRAWINGS. REFER TO GENERAL ELECTRICAL NOTES FOR WALL-MOUNTED DEVICE MOUNTING HEIGHTS.
- . REFERENCE SPECIFICATIONS FOR MATERIALS AND METHODS.
- . COMPLETE INSTALLATION OF ALL PRODUCTS SHALL BE IN COMPLIANCE WITH ALL CODES, INDUSTRY STANDARDS, COMMON PRACTICES AND MANUFACTURER'S INSTRUCTIONS.
- . ALL EXTERIOR AND WALL MOUNTED CAMERA LOCATIONS AND MOUNTING HEIGHTS MUST BE COORDINATED WITH THE OWNER PRIOR TO ROUGH-IN. COORDINATION MEETINGS SHALL BE SCHEDULED THROUGH THE ARCHITECT'S PROJECT MANAGER.

TYPICAL SUBSCRIPTS LEGEND				
TEXT	DESCRIPTION			
'WM'	INDICATES THAT THE DESIGNATED DEVICE IS TO BE WALL MOUNTED AT SPECIFIED HEIGHT OR IN COMPLIANCE WITH CODE REQUIREMENTS. ALL WALL MOUNTED HEIGHTS ARE TO BE CONFIRMED WITH THE PROJECT'S ARCHITECT PRIOR TO ROUGH-IN.			
'WP'	INDICATES THAT THE DESIGNATED DEVICE SHALL BE WEATHER PROOF AND RATED FOR EXTERIOR CONDITIONS INSTALLATION.			
indicates that the designated device is to be installed a the countertop. A numeric value shall replace the '#' and shall designate the specific height above counter. Heights are to be confirmed with the project's archite to rough-in.				
'AFF'	INDICATES THAT THE DESIGNATED DEVICE IS TO BE INSTALLED ABOVE THE FINISHED FLOOR. A NUMERIC VALUE SHALL REPLACE THE '#' SYMBOL AND SHALL DESIGNATE THE SPECIFIC HEIGHT ABOVE FINISHED FLOOR. ALL HEIGHTS ARE TO BE CONFIRMED WITH THE PROJECT'S ARCHITECT PRIOR TO ROUGH-IN.			
'AG'	INDICATES THAT THE DESIGNATED DEVICE IS TO BE INSTALLED ABOVE THE GRADE LEVEL. A NUMERIC VALUE SHALL REPLACE THE '#' SYMBOL AND SHALL DESIGNATE THE SPECIFIC HEIGHT ABOVE GRADE. ALL HEIGHTS ARE TO BE CONFIRMED WITH THE PROJECT'S ARCHITECT PRIOR TO ROUGH-IN.			
'SM'	INDICATES THAT THE DESIGNATED DEVICE IS TO BE SURFACE MOUNTED. CONTRACTOR TO PROVIDE ALL MATERIALS REQUIRED FOR A COMPLETE, SURFACE MOUNTED SOLUTION. ALL SURFACE MOUNTED PRODUCTS SHALL BE APPROVED BY THE PROJECT'S ARCHITECT PRIOR TO PROCUREMENT AND/OR INSTALLATION.			
'UC'	INDICATES THAT THE DESIGNATED DEVICE IS TO BE MOUNTED ON THE UNDERSIDE OF THE ELEVATED CANOPY.			
'UF'	INDICATES THAT THE DESIGNATED DEVICE IS TO BE INSTALLED UNDER A RAISED FLOOR SYSTEM.			
'CM'	INDICATES THAT THE DESIGNATED DEVICE IS TO BE CORNER MOUNTED AT SPECIFIED HEIGHT. ALL WALL MOUNTED HEIGHTS ARE TO BE CONFIRMED WITH THE PROJECT'S ARCHITECT PRIOR TO ROUGH-IN.			

GENERAL NOTES

- ALL 120V POWER REQUIRED FOR THE FUNCTIONALITY OF EACH SYSTEM SHALL BE A DEDICATED CIRCUIT AND ON EMERGENCY POWER WHEN AVAILABLE. PROJECTS ELECTRICAL CONTRACTOR SHALL BE RESPONSIBLE FOR ALL POWER TO MAIN CONTROL PANELS, REMOTE POWER SUPPLIES AND ALL HEAD END EQUIPMENT. SYSTEM INSTALLERS SHALL COORDINATE LOCATIONS AND CONNECTIONS WITH THE PROJECT'S ELECTRICAL CONTRACTOR.
- THE PROJECT'S ELECTRICAL CONTRACTOR SHALL BE RESPONSIBLE FOR ALL IN CONDUITS, BACK BOXES, JUNCTION BOXES, RACEWAYS, AND SLEEVES REQUIRED TO ESTABLISH CLEAR PATHWAYS FOR ALL SYSTEMS. ALL CONDUITS, SLEEVES, BOXES, AND RACEWAYS SHALL BE PROPERLY SIZED TO MAINTAIN A 40% MAXIMUM FILL RATIO.
- ALL EXPOSED SYSTEM'S WIRING OR WIRING ROUTING ACROSS NON ACCESSIBLE OR OPEN CEILING SPACES SHALL BE ROUTED IN CONDUIT, PROVIDED AND INSTALLED BY THE PROJECT'S ELECTRICAL CONTRACTOR. SIZE CONDUIT AS REQUIRED TO ROUTE SYSTEMS WITH 40% CABLE FILL RATIO. MINIMUM CONDUIT SIZE SHALL BE 3/4".
- . EACH SYSTEM INSTALLER SHALL BE RESPONSIBLE FOR ENSURING ALL EXTERIOR WALL PENETRATIONS ARE PROPERLY SEALED TO PREVENT ANY MOISTURE FROM ENTERING
- . NO CONDUITS SHALL BE INSTALLED ON THE EXTERIOR OF THE BUILDING. IF EXTERIOR CONDUITS ARE REQUIRED FOR A COMPLETE INSTALLATION, EACH SYSTEM CONTRACTOR SHALL COORDINATE WITH THE PROJECTS CONSULTANT PRIOR TO ANY ROUGH-IN.
- 6. EACH SYSTEM INSTALLER SHALL PROVIDE AND INSTALL PROTECTIVE BUSHINGS ON ALL CONDUIT STUB OUTS AND SLEEVES TO PREVENT CABLE DAMAGE. BUSHING TO BE INSTALLED PRIOR TO CABLE INSTALLATION. CUTTING BUSHING AND INSTALLING AFTER CABLE IS INSTALLED WILL NOT BE EXCEPTED.
- ALL CABLE SHALL BE ROUTED DOWN CORRIDORS, PARALLEL AND PERPENDICULAR TO THE BUILDING WALLS AND STRUCTURE. CABLE TO EACH DEVICE SHALL BRANCH OFF OF A MAIN CORRIDOR TRUNK. ROUTING CABLES THROUGH CLASSROOMS, OFFICES, STORAGE ROOMS, RESTROOMS OR ANY TYPE OF ROOM OTHER THAN A CORRIDOR WILL NOT BE ACCEPTED. ENTER ALL ROOMS ABOVE THE ASSOCIATED ROOM DOORWAY.

GROUP	VIDEO SURVEILLANCE LEGEND					
8	SYMBOL	DESCRIPTION				
	•4	INTERIOR VIDEO SURVEILLANCE CAMERA.				
		VANDAL RESISTANT, WEATHER PROOF, EXTERIOR SECURITY CAMERA.				
DEVICES	VRS	VIDEO RECORDING SERVER. REFERENCE SPECIFICATIONS FOR INFORMATION CONCERNING ANALOG OR IP BASED TYPE SYSTEM.				
🗖	NOTES:					
	1. REFERENCE VIDEO SURVEILLANCE SCHEDULE, DIVISION 8 AND DIVISION 28					

SPECIFICATIONS FOR ADDITIONAL INFORMATION AND REQUIREMENTS

GROUP	ACCESS CONTROL LEGEND						
<u> </u>	SYMBOL	DESCRIPTION					
	HCR	WALL OR MULLION MOUNTED ACCESS CONTROL PROXIMITY CARD READER.					
	œ	ACCESS CONTROL PROXIMITY CARD READER THAT IS INTEGRATED INTO THE DOOR HARDWARE.					
	DR	DOOR RELEASE BUTTON					
	PIR	MOTION REQUEST TO EXIT DEVICE					
	ACP	DESIGNATES THE LOCATION OF THE ACCESS CONTROL SYSTEM, CONTROL PANEL. ELECTRICAL CONTRACTOR TO PROVIDE 120V. POWER TO PANEL. PROVIDE NETWORK CABLE TO PANEL AND COORDINATE WITH THE OWNER'S TECHNOLOGY DEPARTMENT ON ACQUIRING AN IP ADDRESS.					
DEVICES	HDS	WALL OR MULLION MOUNTED, 2-WAY AUDIO/VIDEO INTERCOM DOOR STATION.					
	6 9	DOOR MOUNTED, 2-WAY AUDIO/VIDEO INTERCOM DOOR STATION.					
	MS	2-WAY AUDIO/VIDEO INTERCOM MASTER STATION.					
	岬	ADA AUTO DOOR OPEN BUTTON. SHOWN FOR REFERENCE ONLY, BUTTON AND AUTO DOOR OPERATOR PROVIDED AND INSTALLED BY THE DOOR SYSTEM INSTALLER.					
	DO	AUTO DOOR OPERATOR. OPERATOR TO BE PROVIDED AND INSTALLED BY THE DOOR SYSTEM INSTALLER.					
	NOTES: 1. REFERENCE ACCESS CONTROL SCHEDULE, DIVISION 8 AND DIVISION 28 SPECIFICATIONS FOR ADDITIONAL INFORMATION AND REQUIREMENTS						

GROUP	INTRUSION DETECTION LEGEND					
<u>E</u>	SYMBOL	DESCRIPTION				
	IDP	DESIGNATES THE LOCATION OF THE INTRUSION DETECTION SYSTEM, CONTROL PANEL, ELECTRICAL CONTRACTOR TO PROVIDE 120V POWER TO PANEL				
	8	FLUSH MOUNTED MAGNETIC DOOR CONTACT.				
	SDC	SURFACE MOUNTED MAGNETIC DOOR CONTACT.				
	ODC	OVERHEAD DOOR, SURFACE MOUNTED DOOR CONTACT.				
ဌ	KP	INTRUSION DETECTION SYSTEM ARM/DISARM KEYPAD.				
DEVICES	®	STANDARD RANGE WALL MOUNTED MOTION DETECTOR.				
] ک	∭	MEDIUM RANGE WALL MOUNTED MOTION DETECTOR.				
	$\emptyset\!$	LONG RANGE WALL MOUNTED MOTION DETECTOR.				
Ī	\overline{\overline{\pi}}	CEILING MOUNTED, 360° MOTION DETECTOR.				
	R	RELAY/MONITOR MODULE				
	DB	DURESS BUTTON				
	WSR	WIRELESS SECURITY RECEIVER				
	NOTES:					
	REFERENCE INTRUSION DETECTION SCHEDULE, DIVISION 8 AND DIVISION SPECIFICATIONS FOR ADDITIONAL INFORMATION AND REQUIREMENTS					

SECURITY GENERAL NOTES

- 1. THE SECURITY CAMERA SYSTEM INSTALLER SHALL BE RESPONSIBLE FOR CONNECTING ALL APPLICABLE SYSTEM EQUIPMENT TO THE OWNER'S NETWORK.
- 2. THE SYSTEM INSTALLER SHALL PROPERLY SUPPORT ALL INSTALLED SYSTEM CABLING FROM AN APPROVED CABLE SUPPORT SYSTEM AS DETAILED IN SPECIFICATIONS. NO CABLING SHALL BE ROUTED AND TIED DIRECTLY TO BUILDING STEEL, CEILING GRID SUPPORT, CONDUIT, PIPING, OR DUCTWORK. THE CABLE SUPPORT SYSTEM SHALL BE DIRECTLY CONNECTED TO THE BUILDING'S STEEL JOIST. AT LOCATIONS WHERE THE BOTTOM OF THE JOIST IS MORE THAN 5' ABOVE THE CEILING, THE SYSTEM INSTALLER SHALL PROVIDE AND INSTALL THREADED ROD AND ALL REQUIRED MATERIALS TO CONNECT THE THREADED ROD TO THE BUILDING STEEL AND THE CABLE SUPPORT SYSTEM TO THE THREADED ROD. CABLE PATHWAY SHALL NOT BE HIGHER THAN 5' ABOVE THE CEILING AT ANY LOCATIONS.
- SECURITY CAMERA SYSTEM INSTALLER SHALL PROVIDE A CEILING MOUNTED INSTALLATION KIT RECOMMENDED BY THE MANUFACTURER OF THE CAMERA. EACH CEILING MOUNTED CAMERA KIT SHALL HAVE A SUPPORT WIRE ATTACHED TO THE BUILDING'S STRUCTURE TO PREVENT THE CAMERA FROM DROPPING TO THE FLOOR AT ANY TIME. AT NO POINT SHALL THE WEIGHT OF THE CEILING MOUNTED SECURITY CAMERA BE SUPPORTED BY THE CEILING GRID SYSTEM OR CEILING TILES. ALL CEILING MOUNTED CAMERAS SHALL BE
- 4. ALL EXTERIOR AND WALL MOUNTED CAMERA LOCATIONS AND MOUNTING HEIGHTS MUST BE COORDINATED WITH THE OWNER PRIOR TO ROUGH-IN. COORDINATION MEETINGS SHALL BE SCHEDULED THROUGH THE ARCHITECT'S PROJECT MANAGER.

FLUSH MOUNTED.

- PROVIDE AND INSTALL MAGNETIC DOOR CONTACT AT ALL ROOF HATCHES ON THE ENTIRE PROJECT. CONTACTS TO BE CONNECTED TO THE BUILDINGS INTRUSION DETECTION
- 6. CONTRACTOR TO PROVIDE AND INSTALL A MONITOR RELAY AND ALL REQUIRED MATERIALS TO CONNECT THE RELAY TO THE FREEZER/COOLER TEMPERATURE GAUGE AND BACK TO THE INTRUSION DETECTION SYSTEM, THE INTRUSION DETECTION SYSTEM SHALL BE PROGRAMMED TO NOTIFY THE OWNER'S DESIGNATED PERSONNEL IN THE EVENT OF EXTENSIVE CHANGE IN TEMPERATURE.

JT MG JB TL --

TECHNICAL SYSTEMS - NOTES AND LEGEND

Corpus Christi, Texas 78401

American Bank Plaza 711 N. Carancahua, Suite 404

Phone: 361.884.7442

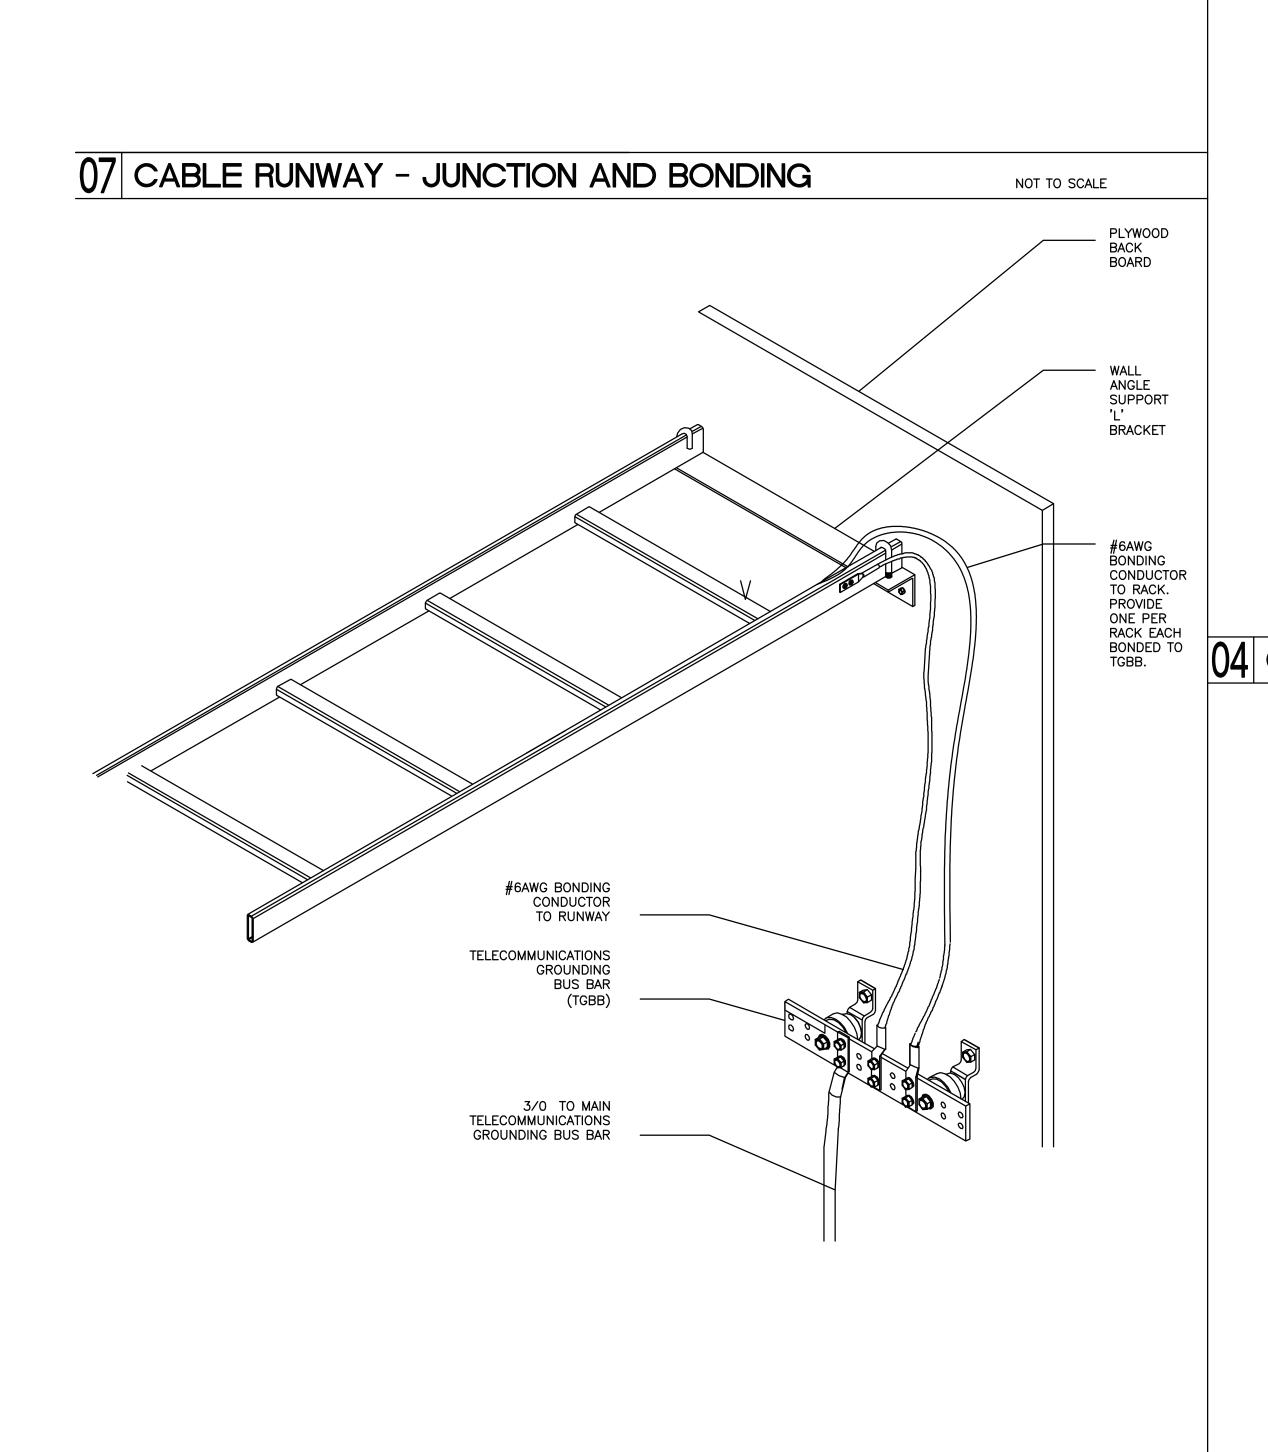
Fax: 361.883.1612

www.lwarchitects.com

JEFFREY D. TABB



CLOSET IDENTIFICATION EACH PATCH PANEL PORT SHALL BE LABELED WITH THE STATION PORT NUMBER AND THE ROOM NUMBER IT _ FIBER OPTIC ENCLOSURE SERVES. (IN THIS CASE, PORTS 1-6 ARE SERVING CABLES 1 THRU 6 IN ROOM #806) COORDINATE ROOM NUMBERS WITH FINAL GRAPHICS PACKAGE ROOM NUMBERS AND NOT CONSECUTION PLAN ROOM NUMBERS. — PANEL IDENTIFICATION
(PANEL 'C' WOULD INDICATE
THE 3RD PATCH PANEL IN CLOSET IDENTIFICATION (IN THIS CASE, THE LABEL INDICATES IDF CLOSET #1. THE MDF SHALL BE 1. PATCH PANEL PORT LABELING SHALL BE MACHINE THE COMMUNICATION GENERATED AND SHALL NOT BE LESS THEN 1/4" IN LABELED 'MDF') 2. PATCH PANEL AND CLOSET IDENTIFICATION LABEL SHALL BE MACHINE GENERATED AND SHALL NOT BE LESS THEN 1/2" IN HEIGHT. 3. COORDINATE EXACT LABELING SCHEME WITH OWNER AND ENGINEER 05 FIBER ENCLOSURE/ COPPER PATCH PANEL LABELING DETAIL NOT TO SCALE



06 TR - GROUNDING AND BONDING

CONTIGUOUS SECTIONS OF CABLE


RUNWAY SHALL BE BONDED USING

#6AWG BONDING CONDUCTOR (TYP)

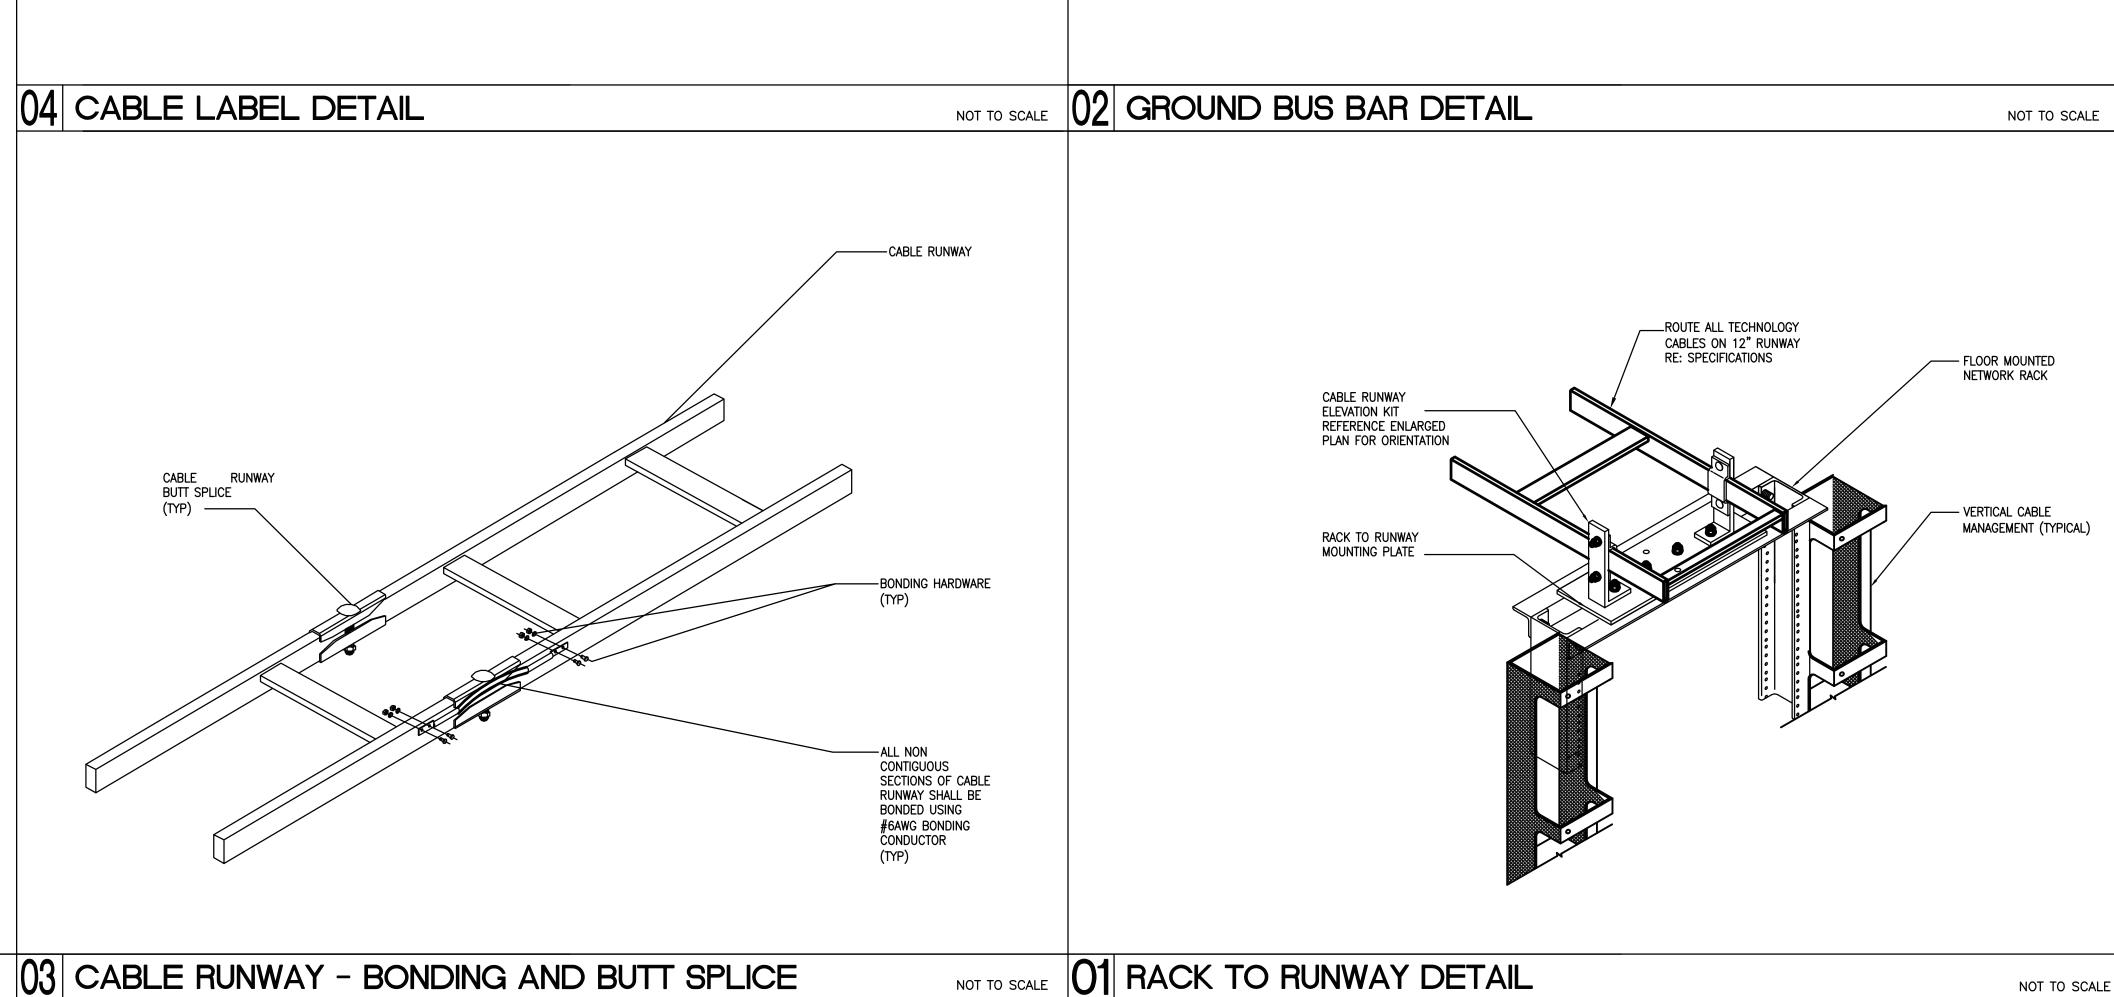JUNCTION FITTING AT

DEGREE MEETINGS OF CABLE RUNWAY (TYP)

NOT TO SCALE



TECHNICAL SYSTEMS DETAIL - TECHNOLOGY AND A/V
NOT TO SCALE

ROOM NUMBER. (COORDINATE WITH FINAL GRAPHICS – PACKAGE, NOT CONSTRUCTION NUMBERS)

IDF IDENTIFICATION-PANEL IDENTIFICATION-PORT IDENTIFICATION

WRAP AROUND CABLE LABEL TO BE INSTALLED AT

BOTH THE WORK AREA OUTLET AND CLOSET ENDS OF ALL CABLES. INSTALL LABEL 1" FROM THE END OF THE CABLE JACKET AT BOTH ENDS.

2. CABLE LABELING SHALL BE MACHINE GENERATED AND SHALL NOT BE LESS THEN 1/8" IN HEIGHT.

3. COORDINATE EXACT LABELING SCHEME WITH OWNER AND ENGINEER

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DBR Project Number

EXOTHERMICALLY WELD

REVISION: SHEET NUMBER **T500** ELECTRICAL DETAILS AND SCHEDULES SET NO.

07/09/2018



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ADMINISTRATION BU

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KEYPLAN

07/09/2018 DBR

JOB NO: REVISION: SHEET NUMBER T501 ELECTRICAL DETAILS AND

SCHEDULES


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JOB NO: REVISION: SHEET NUMBER **TS101** LEVEL 1 TECHNOLOGY & SECURITY DEMO ___PLAN___ SET NO.

361.888.5797 p TBPE Firm Registration No. 2234 189005.000 JT MG JB TL --

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TS101 LEVEL 1 TECHNOLOGY DEMO PLAN

1/8" = 1'-0"

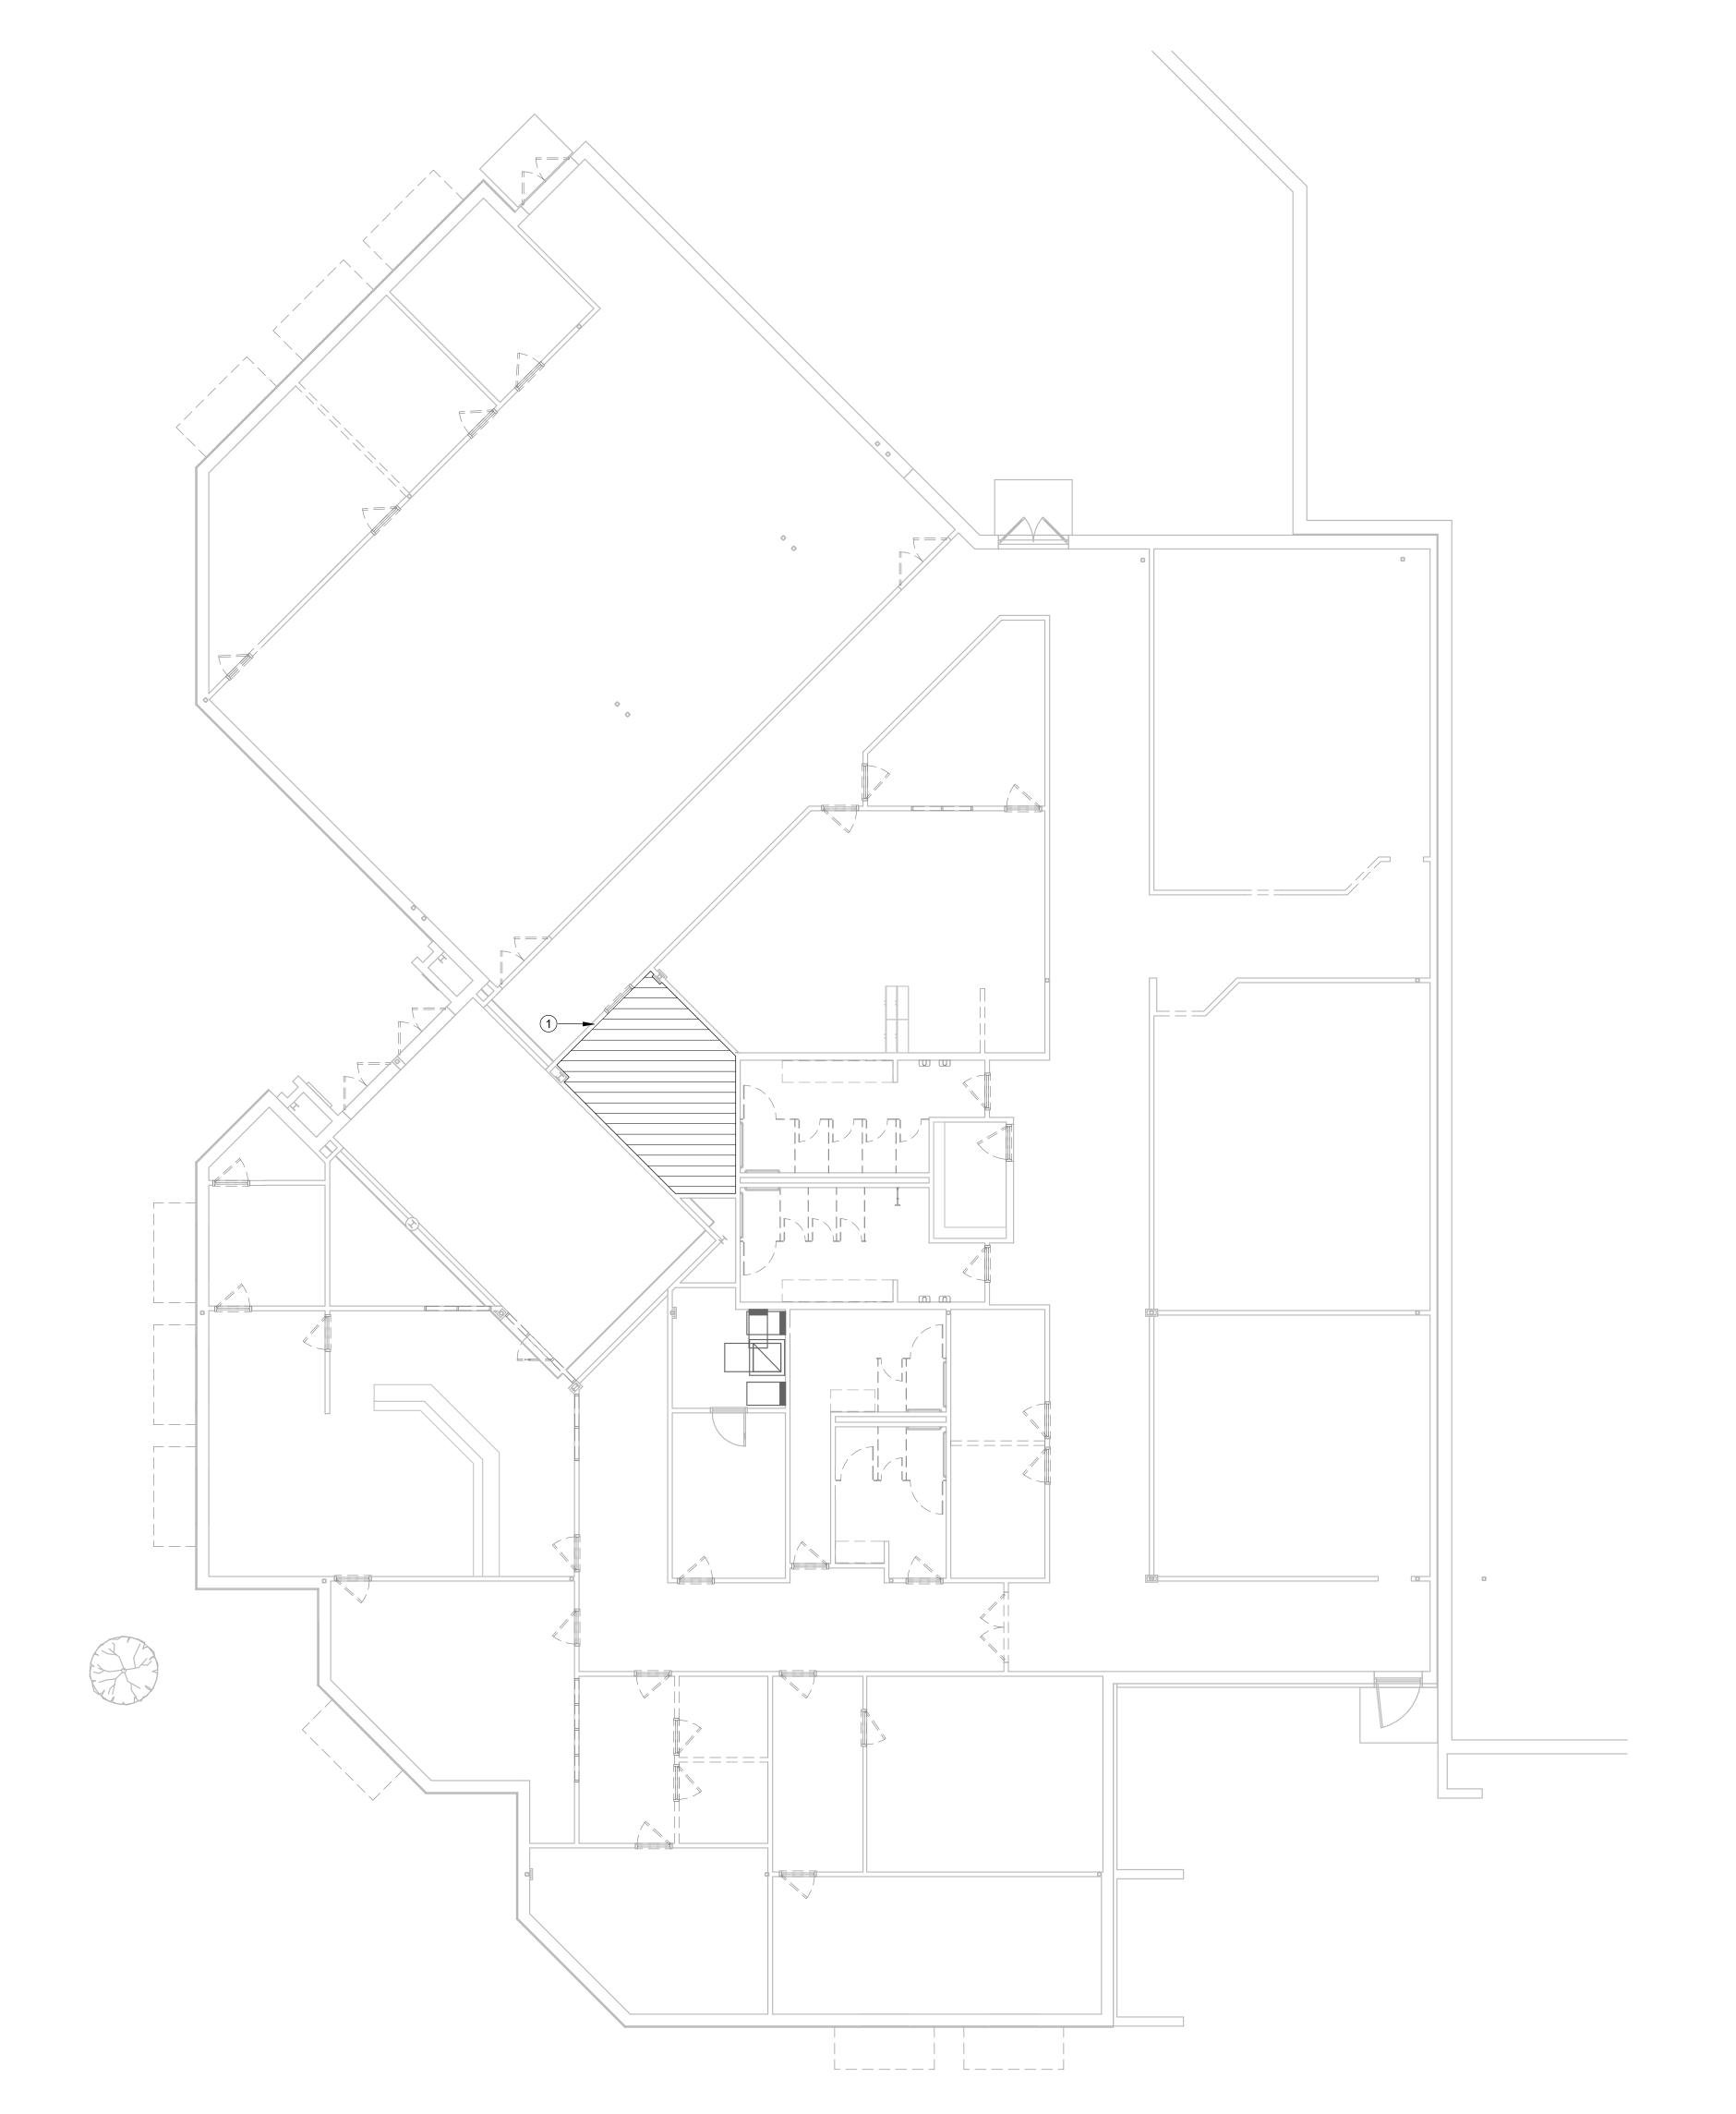TECHNOLOGY DEMOLITION KEYED NOTES:

1. ALL WORK AREA STRUCTURED CABLING FEEDING THIS AREA OF WORK

EQUIPMENT THAT THE OWNER DOES NOT CLAIM SHALL BE DISPOSED OF.

ORIGINATES IN THIS ROOM AND SHALL BE REMOVED IN ITS ENTIRETY FROM END

TO END. COORDINATE ANY OUTAGES AND REMOVAL WITH OWNER, ARCHITECT, AND CONSULTANT (O.A.C.) TEAM PRIOR TO DEMOLITION. IF ANY STATION OR

WORK AREA CABLING ORIGINATING IN THIS ROOM FEEDS AREAS THAT ARE NOT

SHOWN ON THIS PLAN, CONTRACTOR SHALL LEAVE CABLE IN PLACE AND NOTIFY O.A.C. TEAM. THE OWNER SHALL BE GIVEN FIRST RIGHT OF REFUSAL FOR ANY

EXISTING RACKS AND TELECOMMUNICATIONS EQUIPMENT TO BE REMOVED. ANY

ARCHITECTS

711 N. Carancahua, Suite 404

Corpus Christi, Texas 78401

American Bank Plaza

Phone: 361.884.7442

Fax: 361.883.1612

www.lwarchitects.com

KEYPLAN

American Bank Plaza 711 N. Carancahua, Suite 404 Corpus Christi, Texas 78401

Phone: 361.884.7442

Fax: 361.883.1612

www.lwarchitects.com

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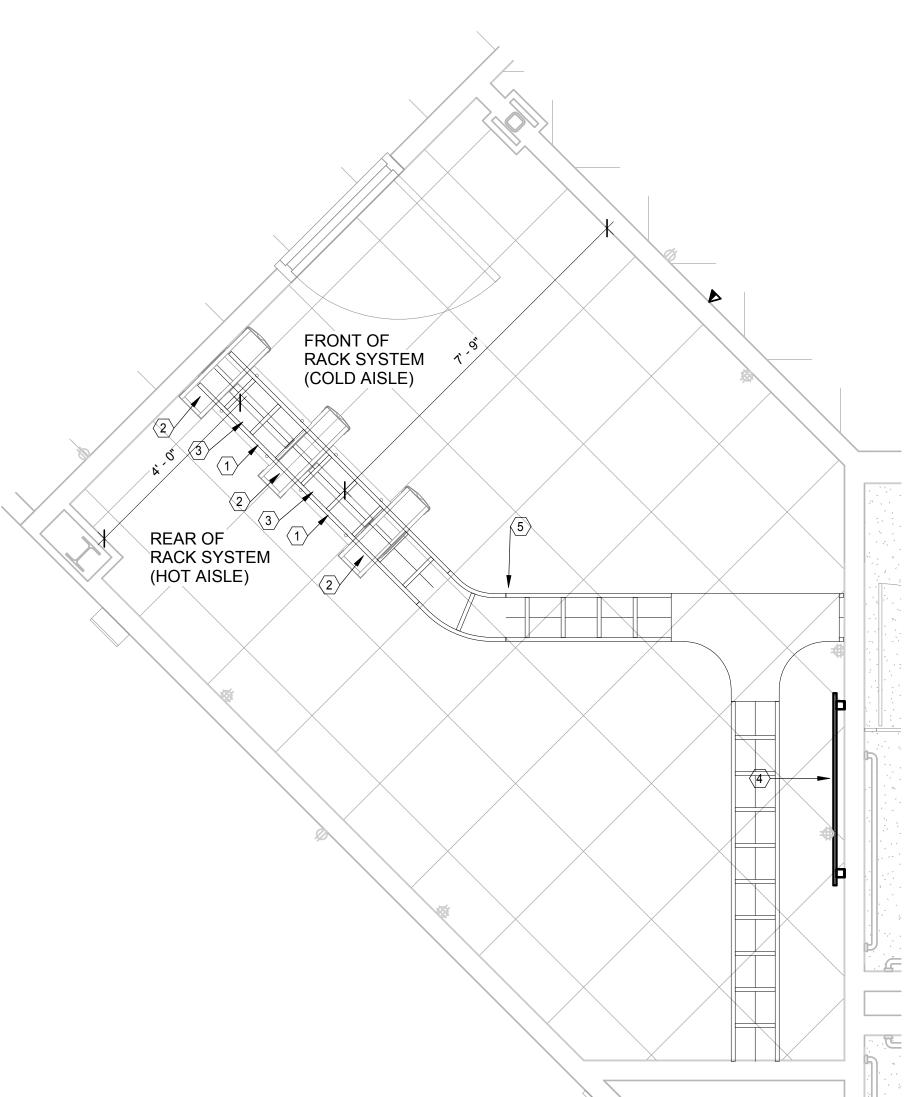
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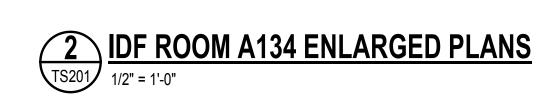
ENLARGED PLAN GENERAL NOTES


- ALL RACK LOCATIONS SHALL BE COORDINATED WITH THE OWNER'S REPRESENTATIVE PRIOR TO INSTALLATION.
- PATCH PANEL QUANTITY SHALL BE DETERMINED BY STATION CABLE DROP COUNTS SHOWN ON TS PLANS AND THE ASSOCIATED PROJECT MATRIX. ENSURE PATCH PANEL QUANTITY IS SUFFICIENT TO SUPPORT THE NUMBER OF PORTS REQUIRED BY TS PLANS PLUS AN ADDITIONAL 25% FOR FUTURE
- CONTRACTOR SHALL NOT MOUNT EXCEED MORE THAN A 50% RACK FILL RATIO ON ANY RACK.
- REFERENCE SPECIFICATIONS FOR MATERIALS AND METHODS
- ALL RACKS, LADDER TRAYS, LIGHTNING PROTECTION ENCLOSURES AND ANY OTHER DEVICES, PART OF THE STRUCTURED CABLING SYSTEM, SHALL BE GROUNDED TO A GROUND BUS BAR LOCATED IN THE TELECOMMUNICATIONS ROOM WITH A #6AWG GROUND CABLE. DAISY CHAINING WILL NOT BE ACCEPTED. ALL ITEMS SHALL HAVE A DEDICATED GROUND CABLE TO BUS BAR. GROUND CABLE SHALL BE GREEN IN

ENLARGED PLAN KEYED NOTES

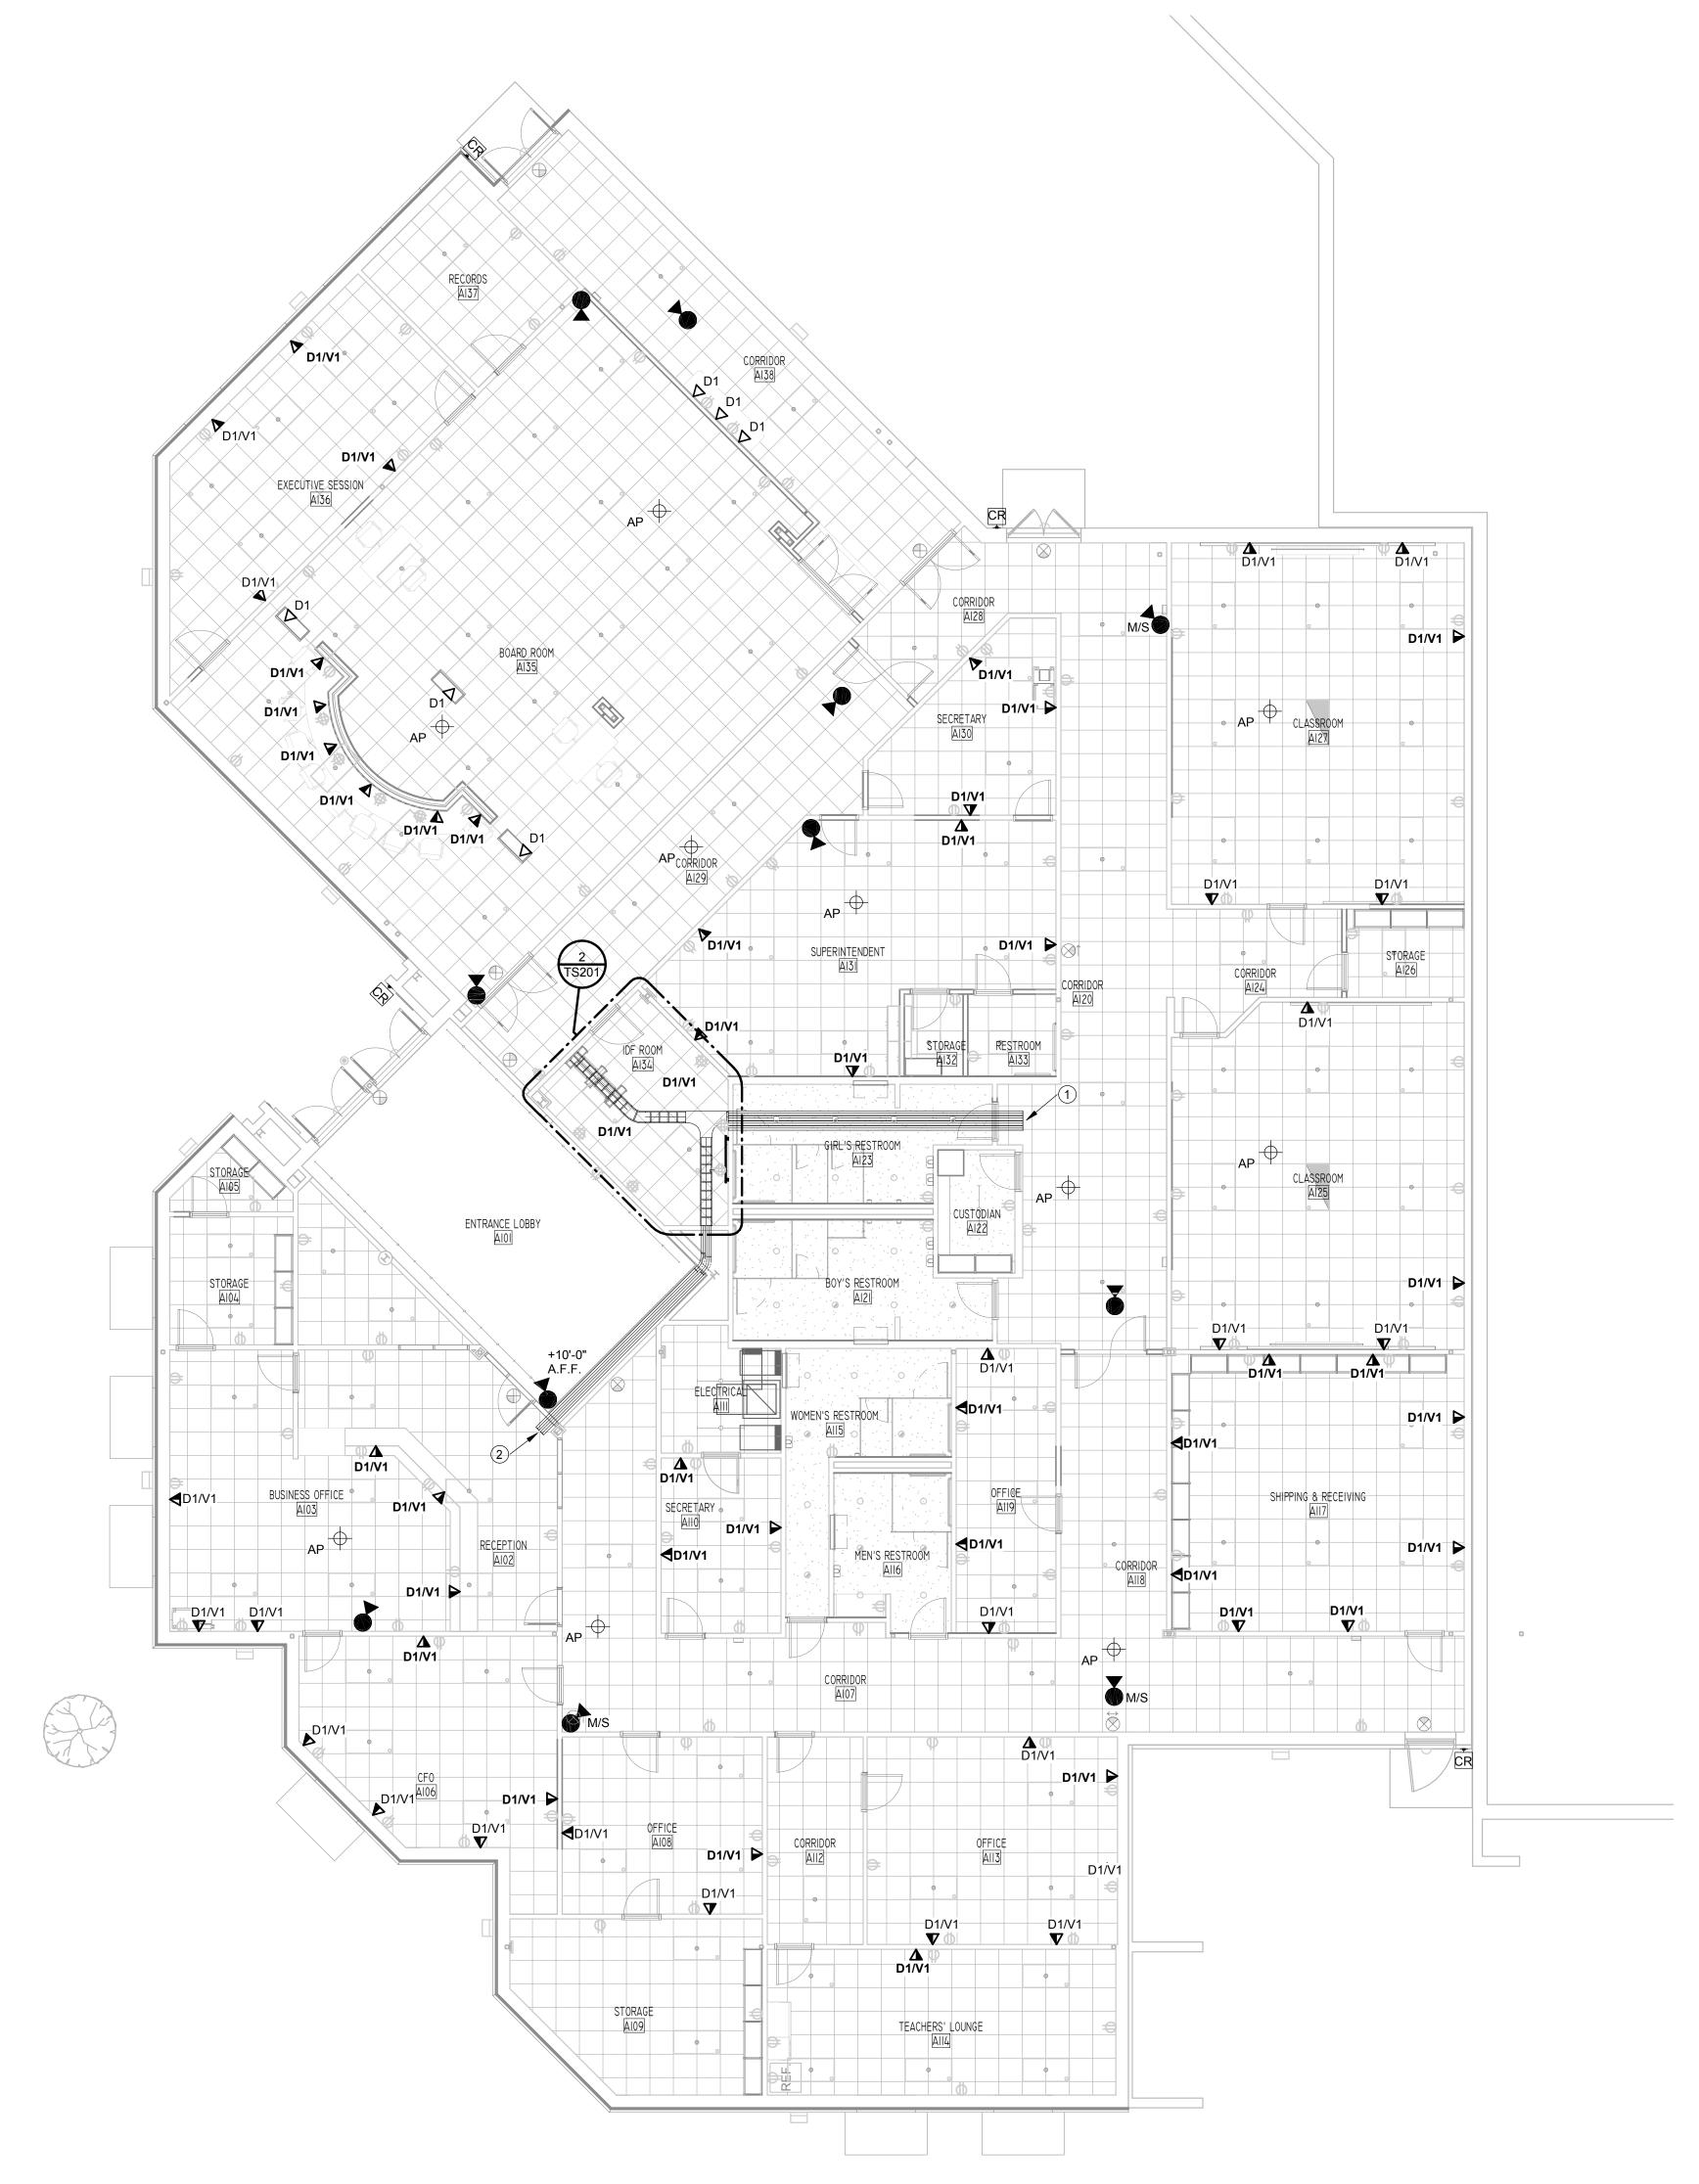- 1. PROVIDE AND INSTALL (1) 2-POST, FLOOR MOUNTED RELAY RACK.
- PROVIDE AND INSTALL (1) 7'X6" FRONT AND REAR MANAGED, VERTICAL CABLE MANAGER AT THIS
- PROVIDE AND INSTALL RACL-TO-RUNWAY MOUNTING PLATE FOR ALL LOCATIONS WHEN ASSOCIATED WITH A 2-POST OR 4-POST RACK. RACK SHALL BE BLACK IN COLOR. PROVIDE (1) 6" LADDER TRAY ELEVATION KIT AT EACH RACK-TO-RUNWAY MOUNTING PLATE LOCATION.
- PLYWOOD BACK BOARD.
- 5. PROVIDE OVERHEAD CABLE TRAY.







TECHNOLOGY GENERAL NOTES

- REFER TO SPECIFICATIONS FOR MATERIALS AND METHODS.
- REFER TO ELECTRICAL PLANS FOR ADDITIONAL INFORMATION. REFER TO TECHNICAL SYSTEMS OVERALL PLANS FOR EXTERIOR CAMERAS AND ADDITIONAL INFORMATION.
- REFER TO TECHNOLOGY NOTES AND LEGEND, TECHNICAL SYSTEMS DETAILS, TECHNICAL SYSTEMS SCHEDULES AND SPECIFICATIONS FOR EXTERIOR CAMERAS AND ADDITIONAL INFORMATION. EACH CEILING 'D3/AP' TECHNOLOGY OUTLET, LOCATED IN CLASSROOMS, LABS, AND GROUP INSTRUCTIONAL SPACES: ARE DESIGNATED AS FOLLOWS:
- -IP INTERCOM SPEAKER (1 CATEGORY CABLE WHITE IN COLOR) -CEILING MOUNT PROJECTOR (1 CATEGORY CABLE) -MEDIA GATEWAY (1 CATEGORY CABLE)

-WIRELESS ACCESS POINT (1 CATEGORY CABLE)

ALL EXISTING SYSTEMS SHALL BE FULLY TESTED FOR FUNCTIONALITY PRIOR TO THE COMMENCEMENT OF DEMOLITION. THE FUNCTIONALITY OF ALL DEVICES SHALL BE DOCUMENTED AND REPORTED PRIOR TO REMOVAL. ITEMS NOT FUNCTIONING, AND WERE NOT REPORTED TO NON-FUNCTIONAL/NOT PROPERLY FUNCTIONING SHALL BE REPLACED AT NO COST TO THE OWNER OR THE

PROJECT. REPAIR AND/OR REPLACEMENT SHALL BE THE RESPONSIBILITY OF THE CONTRACTOR

- ALL EXISTING CEILING MOUNTED DEVICES SHALL BE REMOVED DURING CONSTRUCTION, ALLOWING FOR COMPLETE REMOVAL OF THE EXISTING CEILING. CONTRACTOR TO DOCUMENT DEVICE
- LOCATION AND INSTALL EACH DEVICE AT THE LOCATION IT WAS REMOVED FROM. CONTRACTOR SHALL BEAR ALL RESPONSIBILITY IN MAINTAINING THE INTEGRITY OF ALL EXISTING
- SYSTEM CABLE THAT IS TO REMAIN ALL EXISTING DEVICES, THAT ARE TO BE REMOVED AND REINSTALLED, SHALL BE REINSTALLED IN THE EXISTING LOCATION, UNLESS THE EXISTING AREA IS BEING COMPLETELY RENOVATED. REFERENCE FLOOR PLAN OF THE RENOVATED AREAS FOR NEW DEVICE LOCATION CONTRACTOR SHALL PROVIDE A ONE (1) YEAR PARTS AND LABOR WARRANTY ON ALL NEW
- DEVICES AND EXISTING DEVICES BEING REUSED. ALL EXISTING EXTERIOR VIDEO SURVEILLANCE CAMERAS ARE EXISTING TO REMAIN, UNLESS NOTED OTHERWISE. CONTRACTOR TO FIELD VERIFY ALL LOCATIONS AND TAKE ALL MEASURES REQUIRED TO MAINTAIN THE INTEGRITY AND FUNCTIONALITY OF ALL CAMERAS, CABLE, AND ASSOCIATED HARDWARE.
- ALL EXISTING ACCESS CONTROL, VIDEO SURVEILLANCE, AND INTRUSION DETECTION DEVICES TO BE INSTALLED IN THE SAME, ORIGINAL LOCATIONS. RECONNECT TO SYSTEM AND RE-CERTIFIED FOR PROPER FUNCTIONALITY.
- REFERENCE TECHNOLOGY DEMOLITION PLANS FOR LOCATIONS OF EXISTING CAMERAS, CARD READERS, LOCAL SOUND SYSTEMS, INTRUSION DETECTION DEVICES, WIRELESS ACCESS POINTS, WALL MOUNTED TELEPHONES, AND CEILING MOUNTED PROJECTORS THAT ARE TO REMAIN, BE RELOCATED, OR BE REMOVED IN THEIR ENTIRETY

***** TECHNOLOGY KEYED NOTES

- PROVIDE FOUR (4) 4" CONDUITS FROM IDF TO CEILING PLENUM. CONDUITS WILL SERVE AS DISTRIBUTION PATHWAYS FOR STRUCTURE CABLING SYSTEM.
- PROVIDE TWO (2) 4" CONDUITS FROM IDF TO CEILING PLENUM. CONDUITS WILL SERVE AS DISTRIBUTION PATHWAYS FOR STRUCTURE CABLING SYSTEM.

TS201 LEVEL 1 TECHNOLOGY PLAN
1/8" = 1'-0"



TBPE Firm Registration No. 2234

JT MG JB TL --

JOB NO: REVISION: SHEET NUMBER

> **TS201** LEVEL 1 TECHNOLOGY & SECURITY PLAN

> > SET NO.

MISCELLANEOUS

HOSE BIBB

WALL HYDRANT

PLUMBING FIXTURES

POINT OF NEW CONNECTION TO EXISTING PIPING

PLUMBING DRAWING NOTE REFERENCE

SHEET WHERE DETAIL OR PLAN IS SHOWN

PLUMBING RISER DIAGRAM NUMBER

FIRE DEPARTMENT SIAMESE CONNECTION(WALL MOUNTED)

FIRE DEPARTMENT SIAMESE CONNECTION(FREE STANDING)

SHEET WHERE PLUMBING RISER DIAGRAM IS SHOWN

DETAIL NUMBER OR PLAN

FLOW SWITCH

TAMPER SWITCH

FIRE HOSE CABINET

JOB NO: REVISION: SHEET NUMBER PLUMBING

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PLUMBING SYMBOLS AND ABBREVIATIONS

(NOT ALL ITEMS INDICATED APPLY TO THIS PROJECT)

		(NOT ALL ITEN	MS INDICATED APPLY TO THIS PROJECT)	
A	ABBREVIATIONS	U	SYMBOLS DIDING FITTINGS	
A AIR (COMPRESSED) ABV ABOVE AC ABOVE CEILING AD ACCESS DOOR, AREA DRAIN ADJ ADJUSTABLE AFF ABOVE FINISHED FLOOR AFG ABOVE FINISHED GRADE AHU AIR HANDLING UNIT AL ALUMINUM	F FARENHEIT, FIRE FBO FURNISHED BY OTHERS FCO FLOOR CLEAN OUT FCS FLOOR CONTROL STATON FD FLOOR DRAIN, FIRE DAMPER FDSC FIRE DEPARTMENT SIAMESE CONNECTION FDV FIRE DEPARTMENT VALVE FH FIRE HYDRANT FHC FIRE HOSE CABINET	N.C. NORMALLY CLOSED NFPA NATIONAL FIRE PROTECTION ASSOCIATION NIC NOT IN CONTRACT N.O. NORMALLY OPEN NO. NUMBER NTS NOT TO SCALE	U URINAL UCD UNDER CUT DOOR UG UNDERGROUND UH UNIT HEATER UL UNDERWRITERS LABORATORIES, INC. UNO UNLESS NOTED OTHERWISE U/F UNDERFLOOR U/S UNDERSLAB	PIPING FITTINGS CAP ON END OF PIPE ELBOW UP ELBOW DOWN VALVE IN DROP
AP ACCESS PANEL ARCH ARCH ARCHITECT, ARCHITECTURAL AS AIR SEPARATOR ASME AMERICAN SOCIETY OF MECHANICAL ENGINEERS ASTM AMERICAN SOCIETY OF TESTING AND MATERIALS AV ACID VENT AVG AVERAGE AW ACID WASTE AWS AMERICAN WELDING SOCIETY AUX AUXILIARY	FHR FIRE HOSE RACK FIXT FIXTURE FLEX FLEXIBLE FL FLOW LINES FLR FLOOR FP FIRE PUMP FRZR FREEZER FS FLOW SWITCH, FIRE SPRINKLER FSK FLOOR SINK FT FOOT, FEET FUT FUTURE	OC ON CENTER OD OUTSIDE DIAMETER, OVERFLOW DRAIN OFCU OUTSIDE AIR FAN COIL UNIT OPG OPENING OS&Y OPEN STEM AND YOLK O MEDICAL OXYGEN P P P P PUMP, PLUMBING EQUIPTMENT PC PLUMBING CONTRACTOR PD PRESSURE DROP, PLANTER DRAIN	V VOLT, VENT VAC VACUUM(MEDICAL) VB VALVE BOX, VACUUM BREAKER VCP VITRIFIED CLAY PIPE VEL VELOCITY VERT VERTICAL VIB VALVE IN BOX VOV VALVE ON VERTICAL VP VACUUM PUMP VTR VENT THRU ROOF	→ VALVE IN RISE DIRECTION OF FLOW DIRECTION OF SLOPE DOWN CONCENTRIC REDUCER ECCENTRIC REDUCER TEE OUTLET UP TEE OUTLET DOWN UNION FLANGE
B BOILER BC BELOW COUNTER B/C BACK OF CURB BF BELOW FLOOR BFV BUTTERFLY VALVE BH BOX HYDRANT BLDG BUILDING BM BENCHMARK BOF BOTTOM OF FOOTING BOS BOTTOM OF STRUCTURE BT BATH TUB BTU BRITISH THERMAL UNIT BV BALL VALVE	G GAS GA GAUGE GAL GALLON GALV GALVANIZED GC GENERAL CONTRACTOR GLV GLOBE VALVE GND GROUND GPD GALLONS PER DAY GPH GALLONS PER HOUR GPM GALLONS PER MINUTE GV GATE VALVE	PH PHASE, POST HYDRANT PIV POST INDICATOR VALVE PLBG PLUMBING PNEU PNEUMATIC PNL PANEL PNTH PENTHOUSE PP POLYPROPYLENE PPM PART PER MILLION PRI PRIMARY PRS PRESSURE REDUCING STATION PRV PRESSURE REDUCING VALVE PSF POUNDS PER SQUARE FOOT PSI POUNDS PER SQUARE INCH PSIG POUNDS PER SQUARE INCH PSIG POUNDS PER SQUARE INCH GAUGE PT PLUMBING TRIM PV PLUG VALVE PVC POLYVINYL CHLORIDE	W WATT, WASTE, WIDTH, WASHER W/ WITH W/O WITHOUT WC WATER CLOSET WCO WALL CLEANOUT WH WALL HYDRANT WHA WATER HAMMER ARRESTOR WM WATER METER WP WEATHERPROOF WPD WATER PRESSURE DROP WWF WELDED WIRE FABRIC WT WATERTIGHT, WEIGHT	PIPE ANCHOR EXPANSION JOINT STRAINER WITH BLOWDOWN VALVE GATE VALVE, HVAC BALANCING/STOP VALVE GLOBE VALVE BALL VALVE BALL VALVE BALANCING VALVE WITH DIFFERENTIAL PRESSURE TAPS OS&Y VALVE
BWV BACK WATER VALVE	H	Q QTY QUANTITY	Y YARD HYDRANT	CHECK VALVE BUTTERFLY VALVE
C CELSIUS CAB CABINET CB CATCH BASIN CD CONDENSATE DRAIN LINE CFM CUBIC FEET PER MINUTE CFS CUBIC FEET PER SECOND CH CHILLER CP CIRCULATING PUMP CI CAST IRON CIRC CIRCULATING CL CENTERLINE CLG CEILING	HB HOSE BIBB HD HEAD, HUB DRAIN HORIZ HORIZONTAL HP HORSEPOWER HKP HOUSEKEEPING PAD HSC HORIZONTAL SPLIT CASE HT HEIGHT HTG HEATING HTR HEATER HW HOT WATER HWR HOT WATER RETURN HWS HOT WATER SUPPLY HZ HERTZ	RCP REFLECTED CEILING PLAN, REINFORCED CONCRETE PIPE RD ROOF DRAIN RE REFERENCE, REFER RECIRC RECIRCULATE RED REDUCER REFR REFRIGERATOR REINF REININGFORCING REQD REQUIRED	Z Z ZONE SYMBOLS PLUMBING SYSTEMS ———————————————————————————————————	TWO-WAY MODULATING CONTROL VALVE THREE-WAY MODULATING CONTROL VALVE SOLENOID VALVE PRESSURE REDUCING VALVE GAS REGULATOR GAS COCK SPRINKLER FLOOR CONTROL STATION MANUAL AIR VENT
CLR CLEAR CMU CONCRETE MASONRY UNIT CPI CAST IRON PIPE INSTITUTE CPVC CHLORINATED POLYVINYL CHLORIDE CO CLEAN OUT COL COLUMN COMB COMBINATION COMP COMPRESSOR CONC CONCRETE, CONCENTRIC CONN CONNECTION CONT CONTINOUS, CONTINUATION CONTR CONTROLLER, CONTRACTOR CRAC COMPUTER ROOM A/C UNIT	ID INSIDE DIAMETER IE INVERT ELEVATION IN INCH INSUL INSULATION INT INTERNAL, INTERIOR IW INDIRECT WASTE	REV REVISION, REVISE RM ROOM RPM REVOLUTIONS PER MINUTE RTU ROOFTOP UNIT RV RELIEF VALVE	SANITARY DRAIN ABOVE FLOOR SANITARY VENT GREASE WASTE(ABOVE CEILING) GREASE WASTE(BELOW FLOOR) SD STORM DRAIN(ABOVE CEILING) STORM DRAIN(BELOW FLOOR)	AUTOMATIC AIR VENT T&P RELIEF VALVE LINE CLEANOUT/ WALL CLEANOUT FLOOR CLEANOUT YARD CLEANOUT PRESSURE GAUGE WITH GAUGE COCK
CTR CENTER CU COPPER CW COLD WATER	JP JOCKEY PUMP	SCHED SCHEDULED SD STORM DRAIN SE SEWAGE EJECTOR SEC SECONDARY SECT SECTION SF SQUARE FEET	OVERFLOW DRAIN(ABOVE CEILING) OVERFLOW DRAIN(BELOW FLOOR) ACID WASTE(ABOVE CEILING) ACID WASTE(BELOW FLOOR)	THERMOMETER WATER METER FLEXIBLE CONNECTION
D DEPTH, DRAIN, DRYER DESIG DESIGNATION DTL DETAIL DF DRINKING FOUNTAIN DIA DIAMETER DIM DIMENSION DISC DISCONNECT DN DOWN DS DOWNSPOUT, DOUBLE SUCTON DW DISHWASHER DWG DRAWING DWH DOMESTIC WATER HEATER DWP DOMESTIC WATER PUMP	KEC KITCHEN EQUIPTMENT CONTRACTOR KO KNOCKOUT KVA KILOVOLT AMPS KW KILOWATT L L L L L LENGTH, LAVATORY LAV LINEAR FEET	SFCS SPRINKLER FLOOR CONTROL STATION SH SHOWER SHT SHEET SIM SIMILAR SK SINK SP SUMP PUMP, STATIC PRESSURE SPEC SPECIFICATION SPR SPRINKLER SQ SQUARE SS SERVICE SINK SSD SUBSURFACE DRAIN SSFU SANITARY SEWER FIXTURE UNITS STD STANDARD	AV	PRESSURE AND TEMPERATURE TAP FLOW VENTURI VACUUM BREAKER VACUUM RELIEF VALVE BACKFLOW PREVENTOR CIRCULATING PUMP
EA EACH EC ELECTRICAL CONTRACTOR ECC ECCENTRIC EDF ELECTRIC DRINKING FOUNTAIN EFF EFFICIENCY EJ EXPANSION JOINT EL ELEVATION ELEC ELECTRICAL ELEV ELEVATOR EMERG EMERGENCY	LF LINEAR FEET LP LOW PRESSURE LRA LOCKED ROTOR AMPS LVL LEVEL LWCO LOW WATER CUT OFF MAX MAXIMUM MBTUH THOUSAND OF BTU'S MC MECHANICAL CONTRACTOR	STL STEEL STR STRAINER SURF SURFACE SUSP SUSPEND SV SANITARY VENT SW SOFT WATER	CA COMPRESSED AIR MEDICAL AIR MEDICAL OXYGEN V MEDICAL VACUUM F FIRE STANDPIPE, FIRE LINE FS WET AUTOMATIC FIRE SPRINKLER TP TRAP PRIMER	DRAIN(TYPE AND SIZE AS NOTED ON PLANS) ROOF DRAIN OR OVERFLOW DRAIN ROOF DRAIN OR OVERFLOW DRAIN(FROM ABOVE) WATER HAMMER ARRESTOR
EMERG EMERGENCY ENCL ENCLOSURE ENGR ENGINEER EQ EQUAL EQUIP EQUIPTMENT ET EXPANSION TANK ETR EXISTING TO REMAIN EXT EXTERNAL EXTG EXISTING	MC MECHANICAL CONTRACTOR MECH MECHANICAL MFR MANUFACTURER MH MANHOLE MI MALLEABLE IRON MIN MINIMUM MP MEDIUM PRESSURE MS MOP SINK MTD MOUNTED MU MAKE-UP	TD TRENCH DRAIN TDH TOTAL DYNAMIC HEAD TH BLK THRUST BLOCK TP TRAP PRIMER TPD TRAP PRIMER DEVICE TYP TYPICAL	DRAIN LINE SW—SOFT WATER	

DBR Project Number 189005.000 JT MG JB TL --

P101 LEVEL 1 PLUMBING DEMO PLAN
1/8" = 1'-0"

- (A) SIZES AND LOCATION OF EXISTING PIPINGS SHOWN WERE TAKEN FROM ENGINEERING PLANS FROM WHICH EXISTING SYSTEMS WERE INSTALLED. CONTRACTOR NEED TO FIELD VERIFY EXACT SIZES, CONDITIONS AND LOCATIONS OF INDICATED EXISTING UTILITIES.
- (B) ALL FIXTURES, EQUIPMENT AND PLUMBING LINES SHOWN WITH (E) ARE EXISTING TO REMAIN. UNLESS NOTED OTHERWISE.
- THE CONTRACTOR IS FULLY RESPONSIBLE FOR PERFORMING ALL WORK UNDER THIS SECTION OF THE PROJECT IN FULL COMPLIANCE WITH ALL APPLICABLE LOCAL, STATE AND FEDERAL CODES INCLUDING THOSE PUBLISHED BY OSHA AND EPA.
- (D) THE EXTENT OF DEMOLITION WORK IS INDICATED ON THE ARCHITECTURAL DRAWINGS AND BY THE REQUIREMENTS OF THIS SECTION. A VISIT TO THE SITE WILL BE REQUIRED PRIOR TO BIDDING. CONTRACTOR SHALL IDENTIFY/VERIFY ALL PLUMBING LINES BEFORE STARTING ANY DEMOLITION
- (E) CUTTING OF CONCRETE FLOORS SHALL BE BY MACHINE SAW, HOLES FOR PIPES (WALL OR FLOOR) SHALL BE DONE WITH CORE DRILLING EQUIPMENT WITH PRIOR APPROVAL FROM THE STRUCTURAL ENGINEERS. PATCH AND SEAL OPENINGS AS REQUIRED. COORDINATE ALL CUTTING AND PATCHING
- F ALL EXISTING PLUMBING FIXTURES AND EQUIPMENT REMOVED DURING CONSTRUCTION THAT ARE NOT TO BE REUSED SHALL BE REMOVED FROM THE JOB SITE AND PROPERLY RETURNED TO THE OWNER, IF DESIRED BY
- PROVIDE ALL WORK REQUIRED FOR THE REMOVAL OF FIXTURES TO BE DEMOLISHED AND INSTALLATION OF NEW FIXTURES AND ASSOCIATED SERVICES TO PROVIDE A COMPLETE AND OPERABLE SYSTEM UPON COMPLETION OF THE PROJECT.
- DOCUMENTS IN ADDITION TO THE MECHANICAL AND ELECTRICAL DOCUMENTS TO DETERMINE THE COMPLETE SCOPE OF WORK.
- $\langle \mathsf{I} \rangle$ COORDINATE DEMOLITION OF PLUMBING SYSTEMS AS REQUIRED WITH ALL OTHER TRADES.

(H) PLUMBING CONTRACTOR SHALL BE RESPONSIBLE TO REVIEW THE ARCH'L

PLUMBING DEMO KEYED NOTES:

WITH OTHER TRADES.

- 1 DEMOLISH EXISTING FIXTURE/S INCLUDING ALL ASSOCIATED TRIMS AND PLUMBING LINES. CAP DRAIN LINE BELOW SLAB, CAP VENT AND DOMESTIC WATER LINES UP TO LAST ACTIVE SOURCE.
- 2 DEMOLISH EXISTING FIXTURE AND REWORK/ADJUST EXISTING PLUMBING LINES FOR SERVICE TO NEW FIXTURE. RE: E/P2.01.
- DEMOLISH EXISTING FIXTURE/S, PREPARE EXISTING ROUGH-INS FOR NEW FIXTURE IN THE SAME LOCATION, REWORK/ADJUST TO MEET TAS REQUIREMENT IF NEEDED.
- 4 DEMOLISH EXISTING ELECTRCI WATER HEATER, A NEW WALL HUNG UNIT WILL BE INSTALLED. RE: 1/P2.01.

ARCHITECTS

American Bank Plaza 711 N. Carancahua, Suite 404 Corpus Christi, Texas 78401 Phone: 361.884.7442 Fax: 361.883.1612



JOB NO:

REVISION: SHEET NUMBER

P101 LEVEL 1 PLUMBING DEMO PLAN

SET NO.

Corpus Christi, Tx 78401 361.888.5797 p TBPE Firm Registration No. 2234

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FIRE PROTECTION NOTES:

A PROVIDE WET PIPE SPRINKLER FIRE SUPPRESSION SYSTEM THROUGHOUT AREAS OF RENOVATION. CONNECT TO EXISTING SPRINKLER SYSTEM AT ADJACENT BUILDING. SITE VISIT IS REQUIRED

PRIOR TO BIDDING TO DETERMINE FULL SCOPE OF WORK.

- B PROVIDE FIRE ALARM SYSTEM AS REQUIRED BY LOCAL, STATE OR FEDERAL CODES TO RECEIVE CERTIFICATE OF OCCUPANCY FOR THE PROJECT.
- PROVIDE AND INSTALL SURFACE MOUNTED FIRE EXTINGUISHERS. TYPE AND QUANTITY AND LOCATIONS SHALL BE AS PER LOCAL AUTHORITIES.
- CONTRACTOR IS RESPONSIBLE FOR TESTING AND INSPECTING EXISTING SYSTEM AND INSURE THAT ALL COMPONENTS ARE FULLY
- (E) THE DESIGN AND INSTALLATION SHALL BE IN ACCORDANCE WITH NFPA 13, AND NFPA 24 AND ALL LOCAL CODES. SUBMIT SHOP DRAWINGS AND CALCULATIONS AS SPECIFIED.
- F PRIOR TO SHUT-DOWN OF ANY EXISTING FIRE PROTECTION SYSTEM, CONTRACTOR SHALL NOTIFY OWNER OR OWNER'S APPOINTED REPRESENTATIVE 24 HOURS PRIOR TO SERVICE INTERRUPTION. CONTRACTOR SHALL BE RESPONSIBLE FOR RESTORING SYSTEM TO FULL OPERATION.

GENERAL NOTES:

- SIZES AND LOCATION OF EXISTING PIPINGS SHOWN WERE TAKEN FROM ENGINEERING PLANS FROM WHICH EXISTING SYSTEMS WERE INSTALLED. CONTRACTOR NEED TO FIELD VERIFY EXACT SIZES, CONDITIONS AND LOCATIONS OF INDICATED EXISTING UTILITIES.
- (B) ALL FIXTURES, EQUIPMENT AND PLUMBING LINES SHOWN WITH (E) ARE EXISTING TO REMAIN. UNLESS NOTED OTHERWISE.
- THE CONTRACTOR IS FULLY RESPONSIBLE FOR PERFORMING ALL WORK UNDER THIS SECTION OF THE PROJECT IN FULL COMPLIANCE WITH ALL APPLICABLE LOCAL, STATE AND FEDERAL CODES INCLUDING THOSE PUBLISHED BY OSHA AND EPA.
- CUTTING OF CONCRETE FLOORS SHALL BE BY MACHINE SAW, HOLES FOR PIPES (WALL OR FLOOR) SHALL BE DONE WITH CORE DRILLING EQUIPMENT WITH PRIOR APPROVAL FROM THE STRUCTURAL ENGINEERS. PATCH AND SEAL OPENINGS AS REQUIRED. COORDINATE ALL CUTTING AND PATCHING WITH OTHER TRADES.
- PLUMBING CONTRACTOR SHALL BE RESPONSIBLE TO REVIEW THE ARCH'L DOCUMENTS IN ADDITION TO THE MECHANICAL AND ELECTRICAL DOCUMENTS TO DETERMINE THE COMPLETE SCOPE OF WORK.

PLUMBING KEYED NOTES:

ALONG THE CEILING TILE.

- POINT OF CONNECTION TO EXISTING UTILITY. FIELD VERIFY EXACT LOCATIONS OF EXISTING UTILITIES.
- (2) ELECTRIC WATER HEATER WITH RECIRCULATION SYSTEM, SEE DETAIL
- 3 3/4" HOT WATER RETURN DROP TO CIRCULATING PUMP WITH TIMER SWITCH AND AQUASTAT; SEE DETAIL 2/P401.
- VALVE (TMV-1).

 5 INSTALL NEW PLUMBING FIXTURE/S AND CONNECT TO EXISTING/REWORKED/ADJUSTED ROUGH-INS. PROVIDE NEW TRIMS AND ACCESSORIES (CARRIERS, FLEX CONNECTION, STOPS, P-TRAPS, WAX
- RING, INSULATION).

 (6) 3/4" HW DROP FOR SERVICE TO LAVATORY/S. RUN RECIRCULATING LINE

PROVIDE LAVATORY/SINK WITH POINT OF USE THERMOSTATIC MIXING

- WITHIN 2 FEET OF HW ROUGH-IN FOR 2015 IECC COMPLIANCE.

 7 PROVIDE FLOOR DRAIN WITH TRAP GUARD SEWER GAS EMISSION
- PROTECTION.

 8 BALL VALVE ABOVE CEILING. PROVIDE ACCESS PANEL WHERE LOCATED IN AN INACCESSIBLE CEILING. PANEL SHALL BE 12"X12" PAINTED TO MATCH CEILING. PROVIDE MARKING OF VALVE LOCATION (EXISTING AND NEW)
- (9) WATER HAMMER ARRESTOR, SIZE AS NOTED. PROVIDE PROPERLY SIZED WATER HAMMER ARRESTOR FOR EACH GROUP OF FIXTURES WHETHER SHOWN OR NOT ON PLANS.
- APPROXIMATE LOCATION OF EXISTING GAS METER. CONTRACTOR TO BE RESPONSIBLE FOR ALL COST/FEES ASSOCIATED WITH GAS SERVICE. COORDINATE WITH GAS COMPANY AND VERIFY IF EXISTING GAS SERVICE CAN HANDLE ADDED LOAD OF 575 CFH. VERIFY IF NEW/ADDITIONAL METER IS NEEDED.



JT MG JB TL --

DATE: 05/22/2018
DWG BY: DBR
CKD BY: DBR
JOB NO: 1706
REVISION:
SHEET NUMBER

P201
LEVEL 1 PLUMBING

KEYPLAN

SET NO.

PLAN

Phone: 361.884.7442
Fax: 361.883.1612

www.lwarchitects.com

JEFFREY D. TABB

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ADI PE

ARCHITECTS

American Bank Plaza 711 N. Carancahua, Suite 404 Corpus Christi, Texas 78401

PLUMBING GENERAL PLAN NOTES:

- ALL PIPE PASSING THROUGH FIRE RATED WALLS OR FLOOR SLABS SHALL BE SUPPORTED AT PENETRATION AND OPENINGS SHALL BE SEALED WITH APPROVED, NON-HARDENING, FIRE STOP MATERIALS AS SPECIFIED OR REQUIRED.
- (B) CONTRACTOR SHALL COORDINATE WITH THE STRUCTURAL CONDITIONS AT THE SITE AND PROVIDE PROPER ROUGH-IN CONNECTIONS REQUIRED WITHOUT DAMAGE TO STRUCTURE. WHERE STRUCTURAL MODIFICATIONS ARE NECESSARY, CONTRACTOR SHALL FIRST RECEIVE WRITTEN APPROVAL OF THE ARCHITECT AND STRUCTURAL ENGINEER.
- THIS CONTRACTOR SHALL BE RESPONSIBLE FOR FIELD COORDINATING LOCATIONS AND ELEVATIONS OF ALL PLUMBING PIPING WITH OTHER TRADES PRIOR TO INSTALLATION. CORRECTIONS OR RELOCATIONS DUE TO MISALIGNED PIPE SHALL BE PERFORMED IN A TIMELY MANNER AT NO ADDITIONAL COST TO OWNER.
- DO NOT SCALE THE PLUMBING DRAWINGS FOR ROUGH-IN WORK. CONTRACTOR SHALL REFER TO THE DIMENSIONED ARCHITECTURAL AND STRUCTURAL DRAWINGS TO FIELD DETERMINE EXACT LOCATIONS OF PLUMBING ROUGH-IN WORK.
- E SANITARY DRAINAGE PIPING 2" AND SMALLER SHALL HAVE A UNIFORM MINIMUM CONTINUOUS SLOPE OF 1/4 INCH PER FOOT OF RUN. DRAINAGE PIPING OF 3" SIZE AND LARGER SHALL SLOPE MINIMUM 1/8 INCH
- PROVIDE AND INSTALL CLEANOUTS AT EACH CHANGE OF DIRECTION OF THE BUILDING SANITARY DRAIN, AT MINIMUM 75' INTERVALS ALONG STRAIGHT RUNS OF MAIN DRAIN AND BRANCHES, AT EACH HORIZONTAL CHANGE OF DIRECTION IN SOIL OR WASTE PIPES GREATER THAN 45 DEGREES, AT END OF INDIVIDUAL BRANCH DRAINS LONGER THAN 5'. PROVIDE CLEANOUTS IN ACCORD WITH INTERNATIONAL PLUMBING CODE.

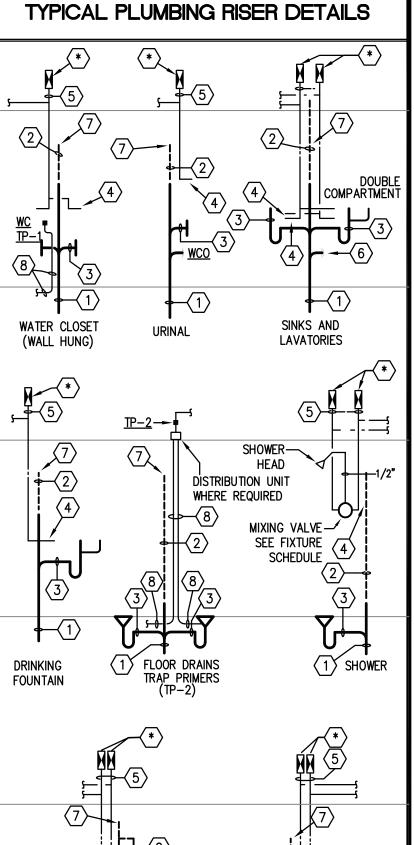
PER FOOT OF RUN. SLOPE ALL VENT PIPING MINIMUM 6" PER 100 FEET OF RUN BACK TO DRAIN.

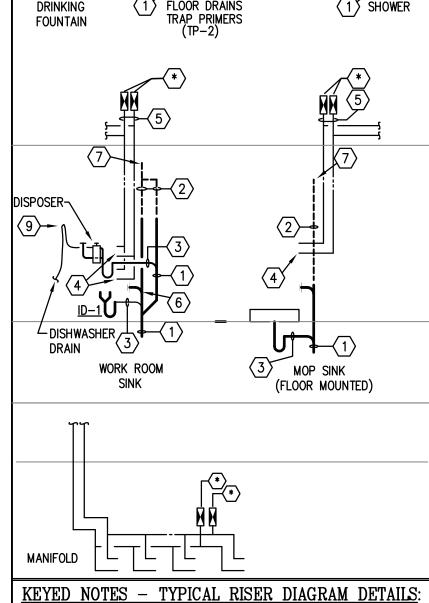
- G PROVIDE FITTINGS FOR SANITARY DRAIN WASTE AND VENT PIPING SYSTEMS IN COMPLIANCE WITH INTERNATIONAL PLUMBING CODE.
- H INSTALL EACH WATER HEATER AND ALL PLUMBING EQUIPMENT WITH ADEQUATE CLEARANCES FOR ACCESS BY SERVICE PERSONNEL AND WITH PROPER ORIENTATION FOR ELEMENT REMOVALS/REPLACEMENTS.
- PROVIDE ISOLATION VALVES FOR <u>ALL</u> BRANCHES OFF DOMESTIC WATER MAINS. ALL PLUMBING SYSTEM VALVES SHALL BE INSTALLED IN ACCESSIBLE CEILING SPACES. WHERE CEILING IS NOT ACCESSIBLE, OR SPACE IS CONFLICTING, VALVES SHALL BE INSTALLED IN PARTITIONS OR PIPE CHASES. PROVIDE APPROVED PAINTED STEEL HINGED ACCESS PANELS IN LOCATIONS PRE-APPROVED BY THE ARCHITECT. PROVIDE STAINLESS STEEL ACCESS DOORS FOR SHOWER, LOCKER AND LOCKER TOILET ROOM PANELS. PROVIDE MARKINGS ON CEILING TILES ON LOCATIONS OF ISOLATION VALVES.
- THIS CONTRACTOR SHALL BE RESPONSIBLE FOR FIELD COORDINATING LOCATIONS OF ALL SANITARY VENTS UP THROUGH ROOF TO MAINTAIN MINIMUM 15' CLEARANCE TO ANY BUILDING OUTDOOR AIR INLET.

GENERAL NOTES - PLUMBING FIXTURES

- MOUNTING HEIGHT ELEVATION OF ALL WALL HUNG OR COUNTER MOUNTED FIXTURES SHALL BE COORDINATED WITH ARCHITECTURAL DRAWINGS PRIOR TO INSTALLATION OF ROUGH-IN WORK.
- FOR ALL FIXTURES AND EQUIPMENT WITH ASSOCIATED TRIM OR COMPONENT ACCESSORIES PROVIDED UNDER SEPARATE DIVISIONS AND REQUIRING PLUMBING CONNECTIONS; THIS CONTRACTOR SHALL FIELD COORDINATE EXACT REQUIREMENTS OF, MAKE PROVISIONS FOR, AND SUPPLY ALL MATERIALS AND LABOR FOR MAKING FINAL CONNECTIONS.
- CONTRACTOR SHALL REFER TO SHOP DRAWINGS OF EQUIPMENT TO BE SUPPLIED FOR FINAL COORDINATION OF ALL ROUGH-IN OPENINGS BEFORE BEGINNING WORK.
- 5. ALL FIXTURE AND EQUIPMENT STUB-OUTS SHALL BE PROVIDED WITH A STOP VALVE. ALL FIXTURE STOPS SHALL BE SOLID BRASS, LOOSE KEY OPERATED, CHROME PLATED (WHERE EXPOSED), AND FITTED TIGHT TO CHROME PLATED BRASS WALL ESCUTCHEON PLATES. SUPPLY RISERS SHALL BE STAINLESS STEEL FLEXIBLE CONNECTORS.
- 6. ALL P-TRAPS WITHIN THE BUILDING, ABOVE GRADE AND EXPOSED TO INSPECTION SHALL BE C.P. ADJUSTABLE, CAST BRASS WITH CLEANOUT PLUG. PROVIDE CAST BRASS SLIP NUTS AND WASHERS, 17 GAGE SEAMLESS TUBULAR BRASS DRAIN TO WALL AND WALL FLANGE. PROVIDE McGUIRE No. 8872C, 1-1/4" P-TRAP FOR ALL LAVATORIES AND SIMILAR FIXTURES PROVIDE McGUIRE No. 8912C, 1-1/2" P-TRAP FOR ALL SINKS AND SIMILAR FIXTURES.
- 7. PROVIDE DEEP SEAL P-TRAP FOR ALL DRAINS OF INFREQUENT USE OR REQUIRING TRAP PRIMER.

 8. ALL ROUGH IN OPENINGS SHALL BE FITTED WITH CHROME PLATED, WROUGHT BRASS DEEP BELL OF THE PLATE OF THE BLOCK FOR THE WALL STEEL ESCURIOR.
- 8. ALL ROUGH IN OPENINGS SHALL BE FITTED WITH CHROME PLATED, WROUGHT BRASS DEEP BELL OR BOX ESCUTCHEON PLATES FITTED TIGHT TO THE PIPE AND FLUSH TO THE WALL. STEEL ESCUTCHEON PLATES ARE NOT ACCEPTED.
- 9. ALL EXPOSED BRASS SHALL BE CHROME PLATED.
- 10. ALL HANDICAPPED ACCESSIBLE FIXTURES INDICATED WITH SHALL BE PROVIDED OF APPROVED TYPES AND WITH REQUIRED CONTROLS AND INSTALLED TO HEIGHTS AND CLEARANCES, AS PRESCRIBED BY AMERICANS WITH DISABILITIES ACT (ADA). FIXTURES SHALL COMPLY WITH ALL FEDERAL, STATE, AND LOCAL ACCESSIBILITY CODE REQUIREMENTS. REFER TO ARCHITECTURAL DRAWINGS FOR DIMENSIONED MOUNTING HEIGHTS AND SPECIFIED CLEARANCE REQUIREMENTS. PROVIDE FIXTURES WITH DEPTHS AT MAXIMUM PERMITTED AND AVAILABLE FOR INTENDED FIXTURE
- 11. ALL WHEELCHAIR LAVATORY AND SINK PIPING WHERE EXPOSED SHALL BE INSULATED. PROVIDE OFFSET DRAIN FITTINGS WHERE REQUIRED TO PROVIDE MINIMUM CLEARANCES.
- 12. ALL SINKS FOR HANDICAPPED USE SHALL BE STAMPED WITH DRAIN OUTLET AT REAR OF BOWL.
- 13. PLUMBING FIXTURES SHALL BE OF WATER CONSERVATION TYPE IN ACCORDANCE WITH PLUMBING CODE REQUIREMENTS FOR WATER SAVING PERFORMANCE.
- 14. ORIENT ADA WATER CLOSET FLUSH VALVE WITH OPERATOR ON WIDE SIDE OF ENCLOSURE.
- 15. SEAL ALL SPACES BETWEEN PLUMBING FIXTURES AND MOUNTING SURFACES WITH WHITE LATEX CAULK WIPED SMOOTH AND FLUSH WITH FIXTURE.
- 16. FLOOR DRAINS SHALL BE INSTALLED AT LOW POINTS OF UNIFORMLY SLOPED FLOOR. CONTRACTOR SHALL FIELD COORDINATE WITH STRUCTURAL TO INSURE FLOORS ARE SLOPED UNIFORMLY ACROSS ENTIRE TOILET ROOMS OR OVER AS WIDE AN AREA AS PRACTICAL FOR OPEN AREA FLOOR DRAINS. CONVEX FLOOR SLOPE IN THE IMMEDIATE VICINITY OF THE FLOOR DRAIN IS NOT ACCEPTABLE.





- <u>EYED NOTES TYPICAL RISER DIAGRAM DETAILS</u>
 (NOT ALL RISERS USED IN EVERY PROJECT.)
- REFER TO PLUMBING FIXTURE SCHEDULE FOR SOIL OR WASTE ROUGH—IN PIPE SIZE. MINIMUM SOIL OR WASTE DRAIN LINE SIZE (EXCEPT AS NOTED) FOR THIS FIXTURE.
- REFER TO PLUMBING FIXTURE SCHEDULE FOR SANITARY
 VENT ROUGH—IN PIPE SIZE. MINIMUM SANITARY VENT
 BRANCH SIZE (EXCEPT AS NOTED) FOR THIS FIXTURE
- REFER TO PLUMBING FIXTURE SCHEDULE FOR FIXTURE DRAIN ROUGH—IN PIPE SIZE. MINIMUM FIXTURE DRAIN AND TRAP SIZE (EXCEPT AS NOTED) FOR THIS FIXTURE
- REFER TO PLUMBING FIXTURE SCHEDULE FOR WATER PIPING ROUGH—IN PIPE SIZE. MINIMUM WATER SUPPLY BRANCH SIZE (EXCEPT AS NOTED) FOR THIS FIXTURE.
- * WATER HAMMER ARRESTOR INLET; REFER TO ARRESTOR SCHEDULE FOR SIZE. LOCATION SHOWN HERE FOR INDIVIDUAL FIXTURE WILL VARY WHERE INCLUDED AS PART OF PLUMBING CHASE BATTERY OF PIPING. REFER TO RISER DIAGRAMS FOR MANIFOLD LOCATIONS. ARRANGE ALL WATER LINES TO GRAVITY DRAIN.
- WALL CLEANOUTS SHALL BE PROVIDED AT ALL END OF BATTERY OR END OF BRANCH LINE FIXTURES AND WHERE REQUIRED BY PLUMBING CODE OFFICIALS TO ASSURE
- SANITARY VENT PIPES SHALL CONTINUE TO CEILING OR HEADER TOGETHER AT MINIMUM 42" ABOVE FINISHED FLOOR.
- TRAP PRIMER LINE; SEE PLUMBING DETAILS SHEET. EXTEND AND CONNECT TO FLOOR DRAIN TRAP AS SHOWN.
- (9) AIR GAP FITTING; PROVIDE WHERE REQUIRED BY CODE.

COMPLETE ACCESS TO ALL PORTIONS OF DRAIN.

WATER HAMMER ARRESTOR SCHEDULE						
* P.D.I. SYMBOL	FIXTURE UNITS	SIZE				
A	1–11	1/2" NPT				
B	12-32	3/4" NPT				
©	33–60	1" NPT				
D	61–113	1 1/4" NPT				
E	114–154	1 1/2" NPT				
⟨F⟩	155-330	2" NPT				

PIPING RISER DIAGRAMS/TYPICAL RISER DETAILS ILLUSTRATE WATER HAMMER ARRESTORS FOR FIXTURE WATER PIPE OPENINGS. ALL ARRESTORS SHALL BE SIZED AS INDICATED ON DRAWINGS OR IN ACCORDANCE WITH THIS SCHEDULE, WHICHEVER PLACES THE MOST STRINGENT REQUIREMENT.


PROVIDE ARRESTORS IN ACCORDANCE WITH THE REQUIREMENTS OF PLUMBING DRAINAGE INSTITUTE (PDI) STANDARD PDI—WH—201. THE USE OF AIR CHAMBERS SHALL NOT BE ACCEPTABLE.


WATER HAMMER ARRESTORS SHALL HAVE LIFETIME WARRANTY AND SHALL BE CERTIFIED BY THE MANUFACTURER AS SUITABLE FOR INSTALLATION WITHOUT A REQUIREMENT FOR ACCESS PANELS. NONETHELESS, ACCESS PANELS SHALL BE PROVIDED IF AND AS REQUIRED BY THE LOCAL AUTHORITY HAVING JURISDICTION (AHJ).

PLAN MARK			ROUGH-			DESCRIPTION	
	WST &		DRAIN	CW	HW		
WATER CLOSET WC−1	4"	2"	4"	1"		AMERICAN STANDARD NO.3451.128 "MADERA" WHITE V.C. ELONGATED SIPHON JET FLOOR MTD. (1.28 GPF) BOWL WITH TOP SPUD, BOLT CAPS, OLSONITE NO.95-SS WHITE OPEN FRONT SEAT, LESS COVER AND SLOAN ROYAL 111-1.28 HET FLUSH VALVE.	
WATER CLOSET WC-2	4"	2"	4"	1"		AMERICAN STANDARD NO.3461.128 "MADERA" WHITE V.C. ELONGATED SIPHON JET FLOOR MTD. (1.28 GPF) BOWL WITH TOP SPUD, BOLT CAPS, OLSONITE NO.95-SS WHITE OPEN FRONT SEAT, LESS COVER AND SLOAN ROYAL 111-1.28 HET FLUSH VALVE.	
URINAL U-1	2"	2"	2"	3/4"		AMERICAN STANDARD No.6590.125 "WASHBROOK" WHITE V.C. UHE 0.125 TO 1.0 GPF, WITH 3/4" TOP SPUD AND WALL HANGERS. WITH SLOAN ROYAL No.MODEL 186-0.13 FLUSH VALVE. ZURN OR EQUAL FLOOR MOUNTED CARRIER. REFER TO ARCH'L PLANS FOR MOUNTING HEIGHTS.	
LAVATORY L-1 STD L-2 ADA	2"	1-1/2"	1-1/4"	1/2"	1/2"	AMERICAN STANDARD No.0355.012 WHITE V.C. LAVATORY WITH FRONT OVERFLOW AND FAUCET HOLES DRILLED ON 4" CENTERS FOR CHICAGO 802-VE2805-665ABCP, 0.5 GPM METERING FAUCET W/ PERFORATED FIXED GRID DRAIN STRAINER, P-TRAP, STOPS AND SUPPLIES. PROVIDE ZURN OR EQUAL FLOOR MOUNTED CONCEALED ARM CARRIER.PROVIDE OFFSET TAILPIECE AND INSULATION KIT FOR ADULT ADA REQUIREMENTS. WITH TMV-1. REFER TO ARCH'L PLANS FOR MOUNTING HEIGHTS.	
LAVATORY-COUNTER TOP L-3	2"	1-1/2"	1-1/4"	1/2"	1/2"	AMERICAN STANDARD NO.0476.028 WHITE VC 20 X 17 OVAL SELF RIMMING FIXTURE WITH FRONT OVERFLOW AND FAUCET HOLES DRILLED ON 4" CENTERS FOR CHICAGO 802-VE2805-665ABCP METERING FAUCET & FIXED GRID DRAIN, CHROME PLATED BRASS P-TRAP, STOPS AND SUPPLIES. PROVIDE TMV WHERE INDICATED. WITH TMV-1.	
SINK SK-1 STAFF	2"	1-1/2"	1-1/2"	1/2"	1/2"	ELKAY No. LRAD-2219-60 "LUSTERTONE" THREE HOLE PUNCH STAINLESS STEEL SINK. PROVIDE AMERICAN STANDARD No.6275.002.342V GOOSE- NECK FAUCET WITH BRASS LEVER HANDLES, AND SWING SPOUT, ELKAY No. LK-18 GRID DRAIN STRAINER, TAILPIECE, CAST BRASS P-TRAP WITH CO, STOPS AND SUPPLIES. PROVIDE OFFSET TAILPIECE AND INSULATION KIT WHERE FIXTURE TRIM IS EXPOSED. WITH REAR CENTER DRAIN.	
ELECTRIC DRINKING FOUNTAIN EDF-1 ADULT ADA W/BOTTLE FILLER	2"	2"	1-1/2"	1/2"		ELKAY LMABFTL8WSSK BARRIER-FREE, LEAD FREE WALL MOUNTED BI-LEVEL DUAL WATER COOLER, 8.0 GPH CAPACITY COOLED TO 50° F WITH 80° F AMBIENT TEMP, 1/5 HP, 4.0 FL. AMPS WIRED FOR 120V/60/1 POWER. PROVIDE ZURN OR EQUAL FLOOR MOUNTED PLATE TYPE CARRIER. PROVIDE APRON FOR SIDE ACCESS CLEARANCE AND TRAP AND SUPPLY AS NOTED BELOW. PROVIDE WITH ALL STAINLESS STEEL CABINET.	
MOP SINK MS-1	3"	2"	3"	3/4"	3/4"	FIAT TSB 100 24 X 24 X 12 WITH STAINLESS STEEL CAP AND CAULK OUTLET DRAIN WITH N.B. STRAINER. PROVIDE CHICAGO No.897-RCF WALL MOUNT FAUCET WITH INTEGRAL STOPS, WALL BRACE AND VACUUM BREAKER. PROVIDE T-35 HOSE AND WALL BRACKET AND T-40 STAINLESS STEEL MOP HANGER.	
HOSE BIBB HB-1 (TOILET ROOM FITTING)				3/4"		ZURN NO. 1330 RECESSED STAINLESS STEEL WALL BOX WITH COLD WATER WHEEL HANDLE VALVE, INTEGRAL STOP, VB AND HINGED LOCKING COVER STAMPED 'WATER' INSTALL FLUSH AND RIGID TO FINISHED WALL AND SEAL WATERTIGHT.	
ICE MAKER WALL BOX WB-1				1/2"		GUY GRAY NO. BIM-875 WITH 1/2 X 1/4 O.D. TUBE, CHROME PLATED FIXTURE SUPPLY STOP. INSTALL BOX 54" AFF BEHIND FREE STANDING REFRIGERATOR WITH ICE MAKER AND 18" AFF FOR UNDER COUNTER REFRIGERATOR OR ICE MAKER LEAVE 48" COIL OF 1/4" O.D. TYPE 'K' SOFT COPPER FOR EQUIP. CONNECTION AND PROVIDE CUNO ICEASSURE1 FILTER BRACKETED TO WALL.	
FLOOR DRAIN FD-1	3"	2"				ZURN No.ZN-415 CAST IRON DRAIN WITH 6" DIAMETER TYPE 'B' STRAINER WITH VANDAL PROOF SCREWS. SET STRAINER FLUSH WITH FINISH FLOOR. PROVIDE TRAP GUARD DEVICE.	
FLOOR DRAIN FD-2	3"	2"				ZURN No.ZN-415 CAST IRON DRAIN WITH 7" DIA. TYPE 'E' STRAINER, TRAP PRIMER CONNECTION AND 4" DIA. FUNNEL GRATE.	
ELECTRIC WATER HEATER EWH-1				SEE	PLAN	RHEEM EGSP15, 15 GALLON STORAGE WITH 2 KW ELEMENTS WIRED FOR 208 V, 1 PH. POWER; VERIFY WITH ELECTRICAL CONTRACTOR PRIOR TO ORDERING EQUIPMENT. UNIT SHALL HAVE CAPACITY OF 14 GPH RECOVERY AT 60°F. TEMPERATURE RISE PROVIDE ASME TEMPERATURE AND PRESSURE RELIEF VALVE AND THERMOMETER IN HW OUTLET PIPING. W/ET AMTROL ST-5-C.	
CIRCULATING PUMP CP-1					3/4"	GRUNDFOS MODEL UP15-18B7 ALL BRONZE, FLANGED PUMP. 1/25 HP WIRED FOR 120/60/1 POWER AND FITTED WITH REMOTE HEAT SENSING AQUASTAT CONTROLLER AND SHUT-OFF TIMER TS-1.	
TIME SWITCH TS-1						TORK ELECTROMECHANICAL 24 HOUR TIME SWITCH POWERED BY A SELF STARTING SYNCHRONOUS MOTOR. INSTALL ON WALL ADJACENT TO CIRCULATING PUMPS. COORDINATE WITH ELECTRICAL AND PROVIDE FOR 120/1/60 POWER REQUIREMENT.	
THERMOSTATIC MIXING VALVE TMV-1				1/2"	1/2"	POWERS No. LFe480 ADJUSTABLE POINT-OF-USE THERMOSTATIC MIXING VALVE, ASSE 1070 WITH INLET CHECK STOPS TO LIMIT HOT WATER TEMPERATURE TO MAXIMUM 105° F AT FAUCET OUTLET. SUPPLY CW TO MIXING VALVE FROM CW RISER TO FAUCET. INSTALL BELOW FIXTURE AND HIGH AS POSSIBLE TO PROVIDE NEAT AND CLEAN APPEARANCE.	


PLUMBING PIPE MATERIA	ALS SCHEDULE
PIPING SYSTEM	PIPING MATERIAL
SANITARY DRAINS AND VENTS INSIDE BUILDING AND BELOW GROUND	SCHEDULE 40 PVC PIPE
SANITARY DRAINS AND VENTS INSIDE BUILDING AND ABOVE GROUND	CAST IRON (SERVICE WEIGHT), NO-HUB DWV
SANITARY DRAINS AND VENTS INSIDE BUILDING AT PLENUM CEILING	CAST IRON (SERVICE WEIGHT), NO-HUB DWV
DOMESTIC HOT & COLD WATER INSIDE BUILDING AND ABOVE GROUND	COPPER, TYPE "L" HARD DRAWN
NATURAL GAS	BLACK STEEL SCHEDULE 40
FIRE SPRINKLER ABOVE GROUND - 2" AND SMALLER	BLACK STEEL SCHEDULE 40
FIRE SPRINKLER ABOVE GROUND - 2-1/2" AND LARGER	BLACK STEEL SCHEDULE 10

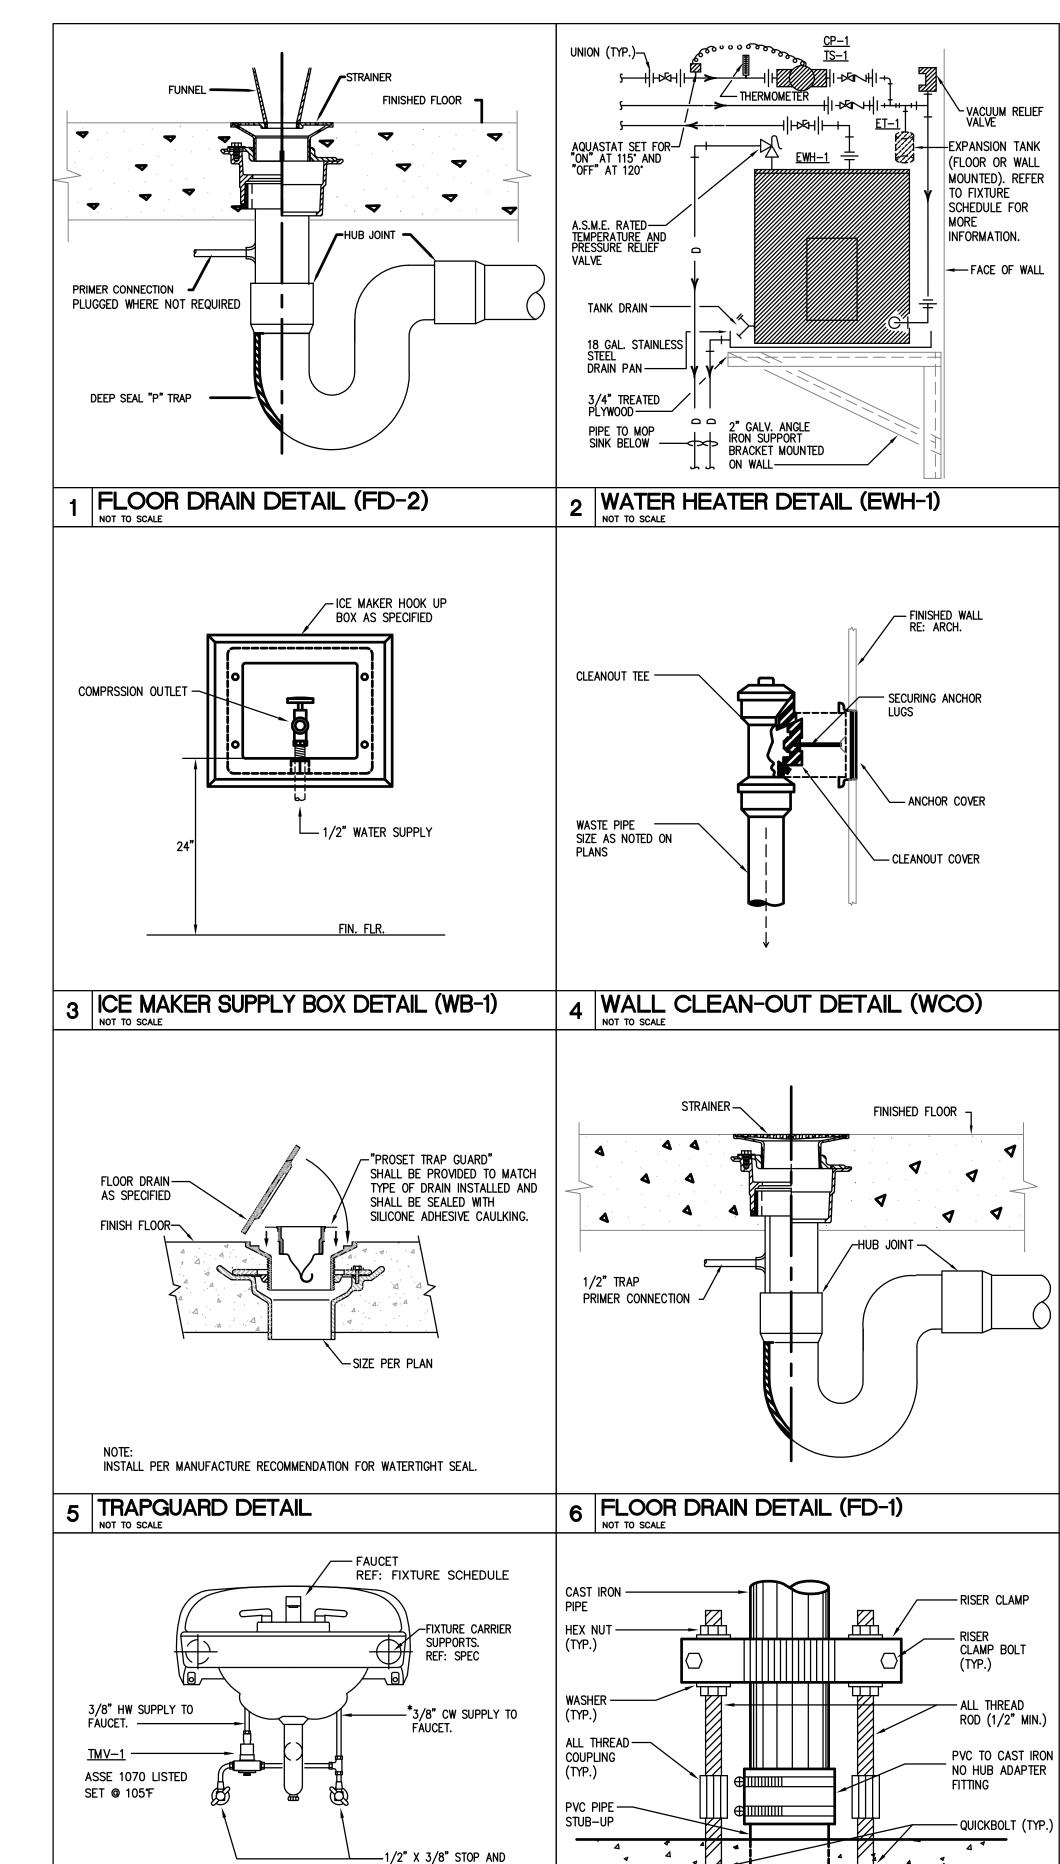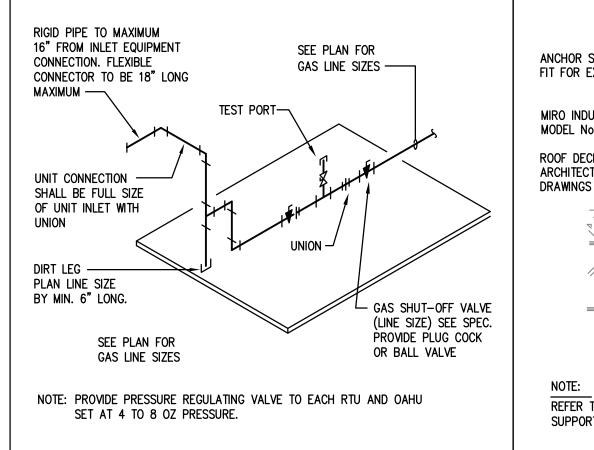NOTE: REFER TO SPECIFICATIONS FOR COMPLETE PIPING MATERIAL REQUIREMENTS FOR ASSOCIATED PIPING SYSTEMS.





9 GAS EQUIPMENT CONNECTION DETAIL

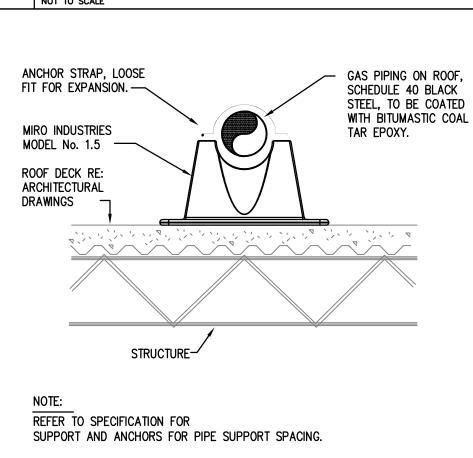

10 GAS PIPING ON ROOF DETAIL

 $_{7}$ |TMV INSTALLATION DETAIL

SUPPLY RISER

FINISHED FLOOR —

44 A A A⁴4

8 PVC TO CAST IRON SUPPORT

400 Mann Street Suite. 602 Corpus Christi, Texas 78401 361.888.5797 p 361.888.9568 f TBPE Firm Registration No. 2234

JT MG JB TL --

CONCRETE SLAB

SHEET NUMBER

P401

PLUMBING
SCHEDULES AND
DETAILS

9005.000

SET NO.

JOB NO:

REVISION:

ARCHITECTS

711 N. Carancahua, Suite 404

Corpus Christi, Texas 78401

American Bank Plaza

Phone: 361.884.7442

Fax: 361.883.1612

www.lwarchitects.com

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JEFFREY D. TABB

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ADMINIST

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KEYPLAN


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PLUMBING RISERS

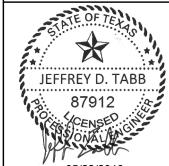189005.000 SET NO. JT MG JB TL --

DBR Project Number